

CONTAINER COFFEE SHOP

79 SOUTH MAIN STREET

PITTSTON, PA

ABBREVIATIONS

C	CENTERLINE	HVAC	HEATING VENTILATING AND AIR
(C)	PERPENDICULAR	I.D.	CONDITIONING
Ø	SQUARE	INSUL.	INSIDE DIAMETER
(E)	DIAMETER	INT.	INCH
(F)	NUMBER	INT.	INTERIOR
(N)	EXISTING	JAN	JANITOR
(R)	FUTURE	JT.	JOINT
(R)	NEW	K.O.	KNOCKOUT
(R)	RENOVATE OR RELOCATED	KIT.	KITCHEN
(R)	AT	LF	LINEAL FEET OR FOOT
A.B.	AIR CONDITIONING	L.P.	LOW POINT
A.D.A.A.G.	AMERICAN'S WITH DISABILITIES ACT	LAM.	LAMINATE
A.F.F.	ABOVE FINISH FLOOR	LAV.	LAVATORY
A.O.A.	AIRLINES OPERATION AREA	LBS	POUNDS
A.C.	AIR CONDITIONING	M.B.	MACHINE BOLT
ABV.	ABOVE	M.H.	MANHOLE
ACUST.	ACOUSTICAL	M.O.	MASONRY OPENING
ADJ.	ADJUSTABLE	MAX.	MAXIMUM
AGG.	AGGREGATE	MECH.	MECHANICAL
ALT.	ALTERNATIVE	MET.	METAL
ALUM.	ALUMINUM	MFR.	MANUFACTURER
APPROX.	APPROXIMATE	MN.	MINIMUM
ARCH.	ARCHITECTURAL	MISC.	MISCELLANEOUS
AUTO.	AUTOMATIC	MTD.	MOUNTED
AVE.	AVENUE	N	NORTH
B.O.	BOTTOM OF	N.C.	NOT IN CONTRACT
B.O.C.	BASE OF CURB	N.S.	NEAR SIDE
B.U.	BUILT UP	N.T.S.	NOT TO SCALE
BD.	BOARD	NO	NUMBER
BLDG.	BUILDING	NOM.	NOMINAL
BLK.	BLOCK	O.A.	OVER ALL
BM.	BEAM	O.C.	ON CENTER
BTM.	BOTTOM	O.D.	OUTSIDE DIAMETER
C.B.	CATCH BASIN	O.H.	OPPOSITE HAND
C.C.	CENTER TO CENTER	O.T.S.	OPEN TO STRUCTURE
C.I.	CAST IRON	Q.	OVER
C.I.P.	CAST IN PLACE	OH	OVERHEAD
C.M.U.	CONCRETE MASONRY UNIT	OFF.	OFFICE
C.O.	CONCRETE OPENING OR CLEAN-OUT	OPNG.	OPENING
C.T.	CERAMIC TILE	OPP.	OPPOSITE
CWB.	COLD WATER	OZ.	OUNCE
CAB.	CABINET	P.LAM.	PLASTIC LAMINATE
CEM.	CEMENT	P.T.D.	PAPER TOWEL DISPENSER
CFM.	CUBIC FEET/MINUTE	P.L.	PROPERTY LINE
CLG.	CEILING	PART.	PARTICLE
CLR.	CLEAR	PL.	PLATE
CNTRBUNK.	COUNTERBUNK	PLUMB.	PLUMBING
COL.	COLUMN	PLYWD.	PLYWOOD
CONC.	CONCRETE	PRE-ENG.	PRE-ENGINEERED
CONT.	CONTINUOUS	PT.	POINT
CORR.	CORRIDOR	P.M.T.	PAYMENT
CWI.	COORDINATE WITH	QT.	QUARTY
D.	DEEP	R.	RADIUS OR RISER
D.B.A.	DEFORMED BAR ANCHOR	R.D.	ROOF DRAIN
D.F.	DRAINING FOUNTAIN	R.O.	ROUGH OPENING
D.S.	DOWNSPOUT	R.W.L.	RAIN WATER LEADER
D.S.P.	DRY STANDPIPE	REF.	REFERENCE (CWI)
DET.	DETAIL	REINF.	REINFORCED
DIA.	DIAMETER	REQD.	REQUIRED
DIA.	DIAGONAL	RM.	ROOM
DIM.	DIMENSION	S.C.	SOLID CORE
DN.	DOWN	S.C.D.	SEAT COVER DISPENSER
DWG.	DRAWING	S.D.	SOAP DISPENSER
E.B.	EXPANSION BOLT	S.F.	SQUARE FEET OR FOOT
E.I.F.S.	EXTERIOR INSULATION & FINISHING SYSTEM	S.I.D.A.	SECURITY IDENTIFICATION DISPLAY AREA
E.P.	EXPANSION JOINT	S.N.D.	SANITARY NAPKIN DISPENSER
E.P.B.	ELECTRICAL PANELBOARD	S.N.R.	SANITARY NAPKIN RECEPTACLE
E.W.C.	ELECTRIC WATER COOLER	S.S.	STAINLESS STEEL
EA.	EACH	SCHED.	SCHEDULE
EL.	ELEVATION	SECT.	SECTION
ELEC.	ELECTRICAL	SHR.	SHOWER
ELEV.	ELEVATOR	SMT.	SHEET
EQ.	EQUAL	SMT.	SHEET
EQUIP.	EQUIPMENT	SMT.	SHEET
EXH.	EXHAUST	SMT.	SHEET
EXP.	EXPANSION	SMT.	SHEET
EXT.	EXTERIOR	SMT.	SHEET
F.A.	FIRE ALARM	ST.	STANDARD
F.B.	FLAT BAR	STRUC.	STRUCTURAL
F.D.	FLOOR DRAIN	SUSP.	SUSPENDED
F.E.	FIRE EXTINGUISHER	SVM.	SYMMETRICAL
F.E.C.	FIRE EXTINGUISHER CABINET	T.A.G.	TONGUE & GROOVE
F.H.C.	FIRE HOSE CABINET	T.	TREAD
F.O.	FACE OF	T.B.	TOWEL BAR
F.O.C.	FACE OF CURB/CONCRETE	T.D.	TOP OF DRAIN
F.O.F.	FACE OF FINISH	T.O.	TOP OF
F.O.M.	FACE OF MASONRY	T.O.C.	TOP OF CURB/CONCRETE
F.O.S.	FACE OF STUDS	T.O.M.	TOP OF MASONRY
F.O.T.	FACE OF TREAD	T.O.P.	TOP OF PARAPET
F.S.	FAR SIDE	T.O.S.	TOP OF SLAB
FEN.	FENESTRATION	T.O.W.	TOP OF WALL
FN.	FINISH	T.P.D.	TOILET PAPER DISPENSER
FL.	FLOORING	TEL.	TELEPHONE
FLASH.	FLASHING	THK.	THICKNESS
FT.	FOOT OR FEET	THRES.	THRESHOLD
FTG.	FOOTING	TYP.	TYPICAL
FTW.	FIRE TREATED WOOD	U.B.C.	UNIFORM BUILDING CODE
FURR.	FURRING	U.C.F.E.	UNDER COUNTER FIRE EXTINGUISHER
G.	GAS	U.D.N.	UNLESS OTHERWISE NOTED
G.B.	GRAB BAR	V.C.T.	VINYL COMPOSITION TILE
GALV.	GALVE OR GAGE	V.I.F.	VERIFY IN FIELD
GYP.	GYPSED	VENT.	VENTILATION
GYP.	GYPSED	VERT.	VERTICAL
H.	HIGH	VEST.	VESTIBULE
H.A.S.	HEADED ANCHOR STUD	W.	WIDE
H.A.S.	HEADED CONCRETE ANCHOR	W.B.	WALL BEYOND
H.B.	HOSE BIBB	W.C.	WATER CLOSET OR WALL COVERING
H.C.	HANDICAPPED - A.D.A.A.G.	W.G.	WIRE GLASS
H.M.	HOLLOW METAL	W.GL.	WIRE GLASS
H.P.	HIGH POINT	W.P.	WORK POINT
H.W.	HOT WATER	W.R.	WASTE RECEPTACLE
HORIZ.	HORIZONTAL	W.W.F.	WELDED WIRE FABRIC
HR.	HOUR	W.	WITH
HT.	HIGHT	WO.	WITHOUT
		WD.	WOOD

GENERAL NOTES

1. THE APPLICABLE BUILDING CODE IS THE 2015 INTERNATIONAL BUILDING CODE (2015 IBC).
2. THE DRAWINGS INDICATE LOCATION, DIMENSIONS, REFERENCE, AND TYPICAL DETAILS OF CONSTRUCTION. THE DRAWINGS DO NOT INDICATE EVERY CONDITION. WORK NOT PARTICULARLY DETAILED SHALL BE OF CONSTRUCTION SIMILAR TO PARTS THAT ARE DETAILED.
3. DO NOT SCALE DRAWINGS.
4. FIGURED DIMENSIONS TAKE PRECEDENCE OVER SCALED DRAWINGS. WHERE DISCREPANCIES OCCUR, THEY SHALL BE REPORTED TO ARCHITECT FOR RESOLUTION.
5. DETAILED DRAWINGS AND LARGER SCALE DRAWINGS TAKE PRECEDENCE OVER SMALLER SCALE DRAWINGS.
6. CONCRETE AND BRICK DIMENSIONS ARE GIVEN TO THE FACE OF CONCRETE OR MASONRY AND TO THE FACE OF ROUGH OPENINGS.
7. PARTITION DIMENSIONS ARE GIVEN TO THE FACE OF STUD UNLESS OTHERWISE NOTED.
8. DOOR OPENING LOCATIONS ARE DIMENSIONED TO ROUGH OPENING OR CENTERLINE OF OPENING.
9. WHERE NO MATERIAL NOTES OCCUR, THE GRAPHIC MATERIAL INDICATION SHALL INDICATE MATERIAL TYPES AND ITEMS.
10. SEE SYMBOL AND MATERIALS LIST ON THIS SHEET.
11. THE U. S. ENVIRONMENTAL PROTECTION AGENCY MUST BE NOTIFIED 10 WORKING DAYS IN ADVANCE FOR ALL RENOVATIONS THAT DISTURB 260 L.F. /160 SQ. FT. /35 CU. FT. OF ASBESTOS CONTAINING MATERIALS.
12. ALL NEW CONSTRUCTION TO COMPLY WITH THE 2009 ICC A117.1 ACCESSIBLE AND USEABLE BUILDING AND FACILITIES.
13. PROVIDE LANDINGS AND FLOOR LEVELS AT DOORS THAT COMPLY WITH THE 2015 IBC SECTION 1003.5/1010.1.6/1010.1.7.
14. UNLESS OTHERWISE INDICATED ALL DRAWINGS, NOTES WHICH DO NOT READ "N.I.C.", "EXISTING", OR "EXISTING TO REMAIN", OR "BY OTHERS" SHALL INDICATE NEW WORK WHICH SHALL BE CONTRACTOR FURNISHED AND CONTRACTOR INSTALLED.
15. ALL MATERIALS SHALL BE INSTALLED IN ACCORDANCE WITH THE MANUFACTURER'S RECOMMENDATIONS AND SPECIFICATIONS.
16. THE CONTRACTOR(S) SHALL KEEP ALL AREAS OF CONSTRUCTION CLEAN AND FREE OF DEBRIS. AFTER CONSTRUCTION IS COMPLETE, THE GENERAL CONTRACTOR SHALL PROVIDE FINAL CLEAN UP.
17. THE CONTRACTOR SHALL VERIFY ALL EXISTING CONDITIONS AND DIMENSIONS FOR ACCURACY PRIOR TO COMMENCING WITH THE WORK. ANY DISCREPANCY SHALL BE BROUGHT TO THE ATTENTION OF THE ARCHITECT.
18. PENETRATIONS THROUGH RATED ASSEMBLIES SHALL BE FIRE STOPPED IN ACCORDANCE WITH 2015 IBC SECTION 714.3.1.1 AND 714.3.1.2. PROVIDE A FIRESTOPPING SYSTEM APPROPRIATE FOR THE WORK BEING PERFORMED. PAINTABLE SEALANT SHALL BE PROVIDED AT ALL EXPOSED AREAS. PROVIDE COPIES OF THE SPECIFIC FIRE-STOP SYSTEMS PROPOSED FOR USE IN THIS PROJECT AT PENETRATIONS OF ONE-HOUR WALLS OR TWO-HOUR SHAFTS AND FLOOR ASSEMBLIES. FOR APPROVAL AND INSPECTION USE BY THE FIRE AND STRUCTURAL INSPECTORS. ASSEMBLIES SHALL SHOW ALL REQUIRED COMPONENTS AND METHOD OF INSTALLATION TO PROVIDE THE REQUIRED FIRE-STOP RATINGS AS SYSTEM BEING PENETRATED.
19. THIS SPACE MAY NOT BE OCCUPIED UNTIL IT RECEIVES A CERTIFICATE OF OCCUPANCY AND FIRE DEPARTMENT APPROVAL.
20. CONTRACTOR SHALL NOT CORE DRILL WITHOUT VERIFYING LOCATION OF CONCRETE REINFORCING.
21. THE CONTRACTOR IS RESPONSIBLE FOR ALL PERMITS AND FEES NECESSARY TO EXECUTE THE INTENT OF THESE CONSTRUCTION DOCUMENTS.
22. EXIT SIGNAGE SHALL BE EXTERNALLY OR INTERNALLY ILLUMINATED BY THE PREMISES' WIRING, STORAGE BATTERIES AND, BE IN COMPLIANCE WITH 2015 IBC SECTION 1025.
23. PROVIDE BLOCKING AS REQUIRED FOR ALL AREAS TO RECEIVE MILLWORK AND WALL-ATTACHED ITEMS AS SHOWN IN PLANS.
24. ALL EXITS SHALL BE OPENABLE FROM THE INSIDE WITHOUT THE USE OF A KEY OR ANY SPECIAL KNOWLEDGE OR EFFORT. 2015 IBC, SECTION 1010.1.9.
25. EXIT WAYS SHALL BE ILLUMINATED. THE POWER SUPPLY FOR EXIT ILLUMINATION SHALL NORMALLY BE PROVIDED BY THE PREMISES' WIRING SYSTEM, 2015 IBC SECTION 1008.
26. COORDINATE MECHANICAL AND ELECTRICAL REQUIREMENTS, ROUTING, AND FIELD VERIFICATION.
27. WHERE NEW CONSTRUCTION JOINS WITH EXISTING CONSTRUCTION, ALIGN FINISHED SURFACE OF NEW CONSTRUCTION WITH EXISTING CONSTRUCTION.
28. PROVIDE COPY OF FIRE-RESISTANCE RATING ASSEMBLIES TO THE STRUCTURAL INSPECTOR FOR VERIFICATION OF TESTING/LISTING COMPLIANCE AND TO INSPECT ASSEMBLY CONSTRUCTION THEREWITH.
29. COORDINATE CONSTRUCTION ACTIVITIES WITH OWNER.
30. FIRE SPRINKLER AND ALARM MODIFICATIONS REQUIRE SEPARATE APPLICATION AND PLAN SUBMITTALS PRIOR TO PERFORMING WORK. ALL LIFE-SAFETY FEATURES SHALL BE APPROVED BY THE FIRE AND STRUCTURAL INSPECTORS PRIOR TO OCCUPANCY.
31. ALL CONSTRUCTION ADDENDA, CHANGE ORDERS, OR DESIGN CLARIFICATIONS TO THOSE ITEMS REGULATED BY THE CODES MUST BE SUBMITTED TO THE FIELD INSPECTOR FOR REVIEW AND APPROVAL PRIOR TO COMMENCING WITH ANY OF THE PROPOSED WORK RELATED TO THE PROPOSED FIELD CHANGE.
32. SUSPENDED CEILING SYSTEMS TO BE INSTALLED IN ACCORDANCE WITH 2015 IBC SECTION 808.1.1.1 AND ASTM C 635 AND ASTM C 636.
33. ALL INSULATION MATERIALS SHALL COMPLY WITH 2015 I.B.C. SECTION 720.
34. HANDLES, PULLS, LATCHES, LOCKS, AND OTHER OPERABLE PARTS ON ACCESSIBLE DOORS SHALL HAVE A SHAPE THAT IS EASY TO GRASP WITH ONE HAND AND DOES NOT REQUIRE TIGHT GRASPING, PINCHING, OR TWISTING OF THE WRIST TO OPERATE. SUCH HARDWARE SHALL BE AT 34" MINIMUM AND 48" MAXIMUM ABOVE THE FLOOR OR GROUND. 2015 I.B.C. SECTION 1008.1.9.
35. COMBUSTIBLE MATERIALS SHALL NOT BE USED IN CONCEALED SPACES UNLESS EVIDENCE OF COMPLIANCE WITH 2015 I.B.C. SECTION 717.5 IS PROVIDED TO THE STRUCTURAL INSPECTOR FOR REVIEW AND APPROVAL.
36. DECORATIVE MATERIALS AND TRIM SHALL BE RESTRICTED BY COMBUSTIBILITY AND THE FLAME PROPAGATION PERFORMANCE CRITERIA OF NFPA 701. IN ACCORDANCE WITH 2015 I.B.C. SECTION 806, CONTRACTOR SHALL HAVE CERTIFICATE OF COMPLIANCE FOR DECORATIVE MATERIALS AND TRIM, INDICATING COMPLIANCE WITH THIS CODE SECTION AS APPLICABLE TO THIS PROJECT AVAILABLE AT PROJECT SITE.
37. CONTRACTOR SHALL HAVE AVAILABLE AT THE JOB SITE EVIDENCE OF CODE COMPLIANCE OF RATING OF WALL AND CEILING FINISH MATERIALS AT CONSTRUCTION SITE FOR REVIEW BY FIRE AND STRUCTURAL FIELD INSPECTORS IN ACCORDANCE WITH 2015 I.B.C. SECTION 803 AND TABLE 803.1.1.
38. ACCESS TO MECHANICAL APPLIANCES INSTALLED IN UNDER-FLOOR AREAS, IN ATTIC SPACES AND ON ROOFS OR ELEVATED STRUCTURES SHALL BE IN ACCORDANCE WITH THE INTERNATIONAL MECHANICAL CODE.
39. CONTROLS, OPERATING MECHANISMS AND HARDWARE INTENDED FOR OPERATION BY THE OCCUPANT, INCLUDING SWITCHES THAT CONTROL LIGHTING AND ACCESSIBLE. VENTILATION AND EXHAUST SYSTEMS SHALL BE PROVIDED AS REQUIRED BY THE INTERNATIONAL MECHANICAL CODE AND THE INTERNATIONAL FIRE CODE.

CONTACT INFORMATION

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MATERIALS & SYMBOLS

	REVISION KEY RE: REVISED BOX IN TITLE BLOCK OF CURRENT PAGE		INTERIOR ELEVATIONS SEE DWG. #1 @ SHT. 151, 152, 153
	PROPERTY LINE		ROOM NAME ROOM NUMBER
	BUILDING GRID LINE		WINDOW TYPE, RE: A82 WINDOW TYPES
	STRUCTURE CENTERLINE		DOOR NUMBER, RE: A82 DOOR SCHEDULE
	ELEVATION POINT		MATERIAL FINISH, RE: A81 & B1 FINISH SCHEDULE
	DRAWING MATCH LINE		RELATED SPECIFICATION DIVISION RELATED SPECIFICATION SECTION SHEET NOTE, RE: SHEET NOTES LIST ON CURRENT PAGE SHEET NOTE
	BUILDING SECTION MARK REF. (SEE DWG. #1 @ SHT. A61)		WALL TYPE, RE: A21 FOR WALL TYPES WITH VARIABLE HEIGHT, SEE TOP OF WALL ELEVATION
	WALL SECTION MARK REF. (SEE DWG. #1 @ SHT. A63)		ACCESSORY/FIXTURE TYPE, RE: A42
	DETAIL REFERENCE (SEE DWG. #1 @ SHT. A71)		DETAIL SECTION MARK

PROJECT INFORMATION



PROJECT ADDRESS:	79 S MAIN ST. PITTSBURGH, PA 15604
CONSTRUCTION TYPE:	TYPE II B
OCCUPANCY GROUP:	B, R-3
ZONING:	CBD, ROD
APPLICABLE CODES:	

- 2015 INTERNATIONAL BUILDING CODE
- 2015 INTERNATIONAL PLUMBING CODE
- 2015 INTERNATIONAL FUEL GAS CODE
- 2015 INTERNATIONAL MECHANICAL CODE
- 2015 INTERNATIONAL FIRE CODE
- 2015 INTERNATIONAL ENERGY CONSERVATION CODE
- 2017 NATIONAL ELECTRIC CODE
- 2009 ICC A117.1 ACCESSIBLE AND USABLE BUILDINGS AND FACILITIES
- UCC OF PENNSYLVANIA

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MECHANICAL	
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E1.0	ELECTRICAL PLANS - POWER
E2.0	ELECTRICAL PLAN - LIGHTING
EN0	COMCHECK COMPLIANCE SHEETS
EN1	COMCHECK COMPLIANCE SHEETS

VICINITY MAP

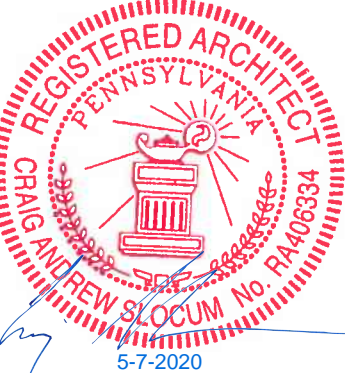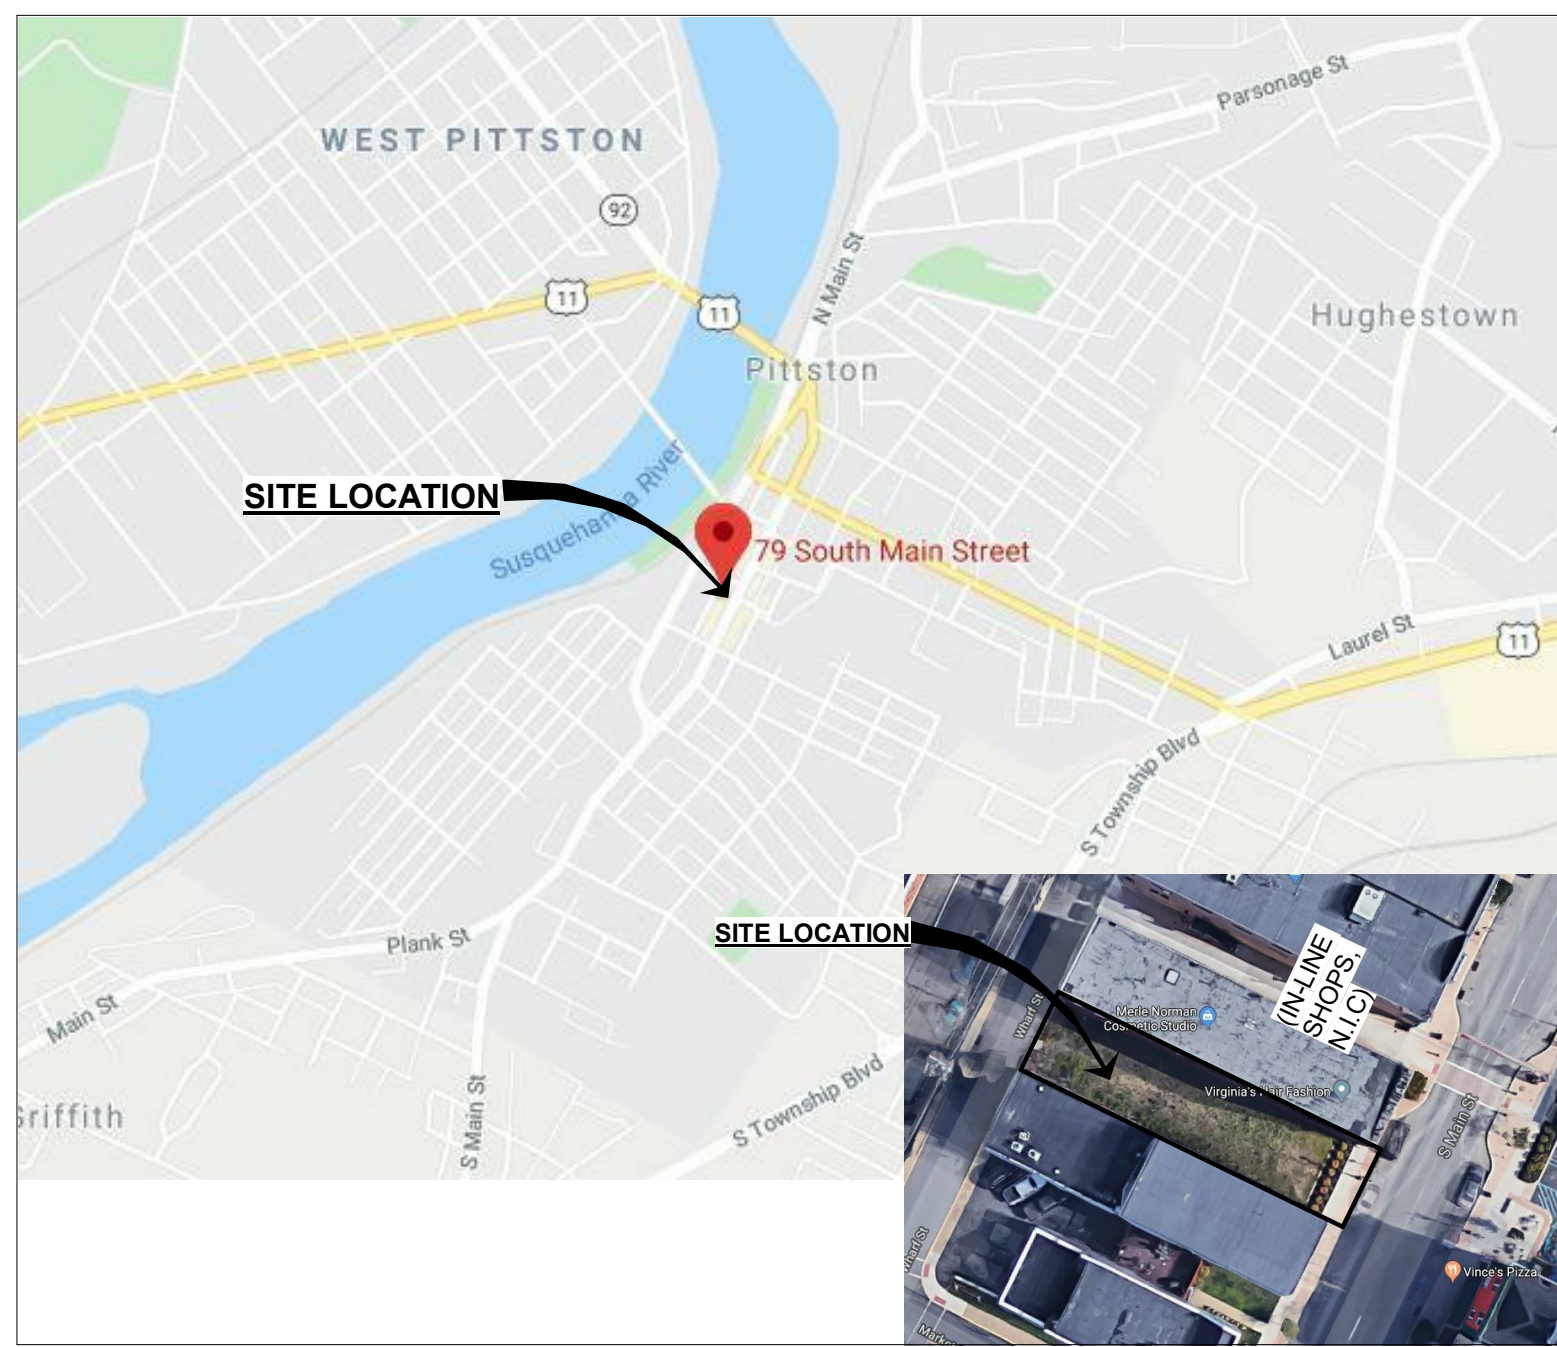

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PITTSBURGH, PA
79 SOUTH MAIN STREET

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AGENCY SET

PROJECT	DATE
19176	05-07-2020
DRAWN	CHECKED
LMV	JSG / CAS

REVISED


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TITLE SHEET


SHEET

G00

ORIGINAL SHEET SIZE
24" x 36"

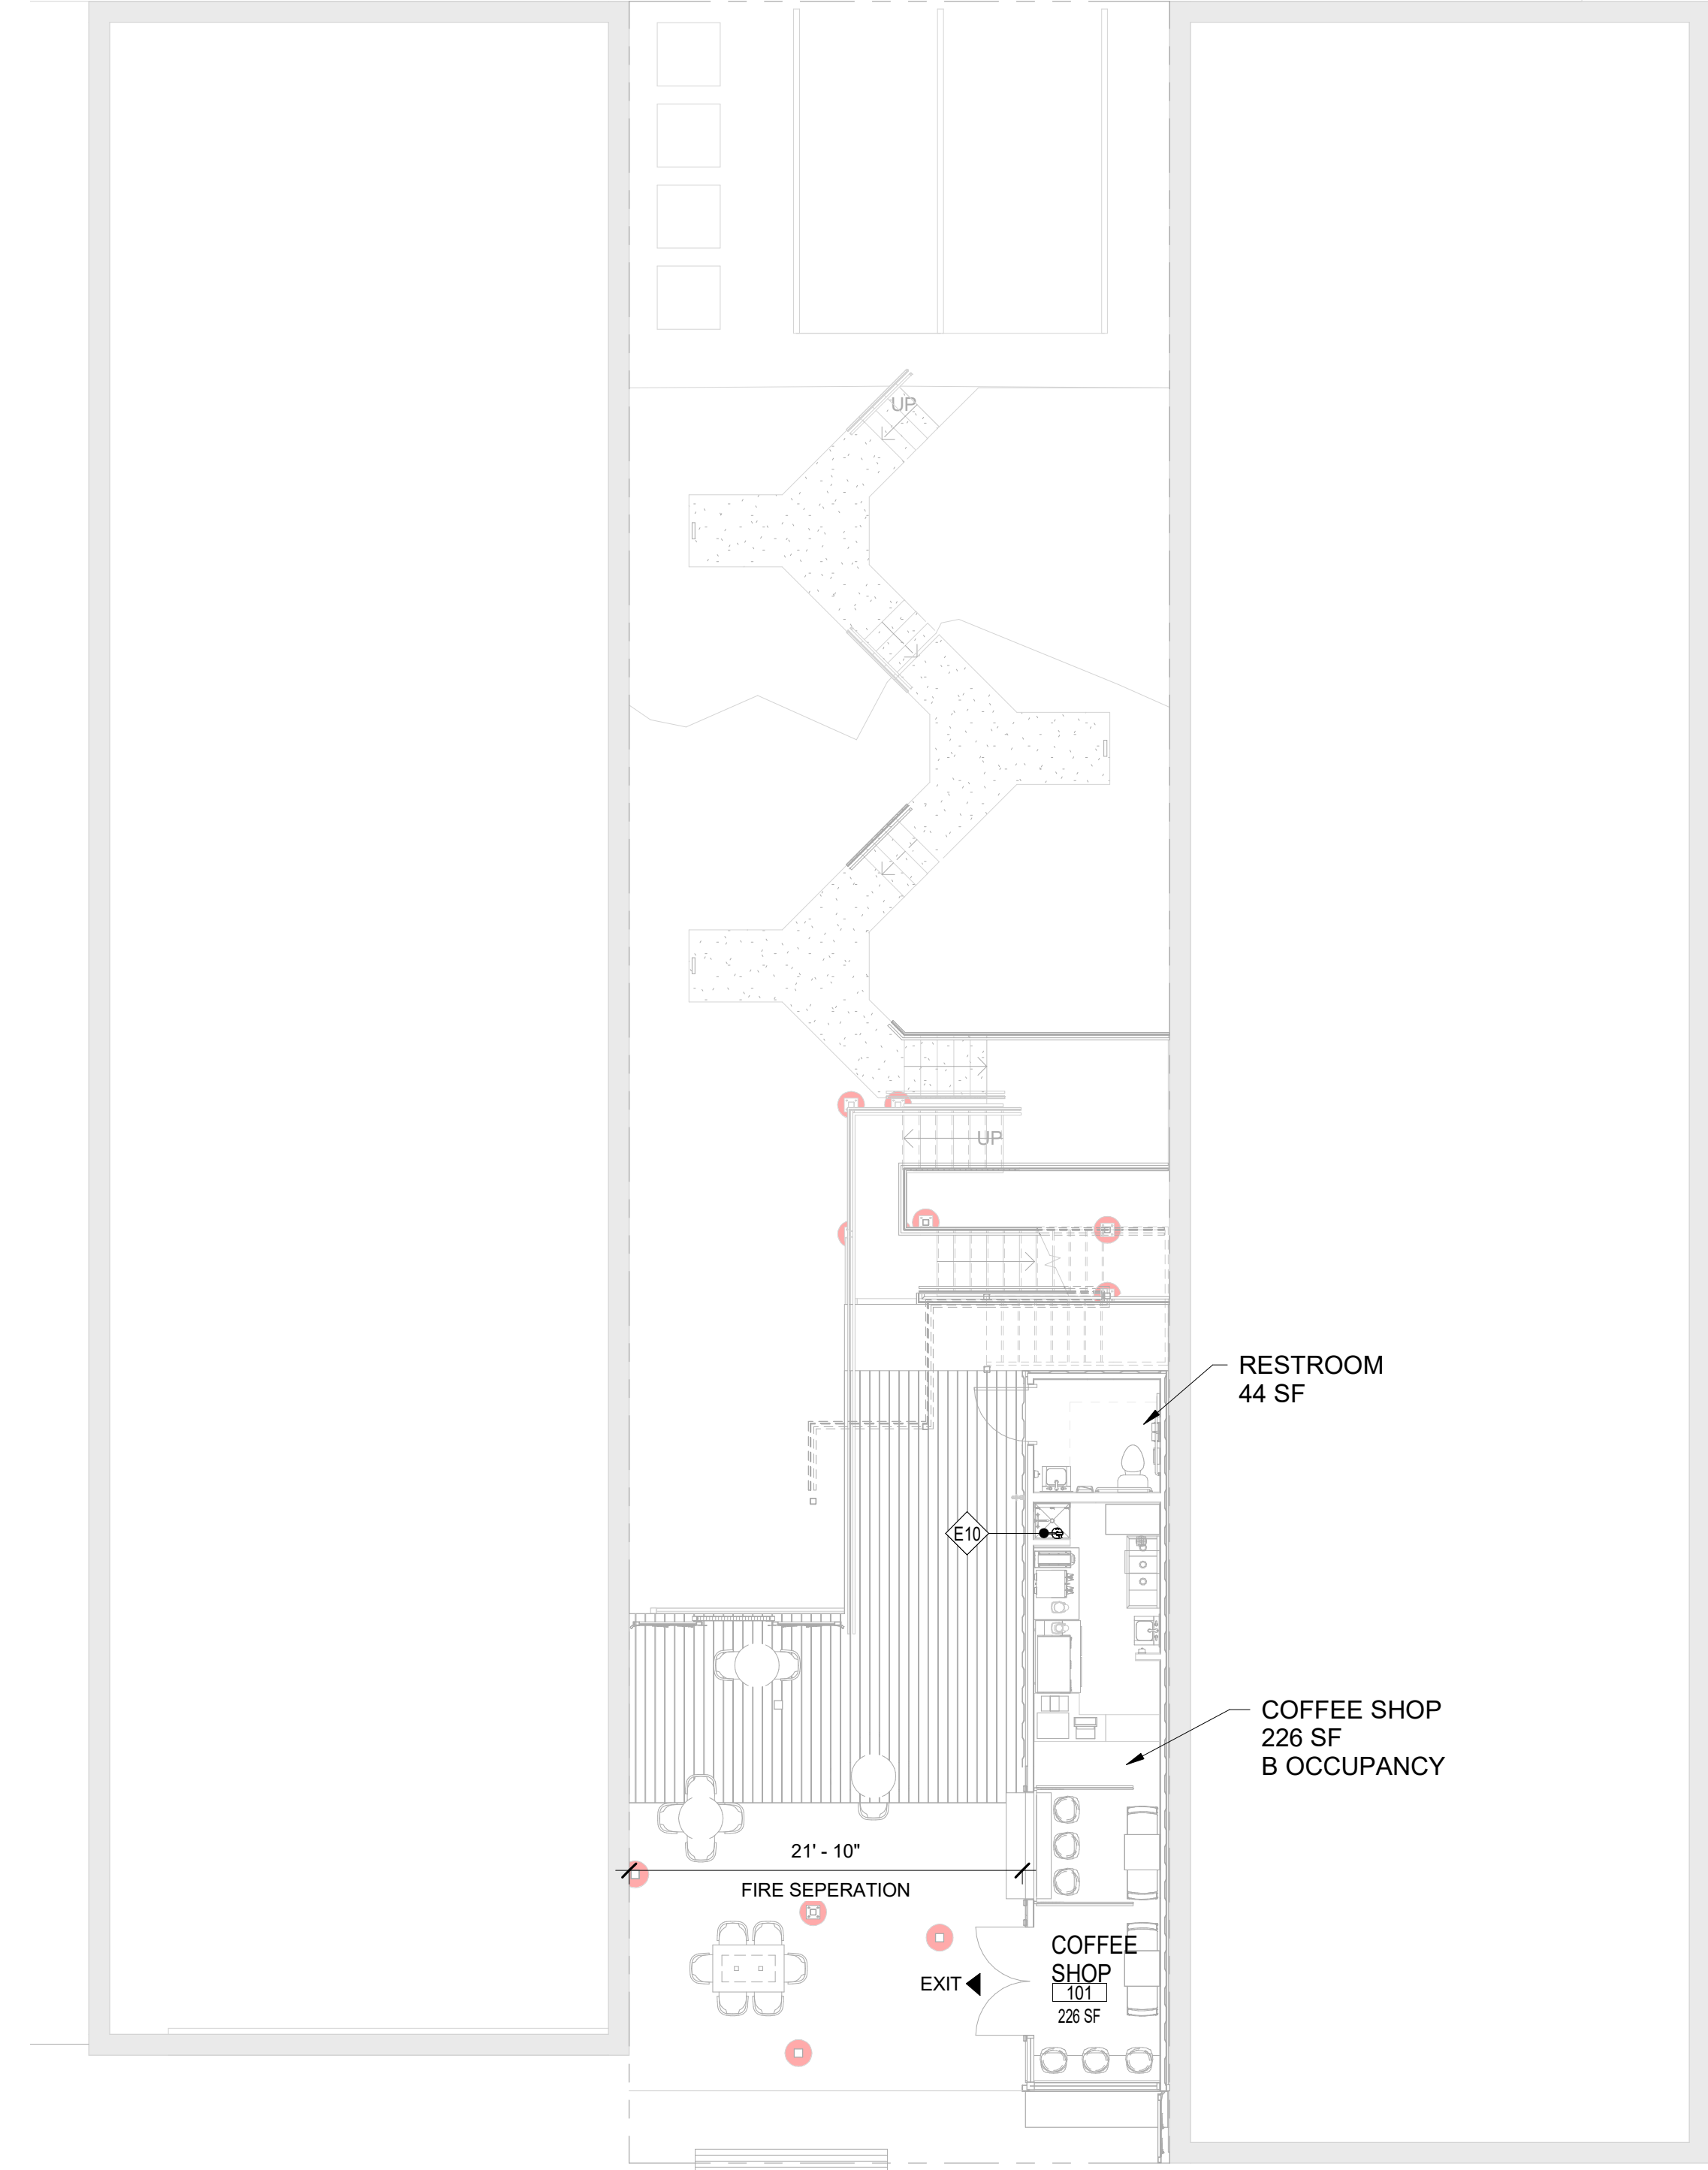

1 CODE PLAN - COFFEE SHOP
1/8" = 1'-0"

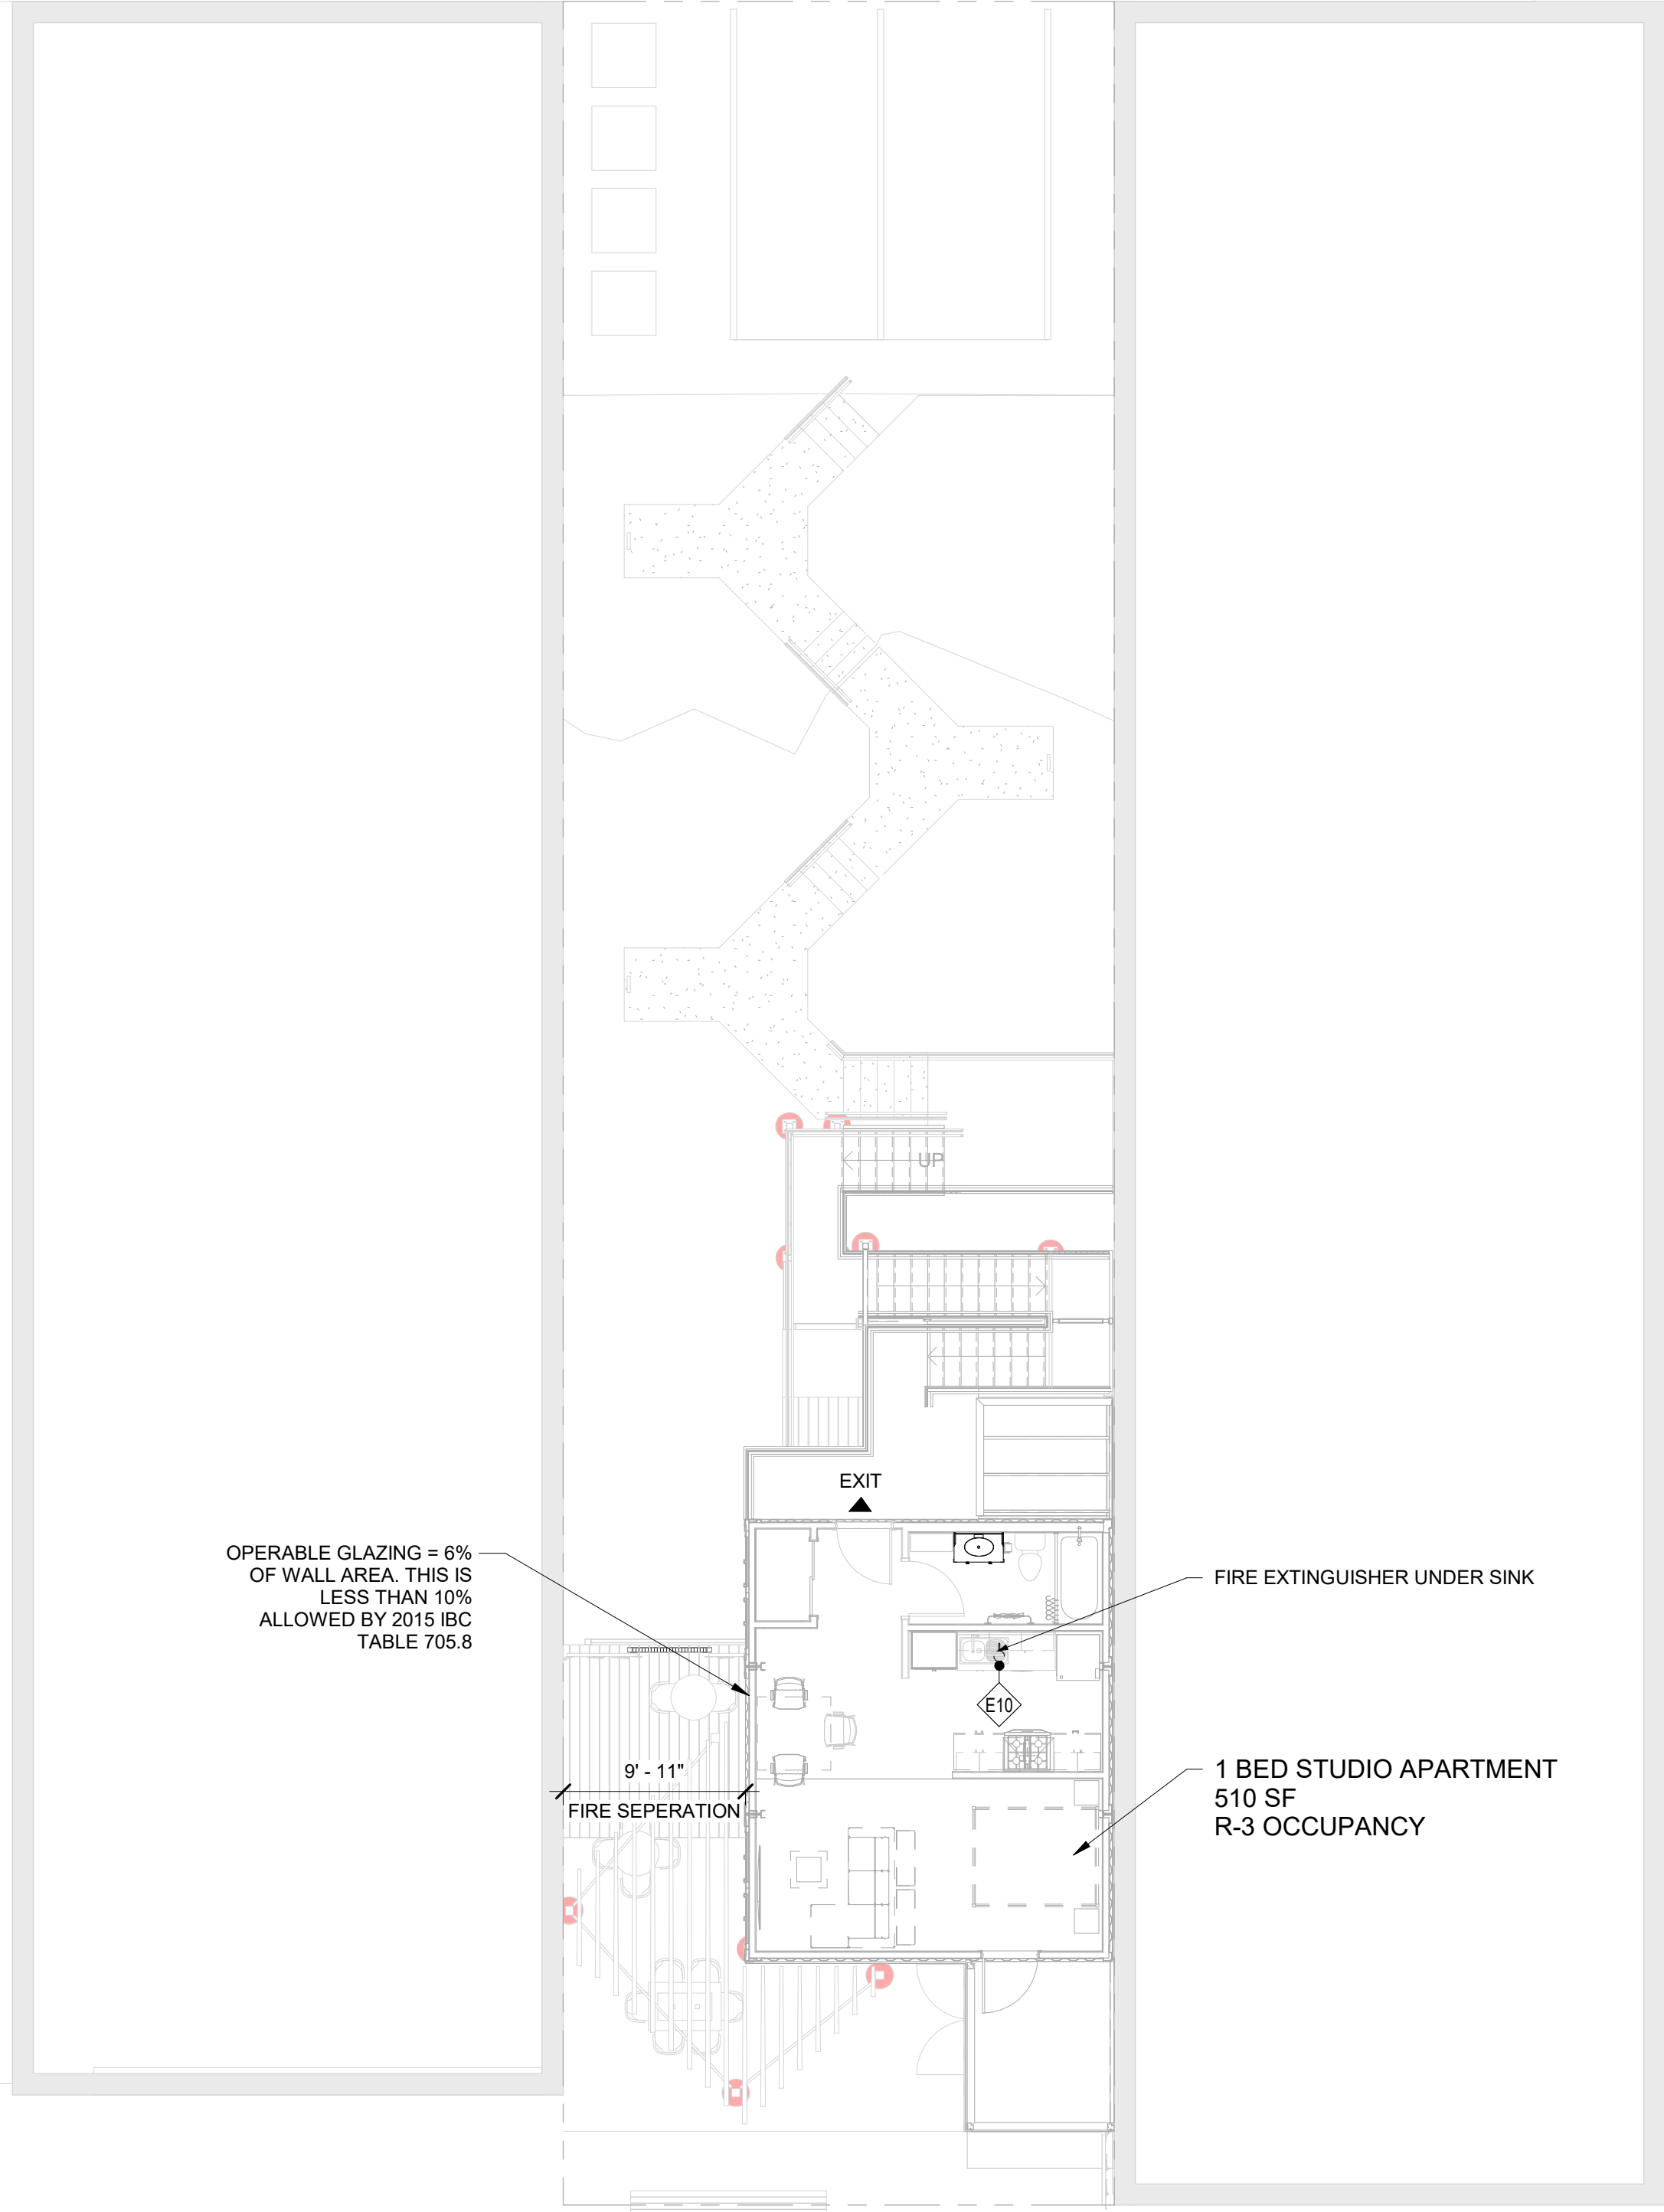

2 CODE PLAN - APARTMENT
1/8" = 1'-0"

ENERGY CODE REQUIREMENTS	
CLIMATE ZONE: 5A (LUZERNE COUNTY, PA) PER 2015 IECC C301.1	
REQUIRED R VALUES:	
ROOF - METAL BUILDING:	R-19 + R-11 LS.
WALLS - METAL BUILDING:	R-13 + R-13dL
FLOOR - SLAB ON GRADE (UNHEATED):	R-10 (FOUNDATION)

PLUMBING FIXTURES PER 2015 IBC CHAPTER 29 TABLE 2902.2.1					
OCCUPANCY	OCCUPANT LOAD	UNISEX WATER CLOSET	UNISEX LAV.	DRINKING FOUNTAINS	SERVICE SINKS
B	12	NOTE A	NOTE A	NOTE B	1
R-3	3	1	1	N/A	N/A

LEGEND

EXIT

REQUIRED EXIT

FIRE EXTINGUISHER, RE: SPECIALTY EQUIPMENT SCHEDULE: E10

GENERAL NOTES

CODE DATA:
PER 2015 INTERNATIONAL BUILDING CODE

DESCRIPTION:	NEW BUILDING (R-3)	NEW BUILDING (A-2)
CONSTRUCTION TYPE:	TYPE II B	TYPE II B
OCCUPANCY:	GROUP R-3: PER IBC SECTION 303.1.1 PER IBC SECTION 306.2	GROUP A-2: PER IBC SECTION 303.1.1 PER IBC SECTION 306.2
AREA:	2ND FLOOR: 480 GSF TOTAL: 800 GSF	1ST FLOOR: 320 GSF TOTAL: 800 GSF
ALLOWABLE AREA:	R-3: UL SF	B: 23,000 SF
OCCUPANCY SEPERATION:	2 HR PROTECTION PROVIDED PER IBC TABLE 508.4	2 HR PROTECTION PROVIDED PER IBC TABLE 508.4
ALLOWABLE STORIES:	4 STORIES PER IBC TABLE 508.4	4 STORIES PER IBC TABLE 508.4
ACTUAL STORIES:	1 STORY	1 STORY
ALLOWABLE BUILDING HEIGHT:	55'-0" PER TABLE 503	55'-0" PER TABLE 503
ACTUAL BUILDING HEIGHT:	21'-0"	10'-0"

FIRE RESISTANCE RATINGS OF BUILDING ELEMENTS:

PRIMARY STRUCTURAL FRAME:	0 HOURS PER IBC TABLE 601	0 HOURS PER IBC TABLE 601
BEARING WALLS-EXTERIOR: 10'-X<30' FIRE SEPERATION:	0 HOURS PER IBC TABLE 601	0 HOURS PER IBC TABLE 602
BEARING WALLS-INTERIOR:	N/A	N/A
NONBEARING WALLS-INTERIOR:	0 HOUR PER IBC TABLE 601	0 HOUR PER IBC TABLE 601
FLOOR CONSTRUCTION:	2 HOUR - NOTE C	0 HOURS PER IBC TABLE 601
ROOF CONSTRUCTION:	0 HOUR PER IBC TABLE 601	0 HOUR PER IBC TABLE 601
MINIMUM ROOF CLASS:	N/A	CLASS B PER IBC TABLE 1505.1
FIRE WALL:	N/A	N/A
FIRE DOORS AT FIRE WALLS:	N/A	2 HOUR FIRED RATED PER IBC TABLE 706.4
PORTABLE FIRE EXTINGUISHERS:	YES	YES
AUTOMATIC SPRINKLER SYSTEM:	NO	NO
FIRE ALARM SYSTEM:	YES	YES
FIRE FLOW REQUIRED:	1,500 GPM	1,500 GPM
FIRE FLOW PROVIDED:	1,672 GPM	1,672 GPM

NOTES:

A. OCCUPANCY LOAD (INCLUDING STAFF) IS LESS THAN 15. PER IBC SECTION 2902.2.1, SEPERATE FACILITIES ARE NOT REQUIRED

B. PER IBC TABLE 2902.2.1, FOOTNOTE F, DRINKING FOUNTAINS NOT REQUIRED WITH OCCUPANCIES LESS THAN 15.

C. PER IBC TABLE 508.4, OCCUPANCY SEPERATION SHALL BE 2 HOURS

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CRAIG A. SLOCUM, ARCHITECT

AGENCY SET

PROJECT
19176

DATE
05-07-2020

DRAWN
LMV

CHECKED
JSG / CAS

REVISED

SHEET TITLE
CODE PLAN & DETAILS

SHEET
G11
ORIGINAL SHEET SIZE
24" x 36"

A detailed street map of the downtown area of Williamsport, Pennsylvania. The Susquehanna River is shown on the left side of the map. Major streets include Main St, which runs vertically through the center, and various streets running horizontally and diagonally. A specific area, bounded by Main St, Spring St, and the river, is highlighted in orange. This area contains a black rectangular marker. The map also shows the Kennedy Bridge crossing the river. Other streets labeled include William St, Broad St, Church St, and many others. The map is oriented with North at the top.

CBD ZONE

MSOD OVERLAY

ROD OVERLAY

CBD ZONE

Scale: 1" = 50'

INDEX OF SHEETS		
SHT. No.	DESCRIPTION	LATEST REVISION
1	COVER SHEET	
2	EXISTING CONDITIONS PLAN	
3	DIMENSION PLAN	
4	GRADING & UTILITIES PLAN	
5	SOIL EROSION & SEDIMENT CONTROL PLAN	
6	SOIL EROSION & SEDIMENT CONTROL DETAILS	
7	LIGHTING PLAN	
8	LANDSCAPE PLAN	
9 - 10	CONSTRUCTION DETAILS	



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State of N.J. C.O.A.: 24GA27986500

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[illegible]

MICHAEL F. GALLAGHER
PENNSYLVANIA REGISTERED PROFESSIONAL
ENGINEER - LICENSE NUMBER: PE84021


PRELIMINARY & FINAL
SITE PLAN

FOR

79 SOUTH
MAIN STREET

PARCEL #E11NE4-2-11-T

CITY OF PITTSBURGH
ALLEGANY COUNTY
PENNSYLVANIA



RED BANK OFFICE
Corporate Headquarters
331 Newman Springs Road
Suite 203
Red Bank, NJ 07701


Phone: 732.383.1950
Fax: 732.383.1984

SCALE: AS SHOWN	DATE: 4/1/2020	DRAWN BY: PCS	CHECKED BY: MFG
PROJECT NUMBER: 19003683A		DRAWING NAME: C-COVER	


SHEET TITLE:

COVER SHEET

SHEET NUMBER: 1 of 10

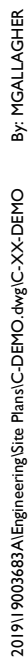



NOTE: DO NOT SCALE DRAWINGS FOR CONSTRUCTION.

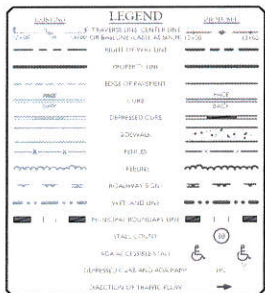


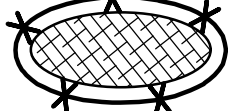




(E) = PRE-EXISTING NOW CONFORMING CONDITION
(V) = VARIANCE REQUIRED


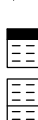


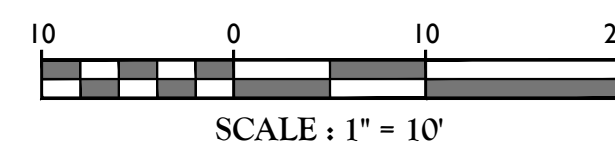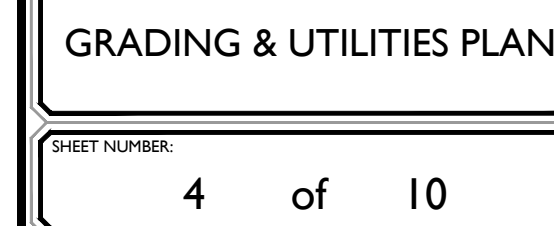







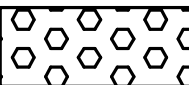


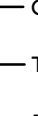

3 of 10

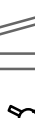NOTE: DO NOT SCALE DRAWINGS FOR CONSTRUCTION

0191 9007683 | Engineering Fire Plans | C-GRAD dw/c-04 GRADING
By MGA ILAGHER

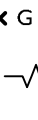

SOIL EROSION LEGEND	
PROPOSED INLET FILTER	
PROPOSED AREA OF TEMPORARY TOPSOIL STOCK PILE W/ SILT FENCE	
PROPOSED SILT FENCE/LIMIT OF DISTURBANCE	
PROPOSED LIMIT OF DISTURBANCE	
PROPOSED CONSTRUCTION ENTRANCE	
PROPOSED CONCRETE WASHOUT	

EXISTING		LEGEND	PROPOSED
$\frac{B}{12+00}$ $\frac{A}{PI}$ $\frac{C}{13+00}$		TRAVERSE LINE, CENTER LINE OR BASELINE (LABEL AS SUCH)	$\frac{B}{12+00}$ $\frac{C}{13+00}$
_____		RIGHT OF WAY LINE	_____
_____		PROPERTY LINE	_____
_____		EDGE OF PAVEMENT	_____
FACE BACK		CURB	FACE BACK
_____		DEPRESSED CURB	_____
_____		SIDEWALK	_____
X X		FENCES	X X
~~~~~		TREELINE	~~~~~
— — — — —		ROADWAY SIGNS	— — — — —
• • • • •		WETLAND LINE	• • • • •
■   ■		MUNICIPAL BOUNDARY LINE	■   ■
		'B' INLET	
		'E' INLET	
		STORM MANHOLE	
		SANITARY MANHOLE	
		FLARED END SECTION	
		HEADWALL	
		HYDRANT	
		POLE MOUNTED LIGHT	
— 74 — 75 —		CONTOURS	— 74 — 75 —
X G 29.0		SPOT ELEVATION	X G 29.0
		DIRECTION OF OVERLAND FLOW	
X TC 29.0		TOP OF CURB ELEVATION	X TC 29.0
X BC 29.0		BOTTOM OF CURB ELEVATION	X BC 29.0
		TOP OF DEPRESSED CURB ELEVATION	X TDC 29.0
CATV		CABLE TV CONDUIT	CATV
W		WATER MAIN	W
G		GAS MAIN	G
T		TELEPHONE CONDUIT	T
E		ELECTRIC CONDUIT	E
=====		SANITARY PIPE	=====
=====		STORM PIPE	=====


**MICHAEL F. GALLAGHER**  
PENNSYLVANIA REGISTERED PROFESSIONAL  
ENGINEER - LICENSE NUMBER: PE84021

## PRELIMINARY & FINAL SITE PLAN

FOR  
79 SOUTH  
MAIN STREET

PARCEL #E11NE42-11-T

CITY OF PITTSBURGH  
ALLEGHENY COUNTY  
PENNSYLVANIA

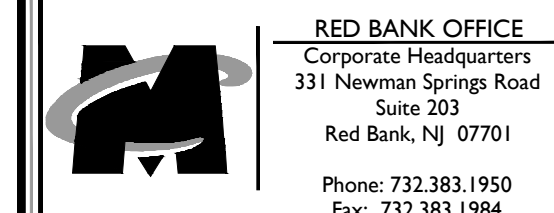


SCALE: AS SHOWN	DATE: 4/1/2020	DRAWN BY: PCS	CHECKED BY: MFG
PROJECT NUMBER: 19003683A		DRAWING NAME: C-SEFC	

SHEET TITLE:

**SOIL EROSION &  
SEDIMENT CONTROL PLAN**

SHEET NUMBER:  
5 of 10

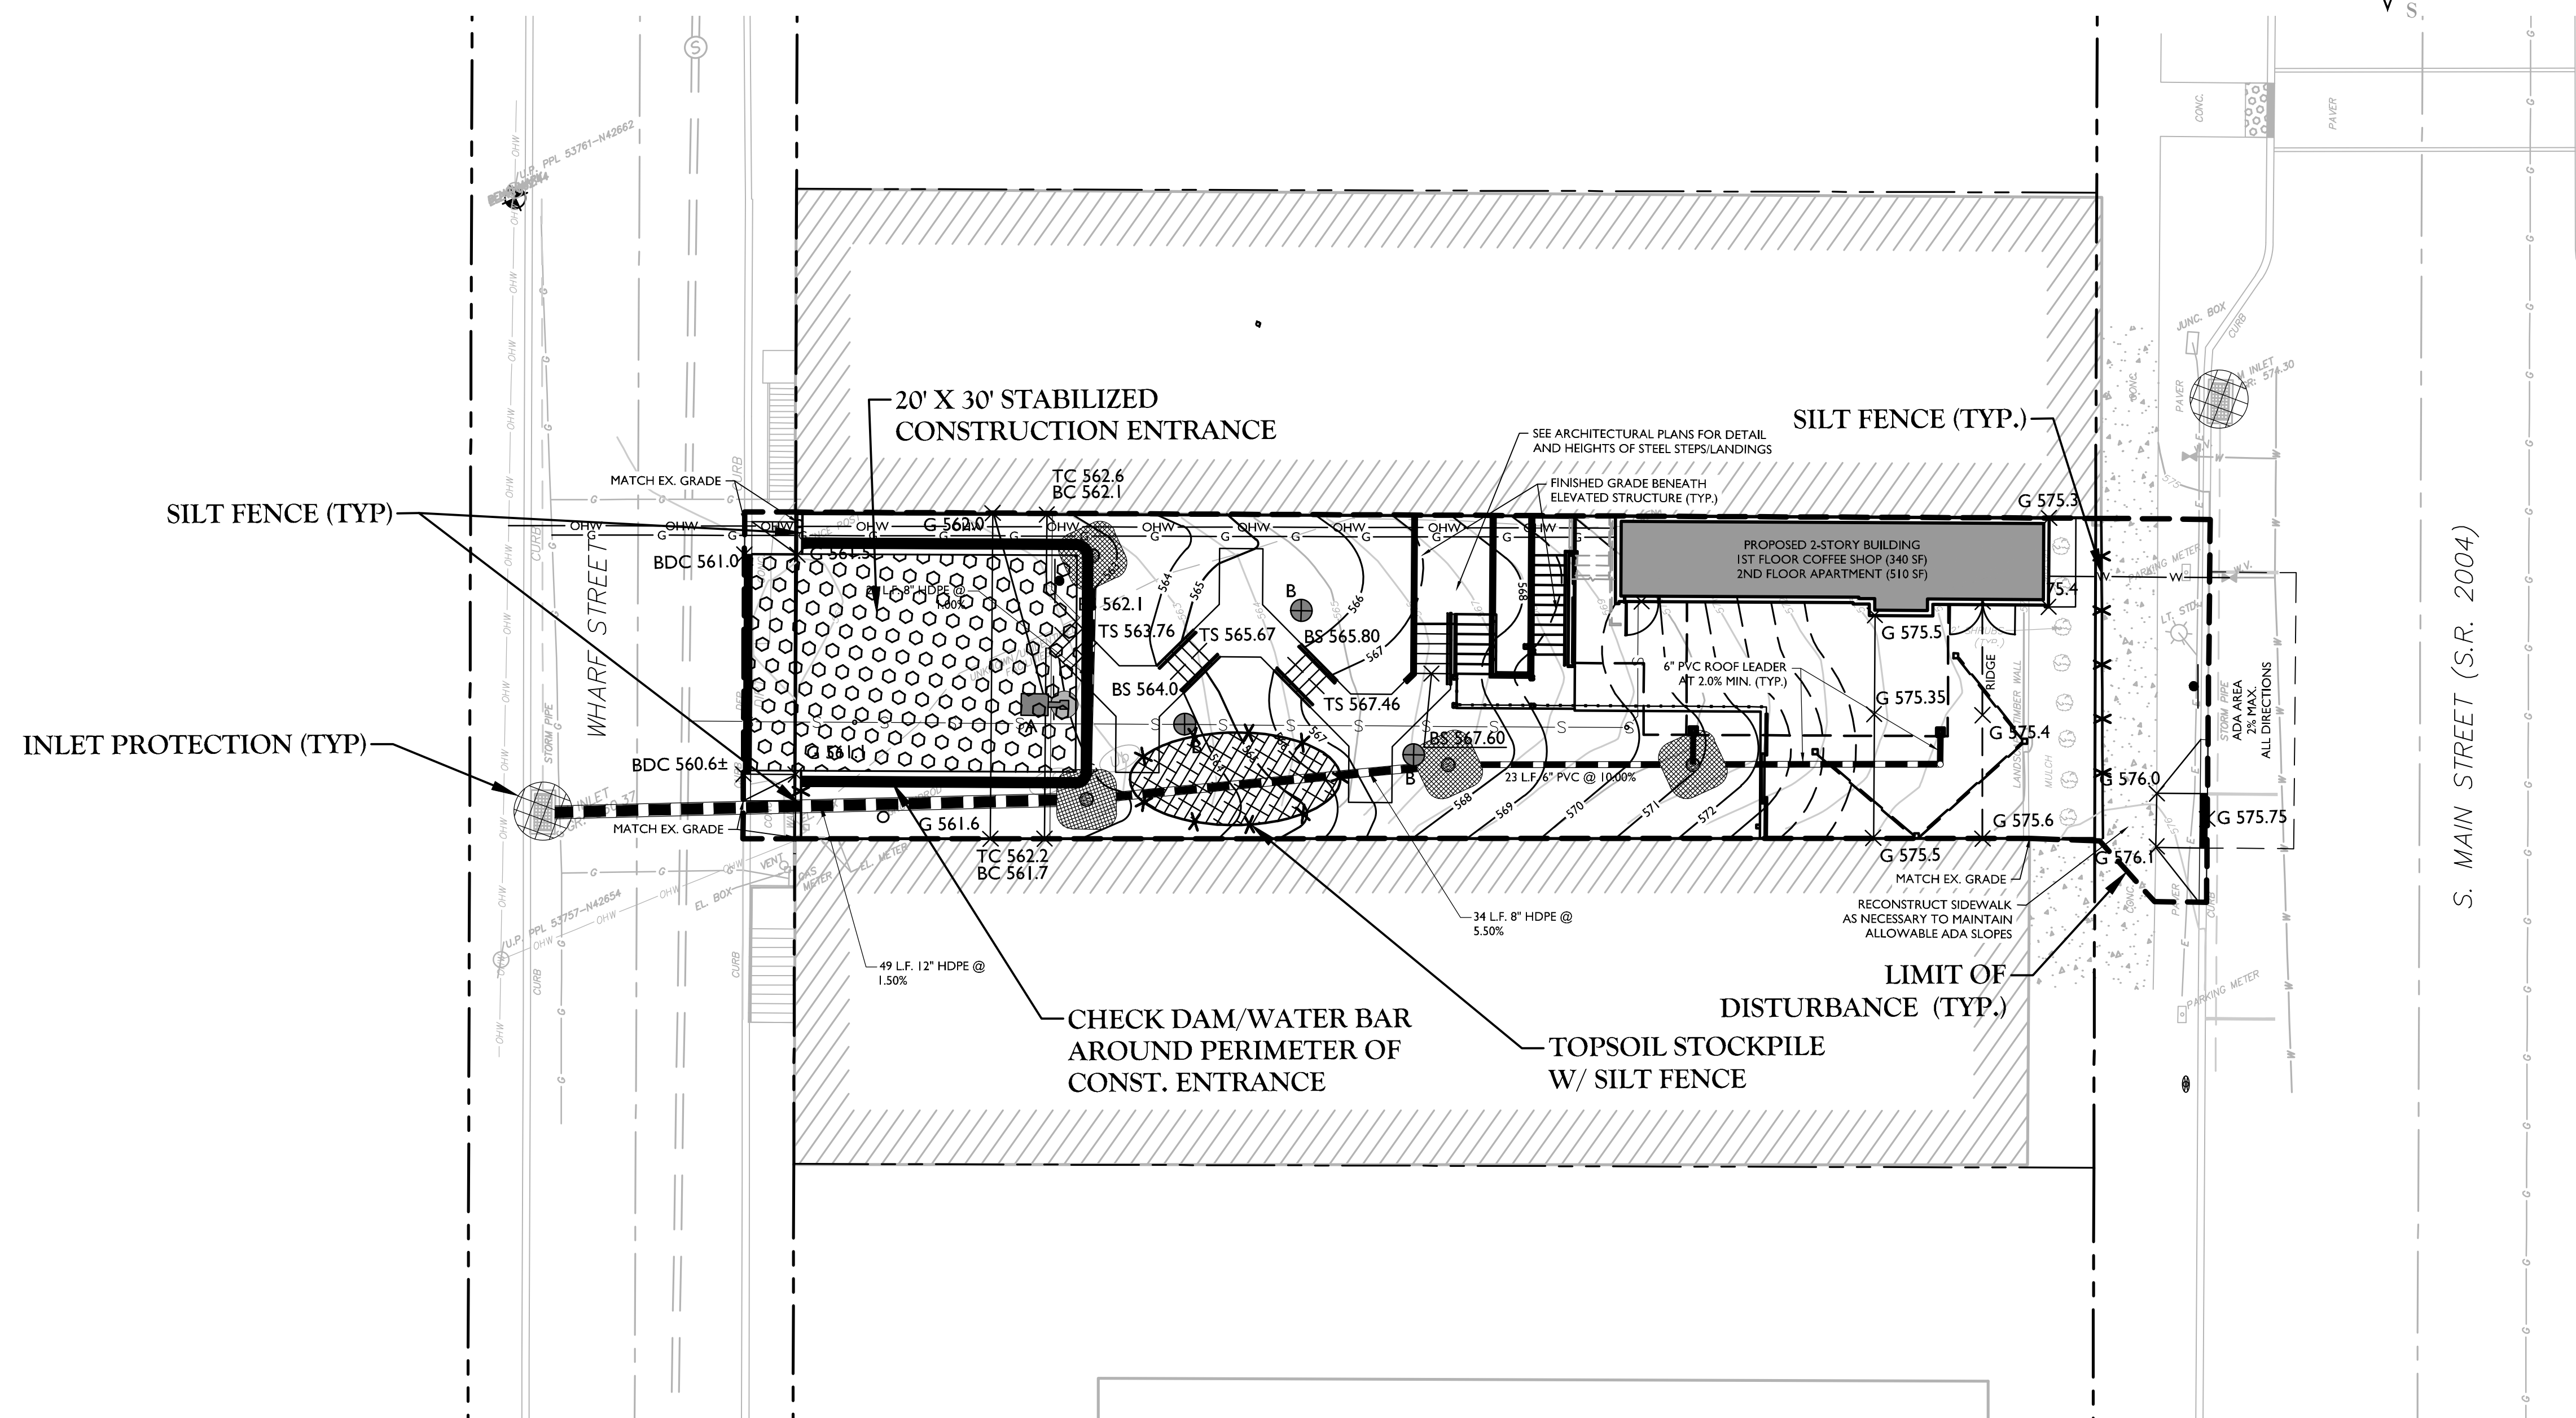


## MAINTENANCE PROGRAM

1. ALL EROSION CONTROL DEVICES WILL BE INSPECTED ON A WEEKLY BASIS AND AFTER ANY PRECIPITATION EVENT.
2. A WRITTEN REPORT DOCUMENTING EACH INSPECTION AND ALL BMP REPAIR OR REPLACEMENT AND MAINTENANCE ACTIVITY MUST BE KEPT AT THE SITE.
3. SEDIMENT WILL BE REMOVED FROM EROSION CONTROL DEVICES WHEN SEDIMENT HAS REDUCED THE EROSION CONTROL'S STORAGE CAPACITY BY 50%. SEDIMENT REMOVED FROM THE STORAGE DEVICES WILL BE PLACED IN A LOCATION THAT IS PROTECTED WITH EROSION CONTROLS AND WILL BE SEED AND MULCHED.
4. NEEDED REPAIRS OR REPLACEMENTS OF ANY EROSION CONTROL DEVICE WILL BE MADE IMMEDIATELY.
5. CONCRETE WASHOUT SHALL BE PROVIDED FOR THIS DEVELOPMENT.

## RECYCLING & DISPOSAL OF MATERIALS

1. ALL EXCESS SOIL AND ROCK MATERIAL WILL BE TAKEN TO A SITE THAT HAS BEEN APPROVED BY THE LUZERNE COUNTY CONSERVATION DISTRICT.
2. THIS SITE MUST HAVE APPROPRIATE EROSION CONTROL DEVICES IN PLACE.
3. ANY CONSTRUCTION WASTE MATERIALS WILL BE TAKEN TO A DEPARTMENT OF ENVIRONMENTAL PROTECTION APPROVED LANDFILL.
4. WHERE POSSIBLE, CONSTRUCTION MATERIALS WILL BE RECYCLED.

LIMIT OF DISTURBANCE = 4.076 SF (0.093 ACRES)

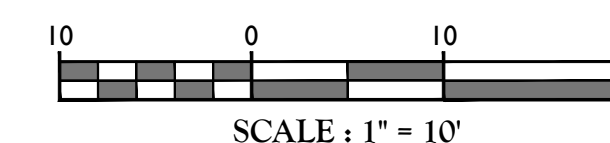

**NOTE: DO NOT SCALE DRAWINGS FOR CONSTRUCTION.**

0191 9007683 All Engineering Fire Plans C 555C Awd C 55. SOLL FROGON  
Rw MGA LLAGHER












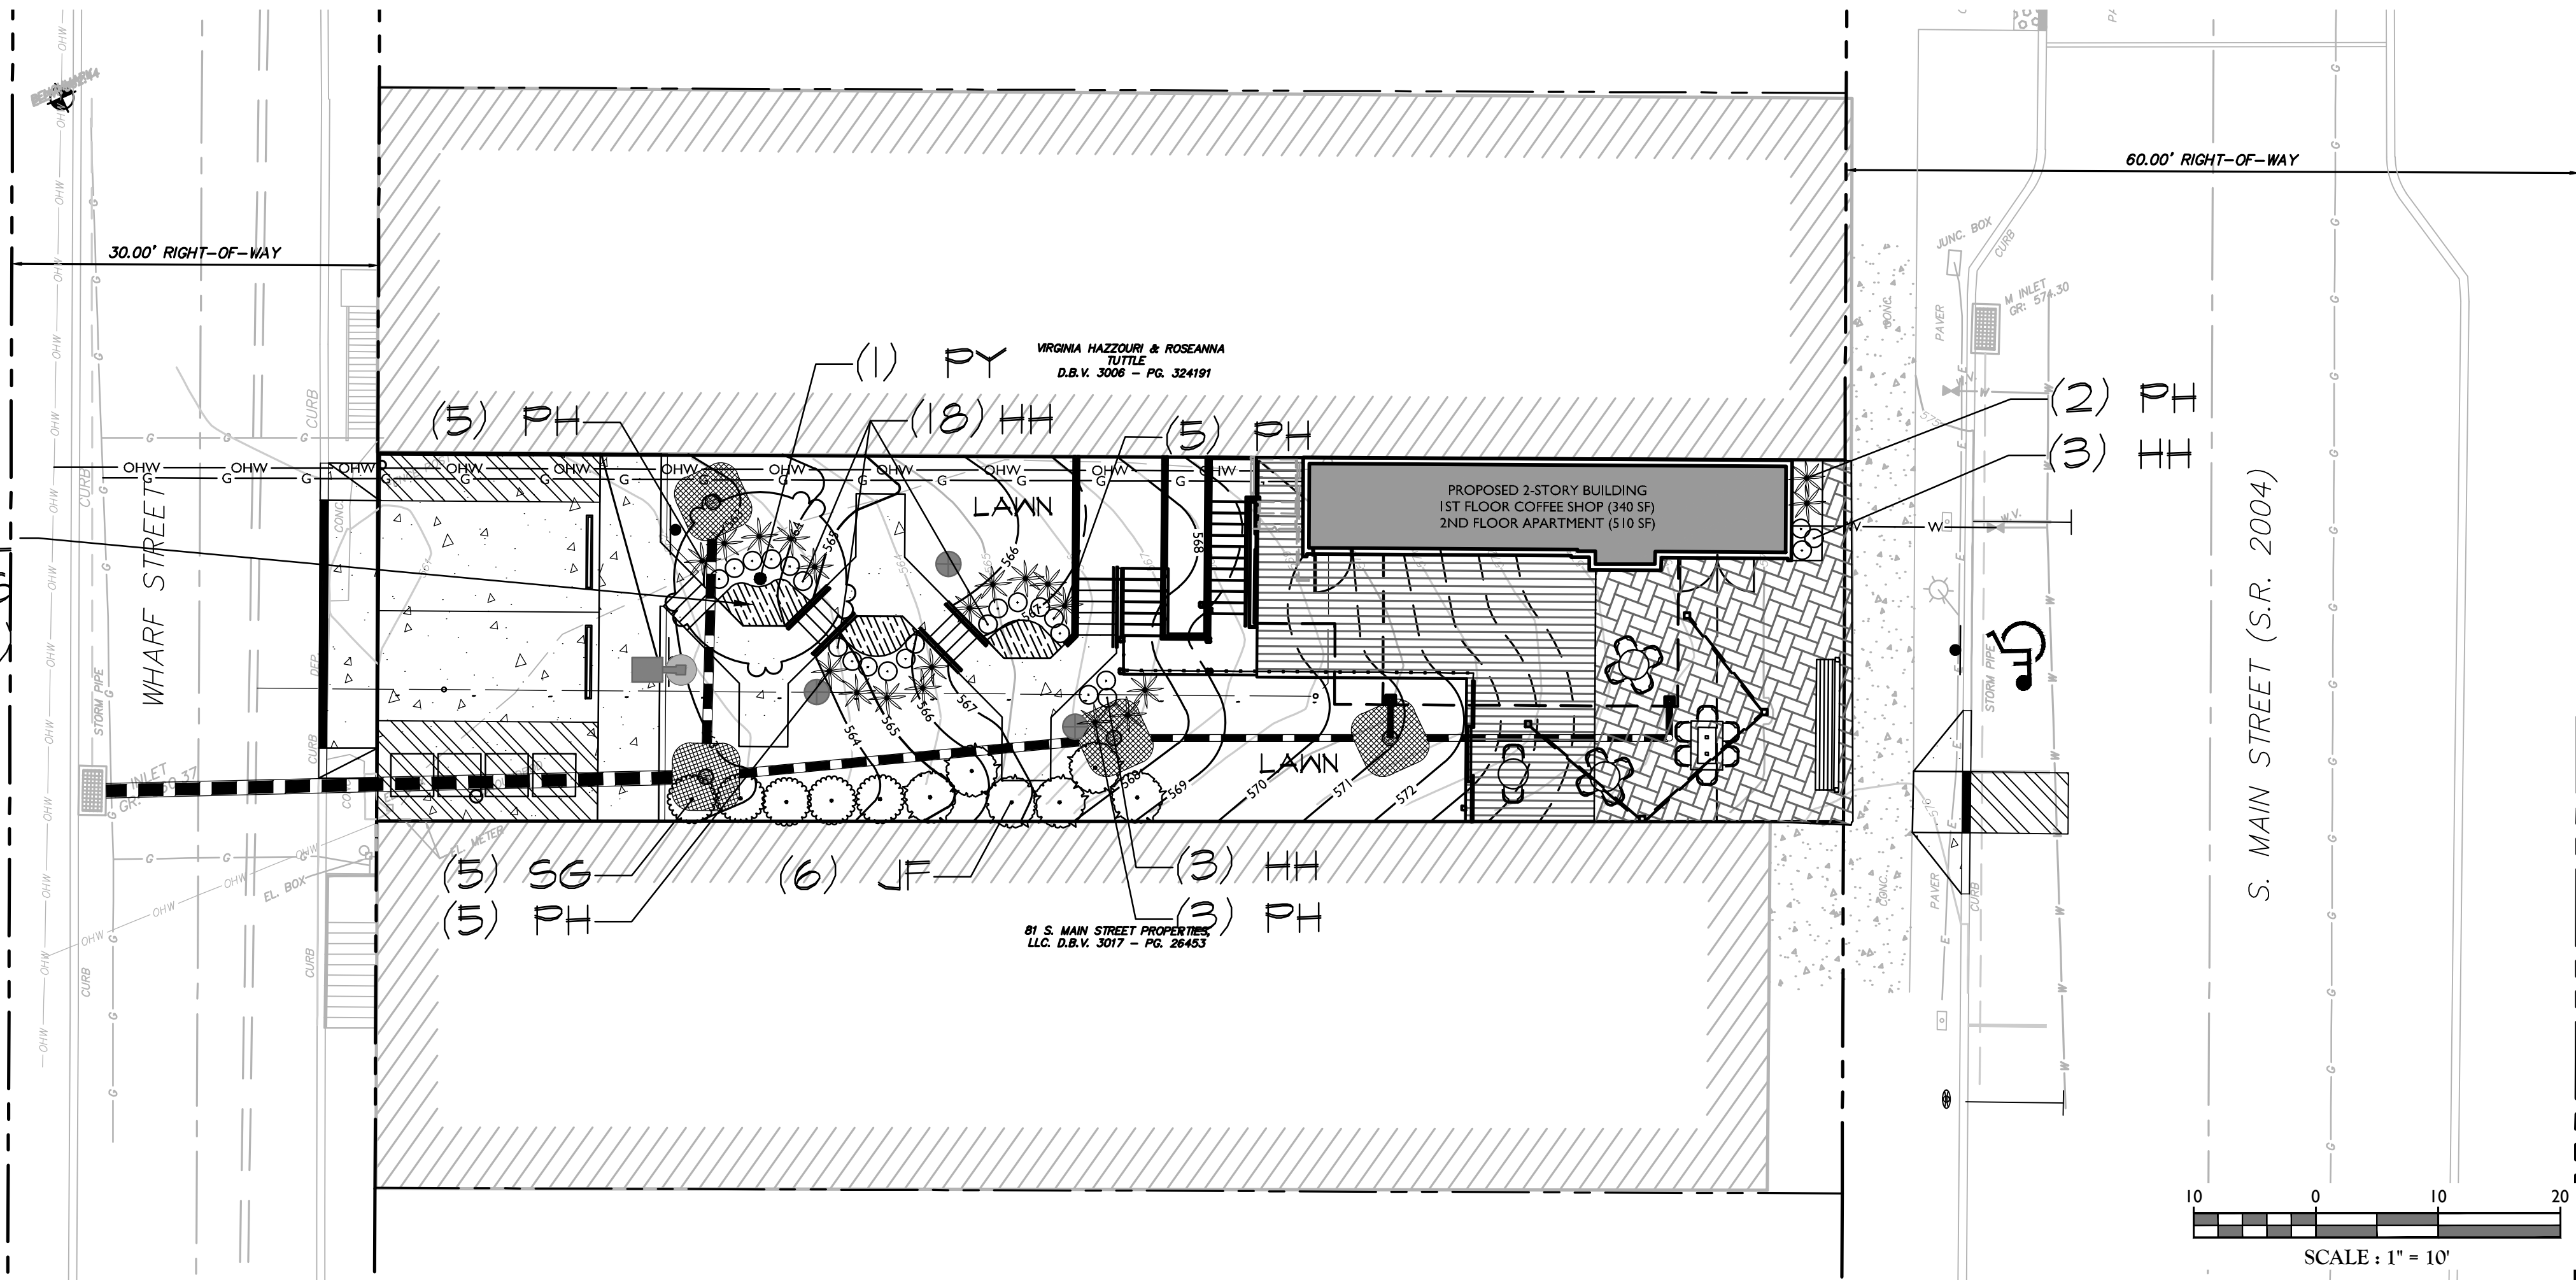

FLOWERING TREES		BOTANICAL NAME	COMMON NAME	CONT	CAL	SIZE	REMARKS
FL	1	<i>Prunus x yedoensis</i>	Yoshino Cherry	B & B		8-10' Ht.	FALL DIGGING HAZARD
SHRUBS		BOTANICAL NAME	COMMON NAME	SIZE	HEIGHT	REMARKS	
JF	6	<i>Juniperus chinensis</i> 'Sea Green'	Sea Green Juniper	B & B	30-36"		
SS	5	<i>Spiraea x bumalda</i> 'Goldflame'	Goldflame Spirea	3 gal	18-24"		
ANNUALS/PERENNIALS		BOTANICAL NAME	COMMON NAME	SIZE	HEIGHT	REMARKS	
HH	24	<i>Hemerocallis x 'Happy Returns'</i>	Happy Returns Daylily	1 gal			
GRASSES		BOTANICAL NAME	COMMON NAME	SIZE	HEIGHT	REMARKS	
PH	21	<i>Pennisetum alopecuroides</i> 'Hamine'	Hamine Dwarf Fountain Grass	1 gal			

1. THIS PLAN IS TO BE USED FOR LANDSCAPING PURPOSES ONLY.
2. CONTRACTOR IS TO EXAMINE ALL ENGINEERING DRAWINGS AND FIELD CONDITIONS FOR SPECIFIC LOCATIONS OF ALL UTILITIES, STRUCTURES, ETC, AND NOTIFY THE LANDSCAPE ARCHITECT IMMEDIATELY IF ANY DISCREPANCIES OR CONFLICTS ARE DISCOVERED PRIOR TO PLANTING.
3. IN THE EVENT THAT DISCREPANCIES EXIST BETWEEN THE PLAN AND THE PLANTING SCHEDULE, THE PLAN SHALL SUPERSEDE.
4. ALL PLANTING MATERIALS AND METHODS SHALL MEET OR EXCEED THE REQUIREMENTS OF THE MUNICIPAL ORDINANCE AND ANSI Z-601 (CURRENT VERSION), THE AMERICAN STANDARD FOR NURSERY STOCK, PUBLISHED BY THE AMERICAN ASSOCIATION OF NURSERYMAN, EXCEPT THAT IN THE EVENT OF CONFLICT BETWEEN THE STANDARDS, THE MORE STRINGENT STANDARD SHALL APPLY.
5. ALL LANDSCAPING SHALL BE PLANTED IN A MANNER THAT WILL NOT INTERFERE WITH UTILITY LINES, SIGHT TRIANGLES, PUBLIC WALKWAYS, STREETS, OR OTHER EXISTING OR PROPOSED STRUCTURES.
6. EXCEPT FOR SHADE TREES, ALL PLANT MATERIAL PLANTED WITHIN A REQUIRED SIGHT TRIANGLE OR SIGHT DISTANCE SHALL NOT EXCEED A MATURE HEIGHT OF 30' ABOVE THE ELEVATION OF THE ADJACENT ROADWAY.
7. ALL SHADE TREES PLANTED ADJACENT TO PEDESTRIAN WALKWAYS, VEHICLE ACCESSES OR WITHIN A REQUIRED SIGHT TRIANGLE OR SIGHT EASEMENT SHALL BE BRANCHED A MINIMUM OF 7'-0" ABOVE GRADE AND MUST BE APPROPRIATELY PRUNED.
8. SEE "SOIL EROSION AND SEDIMENT CONTROL" PLAN FOR THE LOCATION OF ALL TREE PROTECTION FENCING.
9. THE CONTRACTOR SHALL REPORT ANY SOIL OR DRAINAGE CONDITION CONSIDERED DETRIMENTAL TO THE GROWTH OF THE PROPOSED PLANT MATERIAL.
10. ALL DISTURBED AREAS BEYOND THE LIMITS OF THE MULCHED PLANTING BEDS SHALL BE PERMANENTLY STABILIZED WITH TURF GRASSES PER THE SOIL EROSION AND SEDIMENT CONTROL PLAN.
11. PLANTING LOCATIONS SHOWN ARE APPROXIMATE. IN GENERAL, PLANTS ARE TO BE PLANTED AT INTERVALS, WHICH WILL ALLOW THEM TO FULLY DEVELOP INTO CONTINUOUS MASSSES OF THE INDIVIDUAL SPECIES. NO PRUNING TO SHAPE OR SHEARING IS REQUIRED OR DESIRABLE.

1. ALL GRASS AREAS ARE TO BE MAINTAINED AT A CUT HEIGHT OF 2.5- 3". THE CUT SHALL NOT REMOVE MORE THAN 1/3 OF THE GRASS BLADE HEIGHT. LIIME FERTILIZER AND OTHER SOIL AMENDMENTS SHALL BE APPLIED AT REGULAR INTERVALS BASED UPON SOIL TESTS AND RECOMMENDATIONS FROM A CERTIFIED SOIL TESTING LAB. ALL APPLICATIONS SHALL BE MADE BY TRAINED AND LICENSED PERSONNEL IN ACCORDANCE WITH ALL APPLICABLE REGULATIONS AND NOTICE.
2. ALL PLANTING BEDS SHALL BE EDGED WITH A 3-4" DEEP "V" GROOVE BETWEEN THE BED AND ADJACENT LAWN AREA. ALL MULCH SHALL BE REPLENISHED TO MAINTAIN A MAX. 3" THICK LAYER UNLESS THE GROUND COVER OR PLANTING HAS COMPLETELY COVERED THE SURFACE OF THE PLANTING BED.
3. ALL PLANTING BEDS SHALL BE MAINTAINED FREE OF WEEDS.
4. PLANTS SHALL BE PERIODICALLY PRUNED OF DEAD, DAMAGED OR DISEASED BRANCHES. ALL PRUNING SHALL BE PERFORMED IN A MANNER THAT WILL MAINTAIN THE NATURAL GROWTH HABIT OF THE PLANT. FLOWERING TREES AND SHRUBS SHALL BE PRUNED AFTER THE FLOWERING SEASON FOR THE RESPECTIVE PLANT.
5. ALL PLANTS SHALL BE WATERED IN ACCORDANCE WITH SOUND HORTICULTURAL PRACTICE.
6. HERBICIDES AND PESTICIDES SHOULD ONLY BE APPLIED AS NECESSARY TO ADDRESS SPECIFIC PROBLEMS. ALL TREATMENTS SHALL BE PERFORMED BY A TRAINED AND LICENSED APPLICATOR.
7. ALL PAVEMENT SHALL BE MAINTAINED FREE OF LITTER, GRASS CLIPPINGS, STAINS, SNOW AND ICE AND OTHER DEBRIS.
8. ALL DEAD OR UNHEALTHY PLANTS SHALL BE REPLACED AS NECESSARY DURING THE FIRST AVAILABLE GROWING SEASON.
9. ALL TREE GUYS AND STAKES SHALL BE REMOVED BY THE CONTRACTOR AFTER ONE (1) GROWING SEASON.



NOTE:  
ANNUALS AND PERENNIALS TO USE  
CONTAINER PLANT CONDITION

## SHRUB PLANTING DETAIL

**NOTE: DO NOT SCALE DRAWINGS FOR CONSTRUCTION**












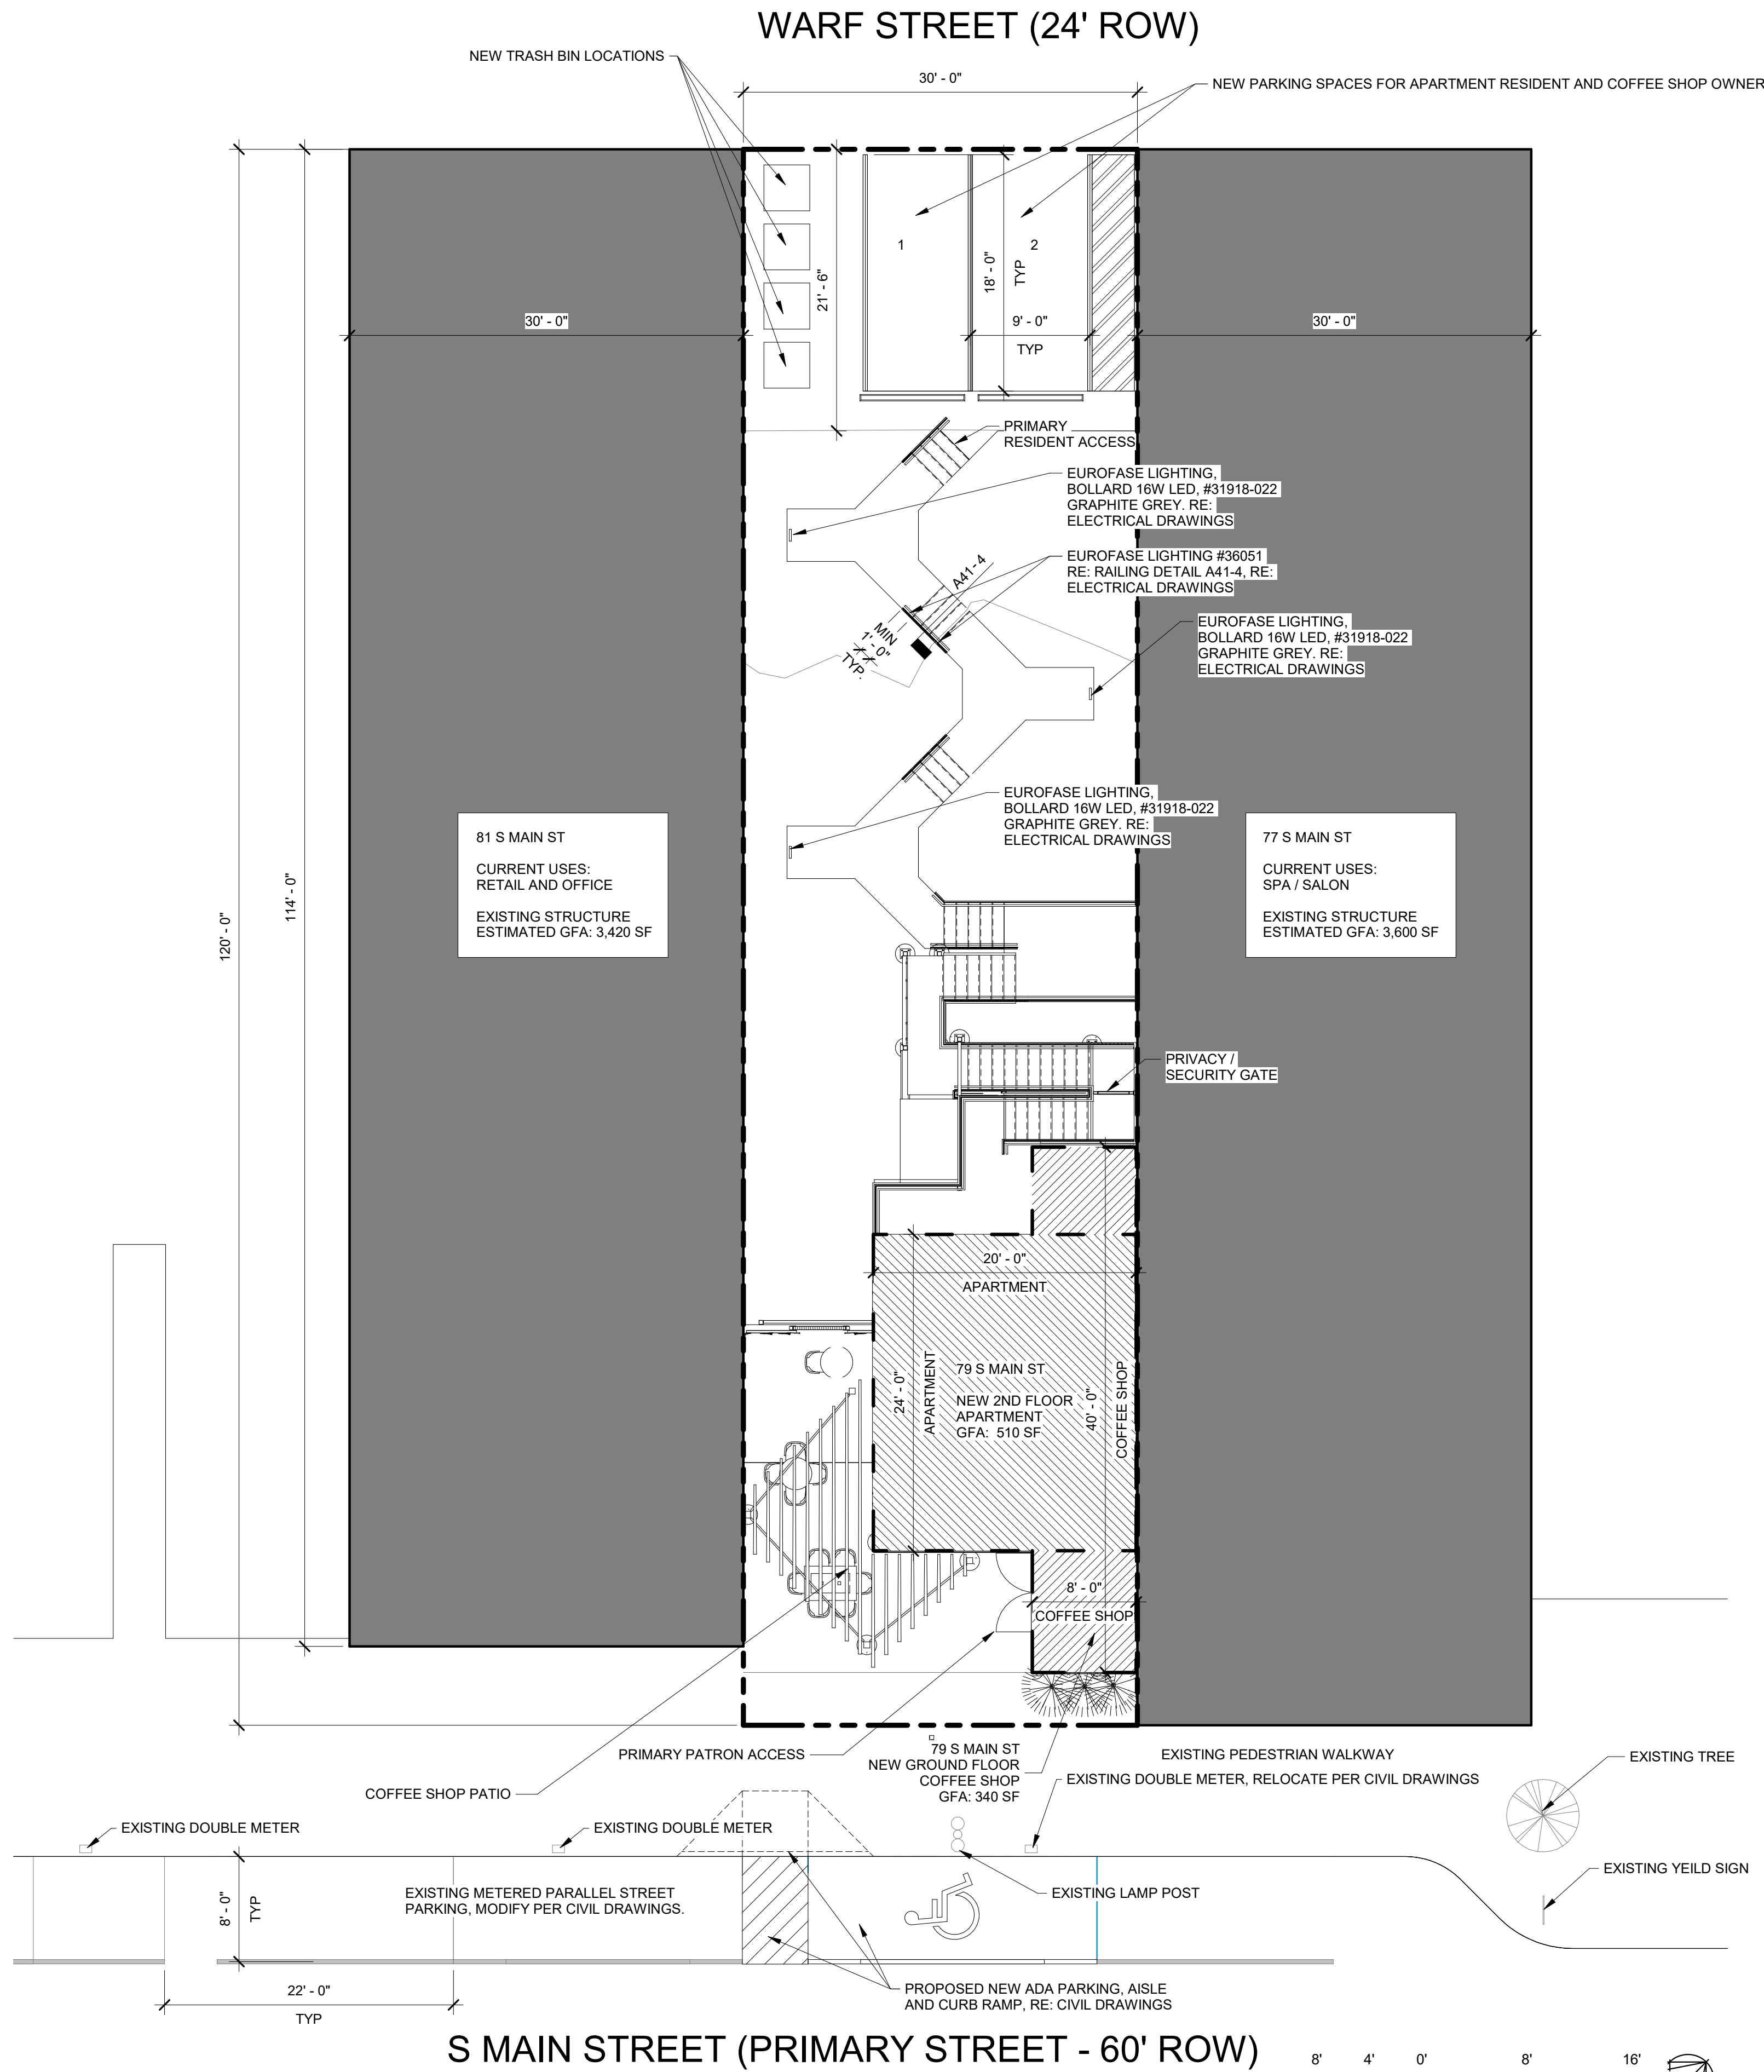

CRAIG A. SLOCUM, ARCHITECT  
2086 S COLORADO BLVD, SUITE 525  
DENVER, CO 80222  
(303) 962-9164

**CONTAINER COFFEE SHOP**  
79 SOUTH MAIN STREET  
PITTSBURGH, PA

CRAIG A. SLOCUM, ARCHITECT  
2086 S COLORADO BLVD, SUITE 525  
DENVER, CO 80222  
(303) 962-9164  
www.cshqa.com

AGENCY SET

PROJECT 19176	DATE 05-07-2020
DRAWN LMV	CHECKED JSG / CAS

REVISED

SHEET TITLE

ARCHITECTURAL  
SITE PLAN

SHEET

AS10  
ORIGINAL SHEET SIZE  
24" x 36"





GN. GENERAL

GN.1 THE STRUCTURAL DRAWINGS AND SPECIFICATIONS ARE A PORTION OF THE CONSTRUCTION DOCUMENTS. THE CONTRACTOR AND SUBCONTRACTORS SHALL REFERENCE AND COORDINATE WITH ALL OTHER DISCIPLINES' DRAWINGS. ANY DISCREPANCIES OR OMISSIONS SHALL BE REPORTED TO THE STRUCTURAL ENGINEER AND ARCHITECT.

GN.2 DESIGN CRITERIA:

- A. CODES AND SPECIFICATIONS:
1. GENERAL BUILDING CODE: INTERNATIONAL BUILDING CODE, 2018
2. DESIGN LOAD CRITERIA:  
MINIMUM DESIGN LOADS FOR BUILDINGS AND OTHER STRUCTURES, AMERICAN SOCIETY OF CIVIL ENGINEERS, ASCE 7
3. CONCRETE:  
BUILDING CODE REQUIREMENTS FOR STRUCTURAL CONCRETE, AMERICAN CONCRETE INSTITUTE, ACI 318.
4. STRUCTURAL STEEL:  
SPECIFICATION FOR STRUCTURAL STEEL BUILDINGS, AMERICAN INSTITUTE OF STEEL CONSTRUCTION, AISC 360.
- A. DESIGN LOADS (PSF):
1. ANY CHANGES IN CONSTRUCTION MATERIALS FROM THOSE SHOWN ON THE ARCHITECTURAL OR STRUCTURAL DRAWINGS SHALL BE REPORTED BY THE CONTRACTOR TO THE STRUCTURAL ENGINEER FOR VERIFICATION OF LOAD CARRYING CAPACITY OF THE STRUCTURE.
2. LIVE LOADS:  
ROOF NON-ACCESSIBLE (REDUCIBLE) 20  
OFFICES 50  
ASSEMBLY AREAS 100  
BALCONIES, EXTERIOR 100  
CORRIDORS ABOVE 1ST FLOOR 80  
STAIRS, EXITWAYS 100  
  
LIVE LOAD REDUCTIONS HAVE BEEN APPLIED IN ACCORDANCE WITH THE BUILDING CODE, UNLESS NOTED.
2. SNOW LOAD:  
GROUND SNOW LOAD (Pg)-----35 PSF
3. WIND LOADS:  
BASIC WIND SPEED (3 – SECOND GUST)-----115 MPH WIND IMPORTANCE FACTOR (Iw) 1.0  
BUILDING CATEGORY II  
WIND EXPOSURE CATEGORY B  
INTERNAL PRESSURE COEFFICIENT -----+/-0.18 WALL COMPONENT AND CLADDING WIND PRESSURE-SEE DRAWINGS
4. SEISMIC LOADS:  
SEISMIC IMPORTANCE FACTOR (Ie) II  
MAPPED SPECTRAL RESPONSE ACCELERATIONS:  
Ss 0.151  
S1 0.058  
SITE CLASS D  
SITE COEFFICIENTS:  
Fa 1.6  
Fv 2.4  
DESIGN SPECTRAL RESPONSE ACCELERATION PARAMETERS:  
Sds 0.161  
Sd1 0.093
- BASIC SEISMIC-FORCE-RESISTING SYSTEM: CORRUGATED STEEL SHEAR WALLS, MOMENT FRAMES AT DOORS AND CONTAINER FRONTS
- RESPONSE MODIFICATION FACTOR(R) 2  
OVER-STRENGTH FACTOR (Ωo) 3  
DEFLECTION AMPLIFICATION FACTOR (Cd) 3  
ANALYSIS PROCEDURE: MODAL RESPONSE SPECTRAL ANALYSIS FOR SOUTH SECTION (COMMERICAL), EQUIVALENT LATERAL FORCE FOR NORTH SECTION (RESIDENTIAL).

GN. 3 SUBMITTALS:

- A. REVIEW OF SHOP DRAWINGS AND OTHER SUBMITTALS BY THE STRUCTURAL ENGINEER DOES NOT RELIEVE THE CONTRACTOR OF THE RESPONSIBILITY TO REVIEW AND CHECK SHOP DRAWINGS BEFORE SUBMITTING TO THE STRUCTURAL ENGINEER. THE CONTRACTOR REMAINS SOLELY RESPONSIBLE FOR ERRORS AND OMISSIONS ASSOCIATED WITH THE PREPARATION OF SHOP DRAWINGS AS THEY PERTAIN TO MEMBER SIZES, DETAILS, AND DIMENSIONS SPECIFIED IN THE CONTRACT DOCUMENTS. ALL SHOP DRAWINGS MUST BE REVIEWED AND "APPROVED" BY THE CONTRACTOR PRIOR TO SUBMITTAL
- B. ELECTRONIC SHOP DRAWING SUBMITTALS: SUBMIT ALL ELECTRONIC SHOP DRAWINGS IN .PDF FORMAT. REVIEWED SHOP DRAWINGS WILL BE RETURNED IN PDF FORMAT. ALL PRINTS REQUIRED BY THE CONTRACTOR ARE THE RESPONSIBILITY OF THE CONTRACTOR AND SHALL BE MADE AFTER APPROVED SHOP DRAWINGS ARE RETURNED.
- C. RESUBMITTED SHOP DRAWINGS: RESUBMITTED SHOP DRAWINGS SHALL HAVE ALL CHANGES SINCE THE PREVIOUS SUBMISSION IDENTIFIED BY CLOUDING OR OTHER CLEAR COMMUNICATION. RE-REVIEWED SHOP DRAWINGS WILL ONLY BE REVIEWED FOR IDENTIFIED CHANGES.SHOP DRAWINGS:
- D. THE CONTRACTOR SHALL SUBMIT FOR STRUCTURAL ENGINEER REVIEW SHOP DRAWINGS FOR THE FOLLOWING ITEMS. ITEMS MARKED (*) SHALL HAVE SHOP DRAWINGS SEALED BY A PROFESSIONAL ENGINEER REGISTERED IN THE STATE IN WHICH THE PROJECT IS LOCATED. ITEMS MARKED (#) SHALL BE SUBMITTED FOR STRUCTURAL ENGINEER'S RECORD ONLY.
1. CONCRETE MIX DESIGNS  
2. CONCRETE REINFORCING  
3. CONSTRUCTION JOINT LOCATIONS IN STRUCTURAL FLOORS.  
4. STRUCTURAL STEEL CONNECTIONS  
5. STEEL STAIRS (*)
- E. DESIGN CALCULATIONS: THE CONTRACTOR SHALL SUBMIT FOR STRUCTURAL ENGINEER'S RECORD, DESIGN CALCULATIONS SEALED BY A PROFESSIONAL ENGINEER REGISTERED IN THE STATE OF PENNSYLVANIA FOR THE FOLLOWING ITEMS.
1. STEEL STAIRS  
2. HELICAL PIERS
- F. PROVIDE THE ICC-ESR REPORT FOR THE HELICAL PIERS.

GN. 4 ALL DETAILS SHOWN ARE TYPICAL. SIMILAR DETAILS APPLY TO SIMILAR CONDITIONS, UNLESS NOTED.

GN. 5 THE CONTRACTOR IS RESPONSIBLE FOR MEANS, METHODS, TECHNIQUES, SEQUENCES, AND PROCEDURES OF CONSTRUCTION.

GN. 6 CONSTRUCTION MATERIALS SHALL BE SPREAD OUT IF PLACED ON FRAMED FLOORS/ROOFS. IT IS THE CONTRACTOR'S RESPONSIBILITY TO ENSURE THAT LOADS DO NOT EXCEED THE DESIGN LIVE LOAD.

FD. FOUNDATION

- FD.1 GEOTECHNICAL REPORT: FOUNDATION DESIGN IS BASED ON GEOTECHNICAL REPORT BY BARRY ISETT & ASSOCIATES DATED AUGUST 28, 2019. A COPY OF THE GEOTECHNICAL REPORT CAN BE OBTAINED FROM THE OWNER.
- FD.2 THE GEOTECHNICAL REPORT RECOMMENDS HELICAL PIERS BELOW ALL FOUNDATIONS. THE HELICAL PIERS SHALL BE DESIGNED BY A PROFESSIONAL ENGINEER LICENSED IN THE STATE OF PENNSYLVANIA. REQUIRED LOADS ARE SHOWN ON THE STRUCTURAL PLANS.
- FD.3 ALL FOUNDATION BEARING SURFACES SHALL BE INSPECTED AND APPROVED BY THE GEOTECHNICAL ENGINEER PRIOR TO PLACING CONCRETE TO ENSURE COMPLIANCE WITH PRESSURES NOTED. THE FINAL BEARING ELEVATIONS MAY VARY AS REQUIRED TO PROVIDE PROPER BEARING CAPACITY IN AN APPROVED BEARING STRATUM AS DETERMINED BY THE GEOTECHNICAL ENGINEER.
- FD.4 FOOTINGS SHALL BE PLACED THE SAME DAY AS INSPECTION BY THE GEOTECHNICAL ENGINEER UNLESS EXTENDED TIME IS APPROVED BY THE GEOTECHNICAL ENGINEER.
- FD.5 FOOTINGS SHALL BE NEATLY EXCAVATED WHERE POSSIBLE WITH SIDES AND TOP EDGES FREE OF LOOSE OR WET MATERIALS. WHERE NEAT EXCAVATION IS NOT POSSIBLE, FOOTING EXCAVATION SHALL BE FILLED WITH CONCRETE TO THE TOP OF FOOTING. THE BOTTOM EXCAVATION SHALL BE CLEAN AND DRY WITH ALL LOOSE MATERIAL REMOVED FOR AN ESSENTIALLY FLAT BEARING SURFACE. WHERE SOFT OR UNSUITABLE BEARING SURFACES ARE ENCOUNTERED, THE AREA SHALL BE UNDERCUT AS REQUIRED AND REPLACED WITH LEAN CONCRETE OR COMPACTED DENSE GRADED CRUSHED STONE AS DIRECTED BY THE GEOTECHNICAL ENGINEER.
- FD.6 COMPACTED FILL SHALL MEET THE REQUIREMENTS NOTED IN THE GEOTECHNICAL REPORT. EXCAVATED MATERIAL MAY BE USED AS BACKFILL MATERIAL WITH WRITTEN APPROVAL FROM THE GEOTECHNICAL ENGINEER STATING THAT SUCH MATERIAL IS SUITABLE AS BACKFILL AND INSTRUCTIONS ARE GIVEN FOR PROPER MOISTURE CONTENT AND COMPACTION.
- FD.7 PROVIDE 6" OF COMPACTED GRANULAR FILL BENEATH ALL SLABS ON GRADE. PROVIDE 6 MIL VAPOR RETARDER BETWEEN BOTTOM OF SLAB AND TOP OF GRANULAR FILL.
- FD.8 HELICAL PIERS SHALL BE MANUFACTURED BY CHANCE, GRIP TITE, RAM JACK OR AN APPROVED EQUAL. THE PIERS MUST BE APPROVED BY THE INTERNATIONAL CODE COUNCIL EVALUATION SERVICE. THE PIERS SHALL BE GALVANIZED AND HAVE A MINIMUM 8-10 FLIGHT CONFIGURATION.
- FD.9 THE CONTRACTOR SHALL KEEP LOGS OF THE INSTALLATION OF THE PIERS TO INCLUDE THE LOCATION, DEPTH, AND TORQUE. PRIOR TO INSTALLATION OF THE PIERS, A TEST PIER SHALL BE INSTALLED TO VERIFY THE CORRECT TORQUE AND FLIGHT CONFIGURATION.

CN. CONCRETE

CN.1 CONCRETING OPERATIONS SHALL COMPLY WITH ACI STANDARDS.

CN.2 MINIMUM CONCRETE COMPRESSIVE STRENGTH AT 28 DAYS (PSI), TYPE OF CONCRETE, MAXIMUM W/C (WATER/CEMENTITIOUS MATERIALS RATIO), AIR CONTENT, SLUMP AND CONCRETE USE:

STRENGTH TYPE	W/C	AIR	SLUMP	USE
3000	NORMAL WT. 0.45	---	3" TO 5"	SLAB ON GRADE
3000	NORMAL WT. 0.57	---	3" TO 5"	FOOTINGS

CN. 3. REINFORCING BARS: ASTM A615 GRADE 60.

CN. 4. WELDED WIRE REINFORCEMENT (WWR): ASTM A185. MINIMUM LAP AND EMBEDMENT TO BE THE GREATER OF ONE CROSS WIRE SPACING PLUS 2" OR 6".

CN. 5. REINFORCING STEEL SHOWN IN SECTIONS AND DETAILS IS A SCHEMATIC INDICATION THAT REINFORCING EXISTS. SEE SCHEDULES, SECTION NOTES AND GENERAL NOTES FOR ACTUAL REINFORCING REQUIRED.

CN. 6. REINFORCING BAR PLACING ACCESSORIES TO BE INSTALED IN ACCORDANCE WITH ACI MANUAL OF STANDARD PRACTICE. WHERE CONCRETE IS EXPOSED IN FINISHED BUILDING, PROVIDE ACCESSORIES WITH RUSTPROOF LEGS.

CN. 7. DETAIL REINFORCEMENT IN ACCORDANCE WITH ACI 315. REINFORCEMENT SHALL NOT BE WELDED UNLESS NOTED OR APPROVED BY THE STRUCTURAL ENGINEER.

CN. 8. SPLICES SHALL BE CLASS "B" TENSION LAP SPLICE, UNLESS NOTED.

CN. 9. REINFORCING MARKED "CONTINUOUS" SHALL BE SPLICED WITH CLASS "B" TENSION LAP SPLICE, UNLESS NOTED.

CN.10. CONCRETE COVERAGE OF REINFORCEMENT, UNLESS NOTED:

FOOTINGS-----2" TOP & 3" BOTTOM & SIDES  
SUMP AND PIT WALLS-----2" BOTH FACES INTERIOR ELEVATED SLABS NOT EXPOSED TO WEATHER--3/4" TOP & BOTTOM  
WWR IN SLABS ON GRADE-----2" TOP  
SLABS ON WELL GRADED SUBGRADE OR VAPOR BARRIERS:  
3/4" TOP & 1 1/2" BOTTOM

CN.11. FOR CONCRETE WALLS WITH A SINGLE LAYER OF REINFORCING, REINFORCING TO BE CENTERED IN WALL UNLESS NOTED.

CN. 11. SLABS ON GRADE: 4" THICK, REINFORCED WITH 6X6 W1.2/W1.2 WWR AT MID-DEPTH OF SLAB, UNLESS NOTED.

CN. 12. CONCRETE EXPOSED TO WEATHER SHALL BE AIR ENTRAINED TO 7 1/2 %, WITHIN -1% TO +2%

SS. STRUCTURAL STEEL

SS. 1 FABRICATE AND ERECT ALL STRUCTURAL STEEL IN ACCORDANCE WITH AISC "CODE OF STANDARD PRACTICE FOR STEEL BUILDINGS AND BRIDGES".

SS. 2 THE STEEL FRAME IS "NON-SELF-SUPPORTING". ADEQUATE TEMPORARY SUPPORT MUST BE PROVIDED BY THE CONTRACTOR UNTIL THE LATERAL FORCE RESISTING SYSTEM AND STABILITY OF THE COMPLETED STRUCTURE IS IN PLACE.

SS. 3 LATERAL FORCE RESISTING SYSTEM AND STABILITY OF THE BUILDING IN THE COMPLETED STRUCTURE IS PROVIDED AS FOLLOWS:

- A. ROOF DIAPHRAGM: CORRUGATED STEEL CONTAINER ROOFS.
- B. FLOOR DIAPHRAGM: PLYWOOD CONTAINER FLOORS.
- C. COLLECTOR ELEMENTS/DRAW STRUTS: CONTAINER TOP RAILS AND BOTTOM RAILS.
- D. LATERAL FORCE RESISTING SYSTEM: CORRUGATED CONTAINER WALLS, PORTAL FRAMES AT CONTAINER DOOR OPENINGS.

SS. 4 STRUCTURAL STEEL AND STRUCTURAL STEEL CONNECTIONS SHALL CONFORM TO THE FOLLOWING MINIMUM REQUIREMENTS UNLESS NOTED OTHERWISE:

W AND WT SHAPES	ASTM A992
STIFFENER PLATES, BASE PLATES CAP PLATES, CONNECTION PLATES AND ANGLES	ASTM A36
HOLLOW STRUCTURAL SECTIONS	ASTM A500, GRADE C
WELDED CONNECTIONS	E70XX ELECTRODES, MINIMUM SIZE FILLET WELD 3/16"
BOLTS	ASTM A449 OR A590
NUTS	ASTM A563
WASHERS	ASTM F436

SS. 5 WHERE NOT CAMBER IS INDICATED, BEAMS SHOULD BE ERECTED WITH NATURAL CAMBER ORIENTED UPWARDS.

SS. 6 FOUR ANCHOR BOLTS MINIMUM FOR BASE PLATES UNDER COLUMNS.

SS. 7 GROUT UNDER BEARING PLATES SHALL BE NON SHRINK, NON-METALLIC TYPE. GORUT SHALL HAVE A SPECIFIED DESIGN COMPRESSIVE STRENGTH OF 8000 PSI.

SS. 8 STRUCTURAL STEEL MEMBERS SHALL NOT BE CUT, SPLICED, OR MODIFIED IN THE FIELD UNLESS NOTED ON THE STRUCTURAL DRAWINGS OR APPROVED BY THE STRUCTURAL ENGINEER.

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SHEET TITLE

GSN 1

SHEET

S1

ORIGINAL SHEET SIZE  
24" x 36"

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SC STRUCTURAL CONNECTIONS

SC. 1 CONNECTIONS HAVE BEEN DESIGNED FOR THE PROJECT BY RUNKLE CONSULTING, INC. THE CONTRACTOR SHALL PROVIDE SHOP DRAWINGS FOR THE STEEL ERECTION WHICH WILL INCLUDE CONNECTIONS. THE CONNECTION DESIGNS ON THE PROJECT DOCUMENTS ARE NOT TO BE UTILIZED AS SHOP DRAWINGS.

SC. 2 ALTERNATE CONNECTION DETAILS MAY BE UTILIZED BY THE CONTRACTOR WITH PRIOR APPROVAL BY THE ARCHITECT AND STRUCTURAL ENGINEER. THE CONTRACTOR'S ALTERNATE CONNECTION DESIGN SHALL BE UNDER THE DIRECT SUPERVISION OF A PROFESSIONAL ENGINEER PENNSYLVANIA.

SC. 3 DESIGN CALCULATIONS FOR THE CONNECTIONS SHALL BE PROVIDED BY THE CONTRACTOR AND DESIGNED BY A PROFESSIONAL ENGINEER. CALCULATIONS SHALL BEAR THE SEAL OF A PROFESSIONAL ENGINEER REGISTERED IN PENNSYLVANIA AND SUBMITTED FOR THE FILES OF THE ARCHITECT AND STRUCTURAL ENGINEER. THE CONNECTION DESIGNER'S ENGINEERING SEAL ON THE DESIGN CALCULATIONS SHALL REPRESENT THAT THE CONNECTIONS INDICATED ON THE SHOP DRAWINGS HAVE BEEN REVIEWED AND ARE IN ACCORDANCE WITH THE SUBMITTED DESIGN CALCULATIONS. SHOP DRAWINGS CONTAINING CONNECTIONS FOR WHICH CALCULATIONS HAVE NOT BEEN RECEIVED OR REQUIRED CONNECTION INFORMATION IS NOT PROVIDED WILL BE RETURNED UNCHECKED AS AN INCOMPLETE SUBMITTAL.

SC. 4 REQUIRED CONNECTION INFORMATION SHALL BE SHOWN AT EACH DETAILED CONNECTION ON THE SUBMITTAL DRAWINGS AS FOLLOWS:

- A. DESIGN REACTION.
- B. CALCULATION PAGE NUMBER.
- C. CONNECTION CAPACITY.

SC. 5 ALL NON-COMPOSITE BEAM CONNECTIONS SHALL BE "SIMPLE SHEAR CONNECTIONS", UNLESS NOTED. WHERE BEAM REACTIONS AND/OR DESIGN FORCES ARE NOT SHOWN ON THE STRUCTURAL DRAWINGS, THE CONNECTIONS SHALL BE DESIGNED TO SUPPORT A REACTION EQUAL TO ONE-HALF THE TOTAL UNIFORM LOAD CAPACITY FROM THE MAXIMUM TOTAL UNIFORM LOAD TABLE MULTIPLIED BY A FACTOR OF 1.2 FOR GIVEN SHAPE, SPAN, AND GRADE OF STEEL.

SC. 6 ALL BEAM CONNECTIONS SHALL BE "SIMPLE SHEAR CONNECTIONS" UNLESS NOTED. WHERE BEAM REACTIONS AND/OR DESIGN FORCES ARE NOT SHOWN ON THE STRUCTURAL DRAWINGS THE CONNECTIONS SHALL BE DESIGNED TO SUPPORT A REACTION EQUAL TO ONE HALF THE TOTAL UNIFORM LOAD CAPACITY FROM THE MAXIMUM TOTAL UNIFORM LOAD TABLE MULTIPLIED BY A FACTOR OF 1.6.

SC. 7. TO THEREACTIONS ABOVE, ADD ANY LOADS OR REACTIONS OF MEMBERS SUPPORTED BY THE BEAM WITHIN THREE FEET OF BEAM END AND THE VERTICAL COMPONENTS OF FORCES IN BRACE MEMBERS FRAMING INTO THE BEAM. WHERE BEAM REACTIONS ARE SHOWN ON THE DRAWINGS, THE CONNECTIONS SHALL DEVELOP THE REACTIONS SHOWN. WHERE CONNECTIONS ARE SUBJECT TO ECCENTRICITY, SUCH ECCENTRICITY SHALL BE TAKEN INTO ACCOUNT WHEN DESIGNING AND DETAILING THE CONNECTION.

SC. 8 ERECTION AIDS ARE NOT SHOWN ON THESE DRAWINGS. CONTRACTOR IS TO PROVIDE ERECTION AIDS AS REQUIRED AND REMOVE THEM ONCE WORK IS COMPLETE.

SC. 9 FOR CONNECTION DESIGN AND DETAILING, MEMBER WORK LINES ARE TO BE CONSIDERED ALONG THE MEMBERS' NEUTRAL AXES, UNLESS NOTED.

SC. 10 ALL WELDS SHALL CONFORM TO THE AMERICAN WELDING SOCIETY (ANSI/AWS D1.1) STANDARDS AND MUST BE PERFORMED BY AN ANSI/AWS CERTIFIED WELDER.

SC. 11 ALL WELD SIZES ARE TO BE CONSIDERED AS EFFECTIVE WELD SIZES AND MUST BE INCREASED TO ACCOUNT FOR ANY GAPS OR SKEWS BETWEEN MEMBERS AS REQUIRED BY ANSI/AWS D1.1.

SC. 12 BOLTED CONNECTIONS SHALL USE BEARING TYPE A325-N OR A490-N IN ACCORDANCE WITH AISC 'SPECIFICATION FOR STRUCTURAL JOINTS USING ASTM A325 OR A490 BOLTS'.

SC. 13 ALL BOLTS SHALL BE 1/2" DIAMETER OR GREATER, UNLESS NOTED USE SNUG TIGHT BEARING CONNECTIONS FOR ALL BOLTED CONNECTIONS UNLESS NOTED.

SH. SHIPPING CONTAINERS

SH.1 SHIPPING CONTAINERS SHALL BE AS MANUFACTURED BY JINDO, OR EQUAL, AND SHALL BE 40" HIGH CUBE CONTAINERS". THE OUTSIDE DIMENSIONS OF THE CONTAINERS SHALL COMPLY WITH ISO 668, SERIES 1 FREIGHT CONTAINERS – CLASSIFICATION, DIMENSIONS, AND RATINGS. THE CONTAINERS SHALL BE SERIES 1, WITH A UNIFORM WIDTH OF 8 FT (2,438MM), AND SHALL BE DESIGNATED 1AAA, 9 FT 6 IN (2,896 MM) HIGH. THE CONTAINERS SHALL BE RATED FOR 67,200 LBS PER TABLE 2, ISO 668

SH.2 THE SHIPPING CONTAINERS SHALL HAVE BEEN INITIALLY CERTIFIED FOR COMPLIANCE TO THE RULES FOR CERTIFICATION OF CARGO CONTAINERS AND THE INTERNATIONAL CONVENTION FOR SAFE CONTAINERS (CSC) FOR USE AS SHIPPING CONTAINERS BY THE AMERICAN BUREAU OF SHIPPING (ABS), (ICC AC 462, ACCEPTANCE CRITERIA FOR STRUCTURAL BUILDING MATERIALS FROM SHIPPING CONTAINERS).

SH.3 THE CONTAINERS SHALL BE RATED BY THE INSTITUTED OF INTERNATIONAL CONTAINER LESSORS AS CARGO WORTHY AND WIND AND WATER TIGHT. THE CONTAINER SHALL BE PROVIDED WITH A VALID CSC PLATE (CONVENTION FOR SAFE CONTAINERS).

SH.4 CONTAINERS SHALL BE CONSTRUCTED OF STEEL THAT IS COMPLIANT WITH THE MECHANICAL AND CHEMICAL REQUIREMENTS OF ASTM A242.

SH.5 SHIPPING CONTAINERS SHALL BE FABRICATED FROM SPA-H/JIS G3125 GRADE STEEL, WHICH HAS THE FOLLOWING MECHANICAL REQUIREMENTS:  
YIELD STRENGTH: 345 MPA (50 KSI)  
TENSILE STRENGTH: 480 MPA (70 KSI)  
THE MECHANICAL REQUIREMENTS MATCH THE REQUIREMENTS OF ASTM A472 STEEL.

SH.6 THE STEEL USED FOR FABRICATION OF THE SHIPPING CONTAINERS SHALL MATCH THE CHEMICAL REQUIREMENTS OF ASTM 242 AND SPA-H/JIS G3125:  
CARBON 0.15 % MAX  
MANGANESE 1% MAX  
PHOSPHORUS 0.015% MAX  
SULFUR 0.05% MAX  
COPPER .20% MIN

1 GSN 2  
1/2" = 1'-0"

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SHEET TITLE

GSN 2

SHEET


S2

ORIGINAL SHEET SIZE  
24" x 36"



FOUNDATION AND DECK FRAMING PLAN

1/2" = 1'-0"

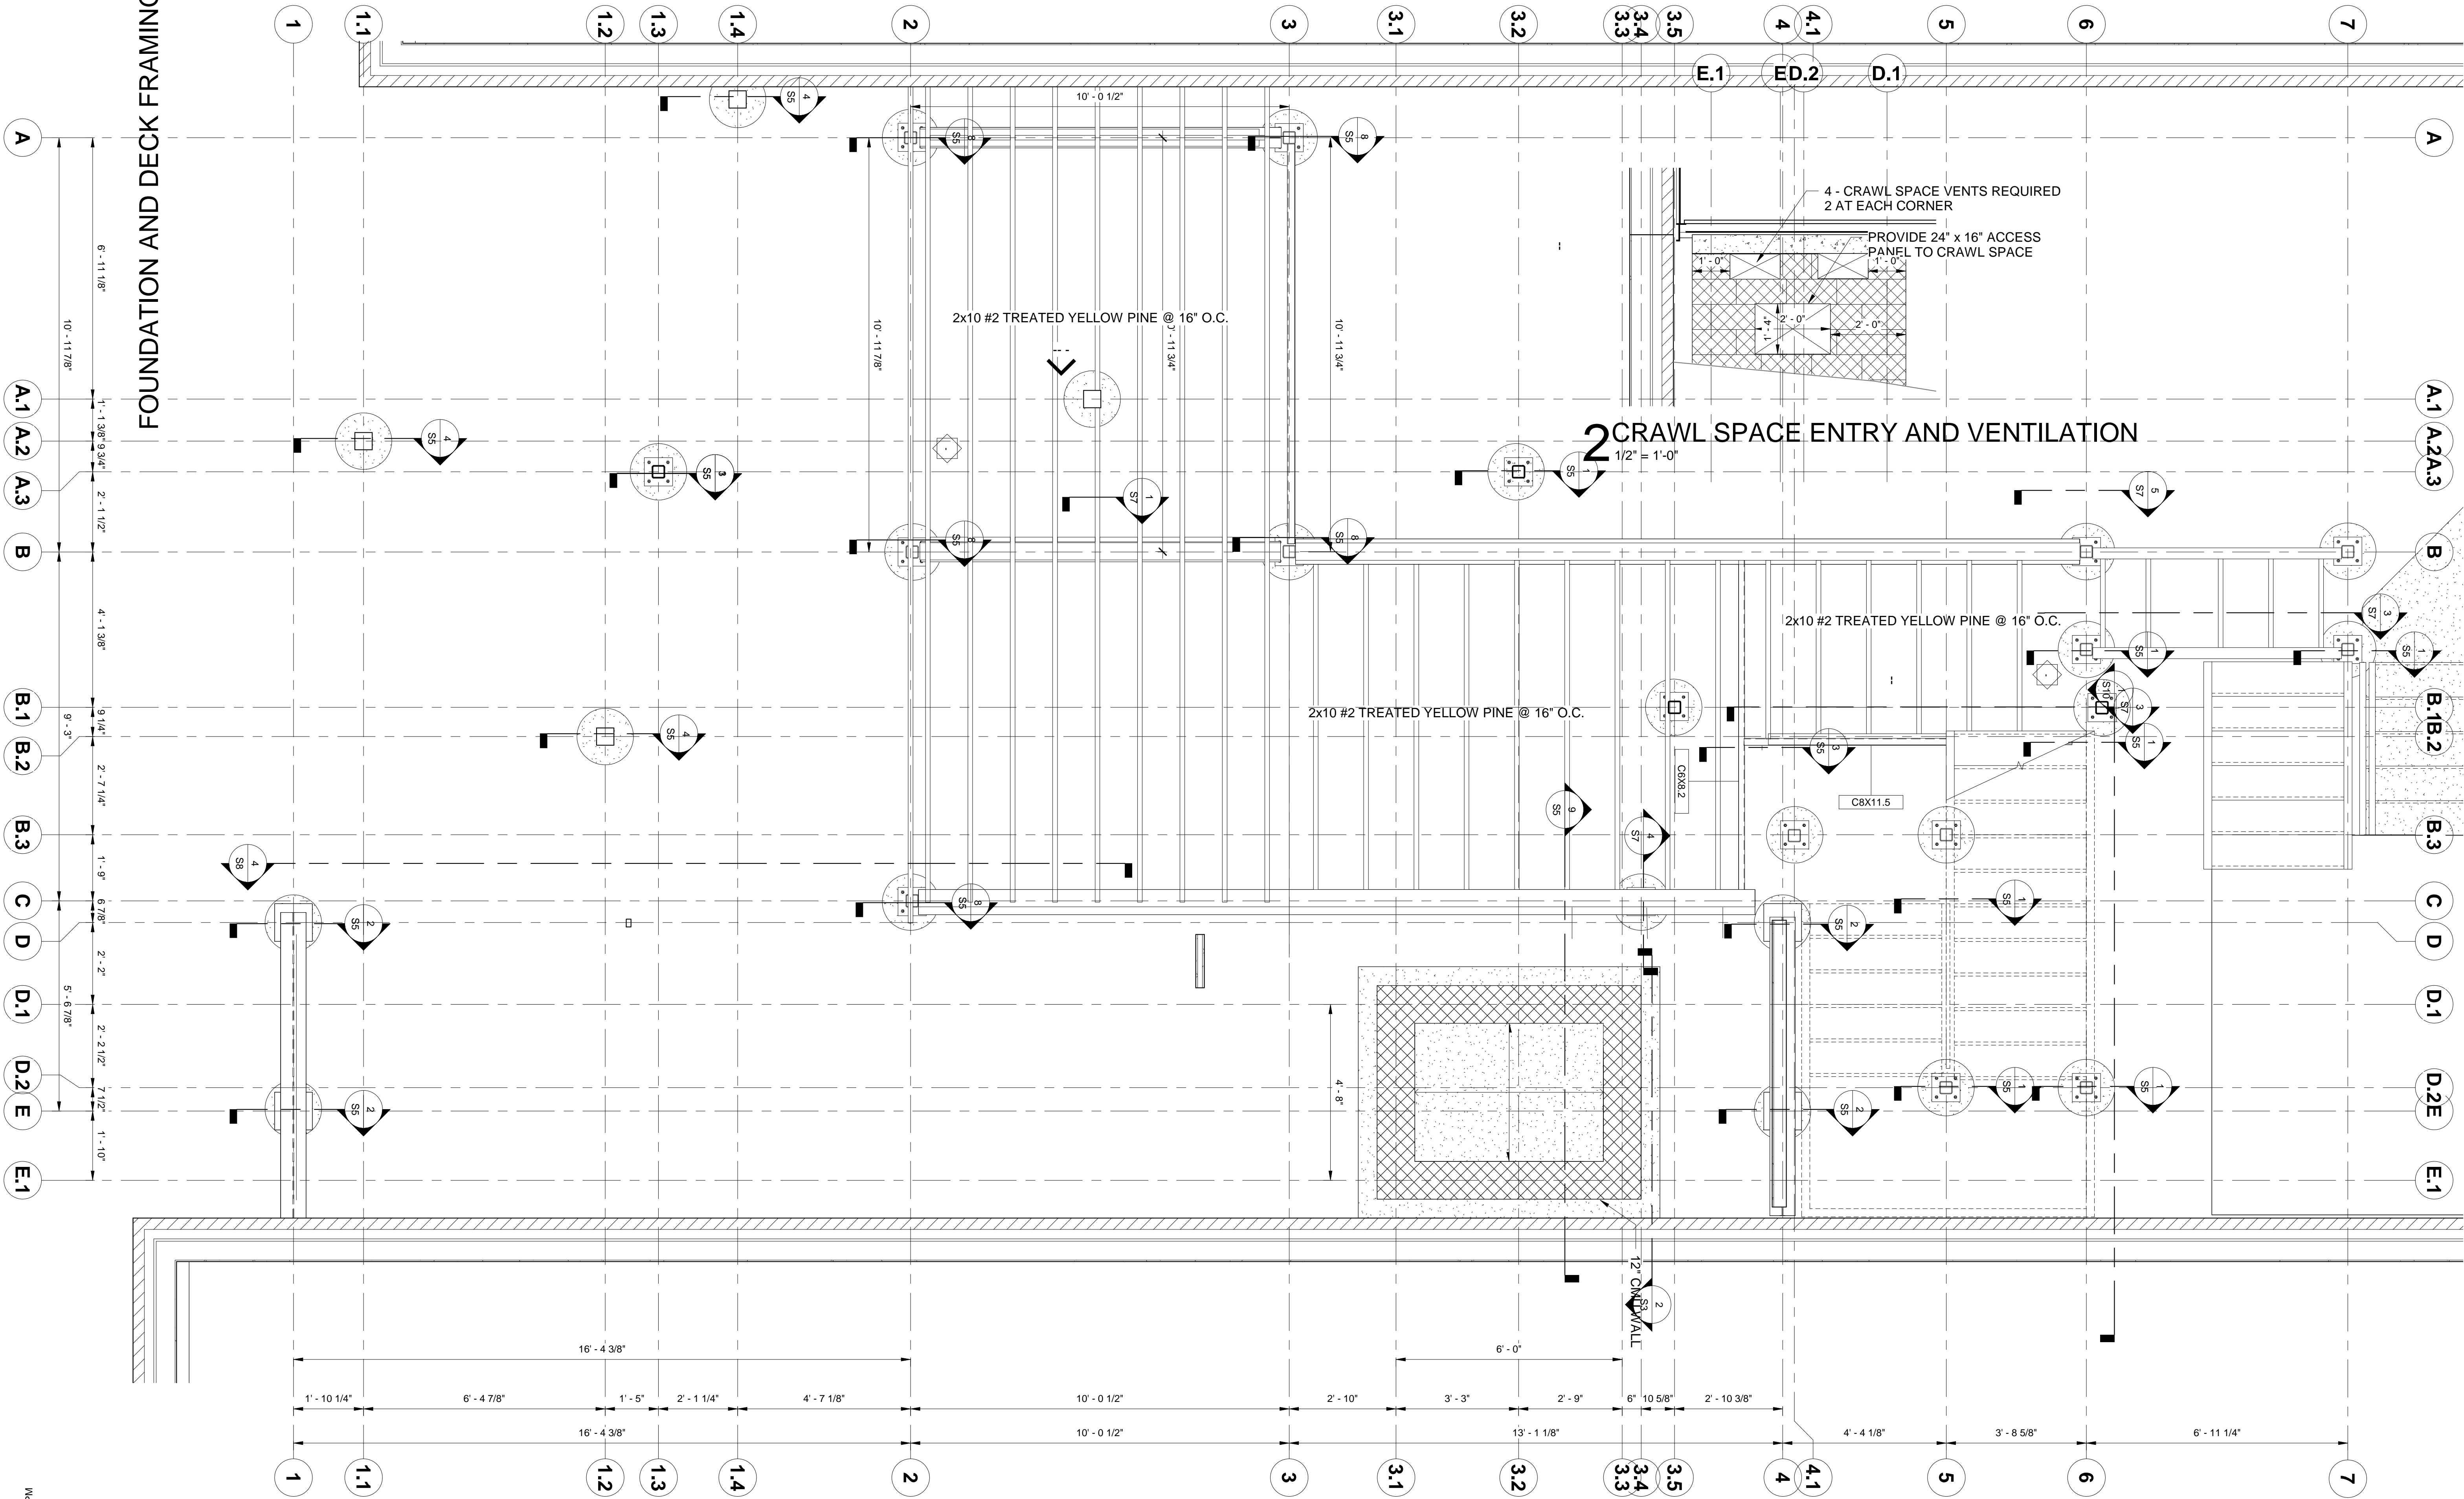

CONTAINER COFFEE SHOP  
79 SOUTH MAIN STREET  
PITTSBURGH, PA

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FOUNDATION AND DECK FRAMING PLAN

SHEET

S3  
ORIGINAL SHEET SIZE  
24" x 36"





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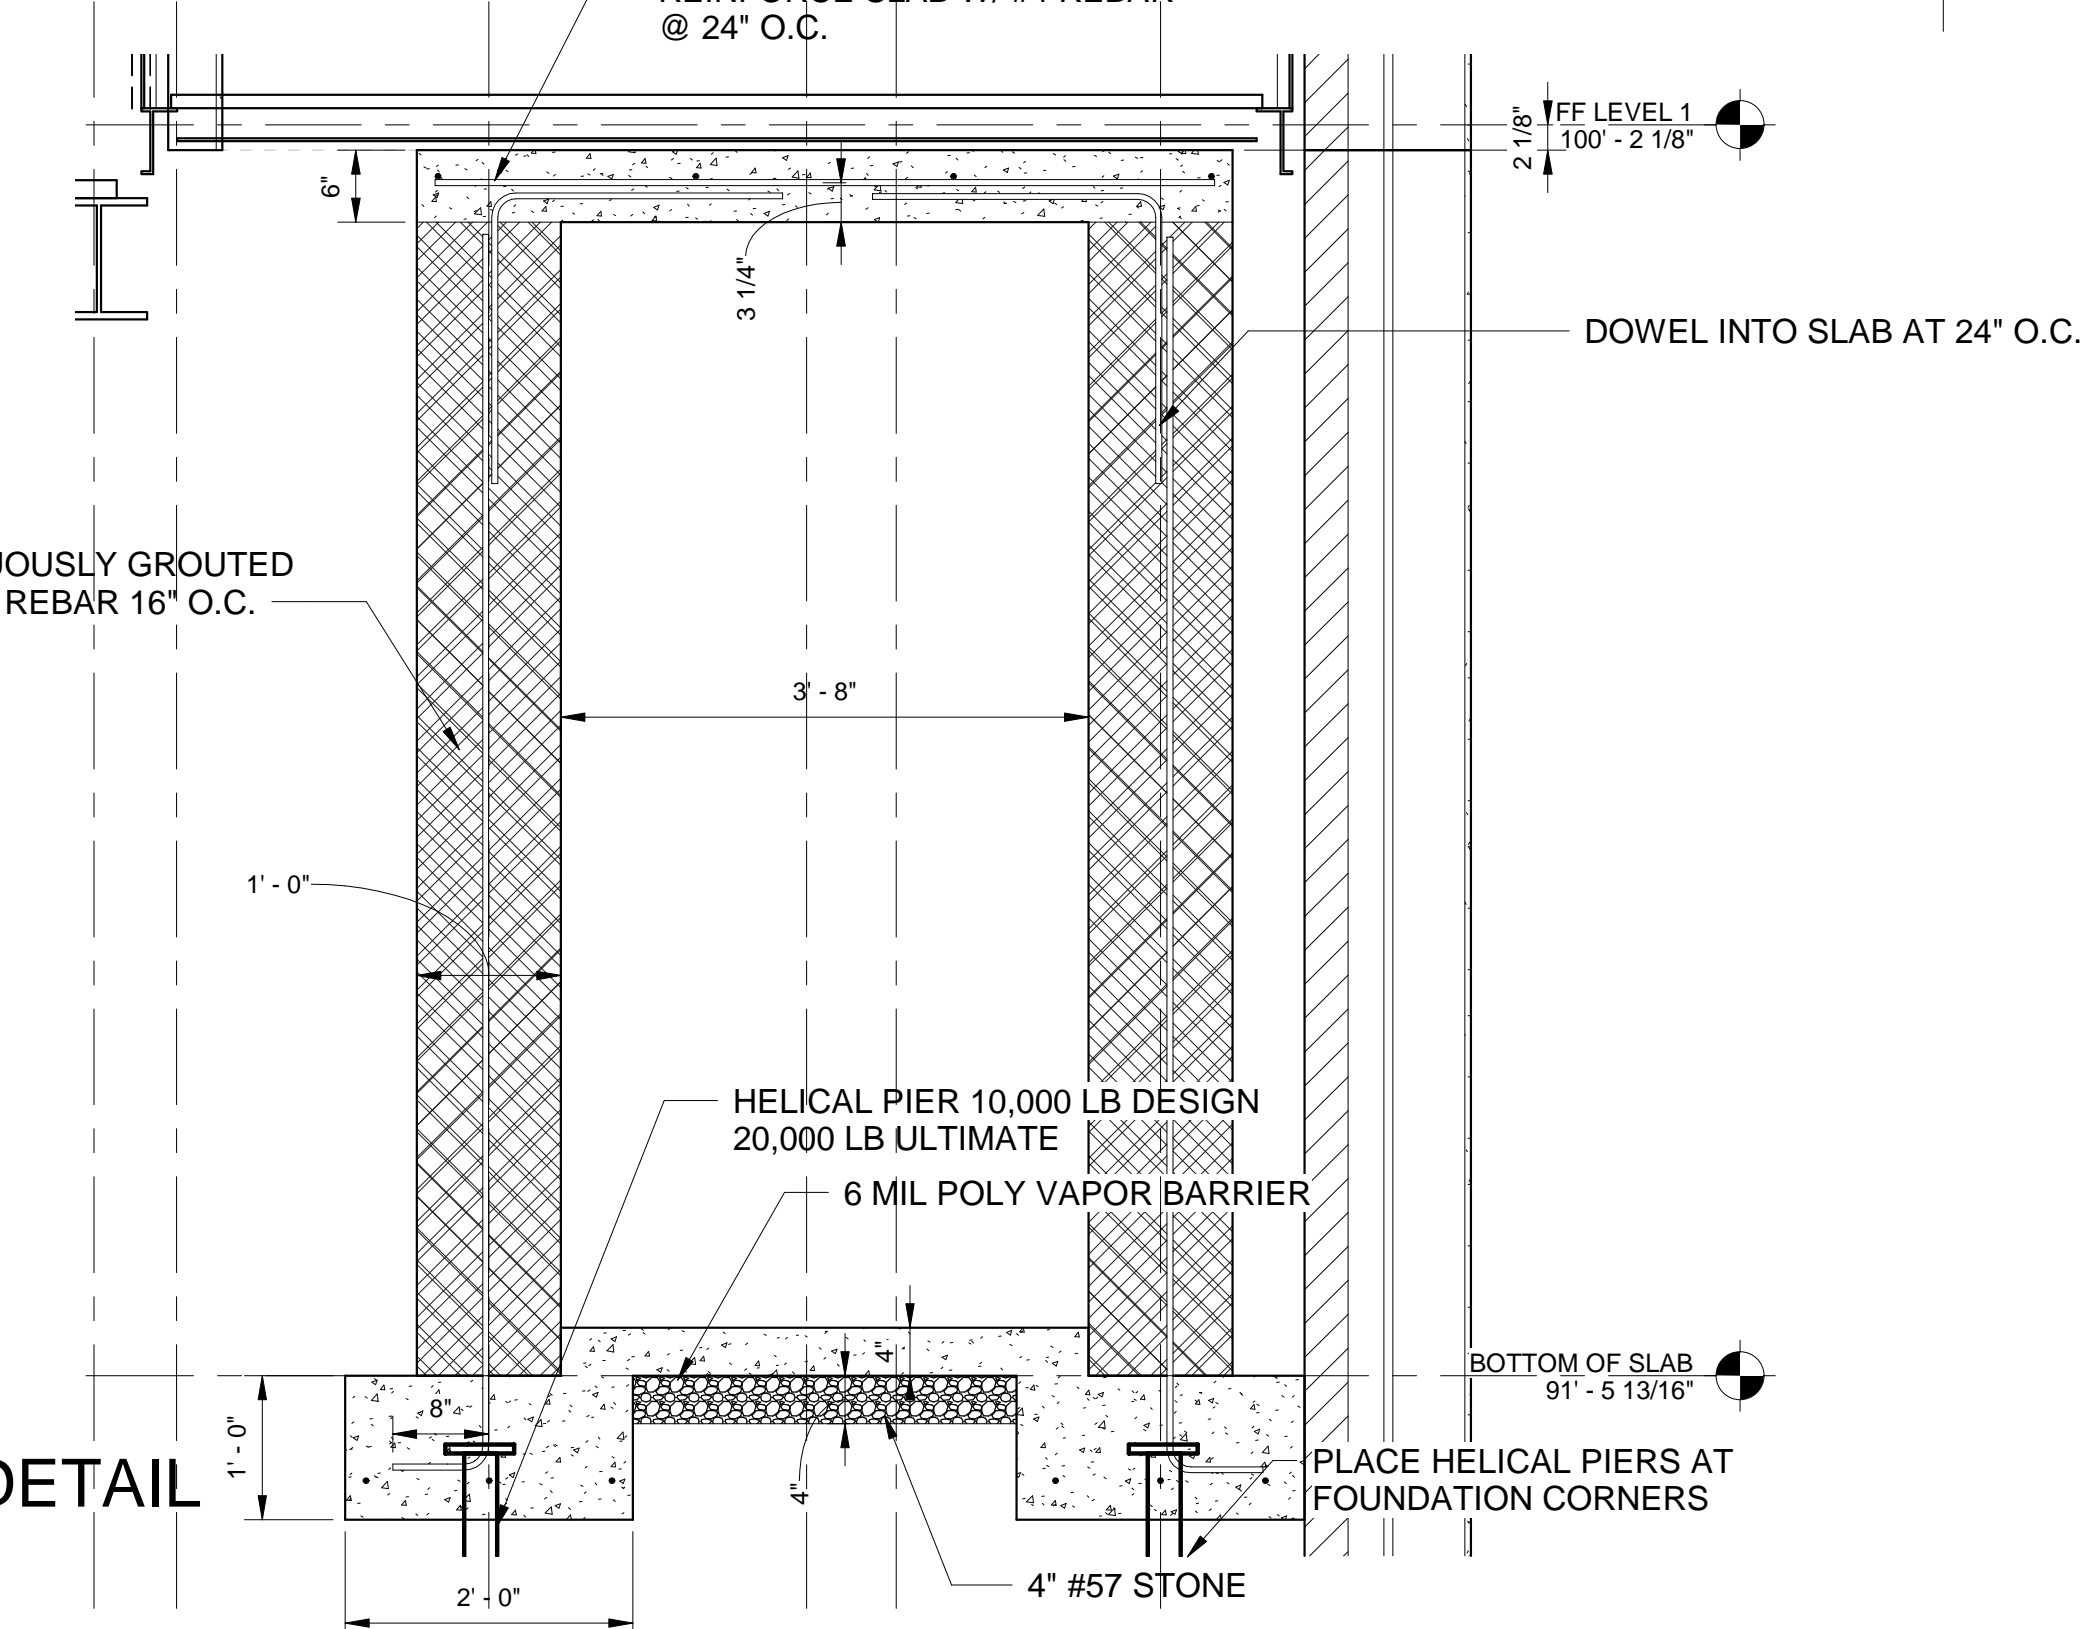
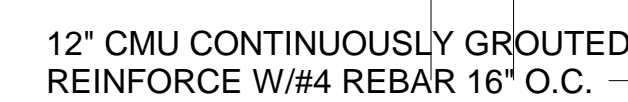
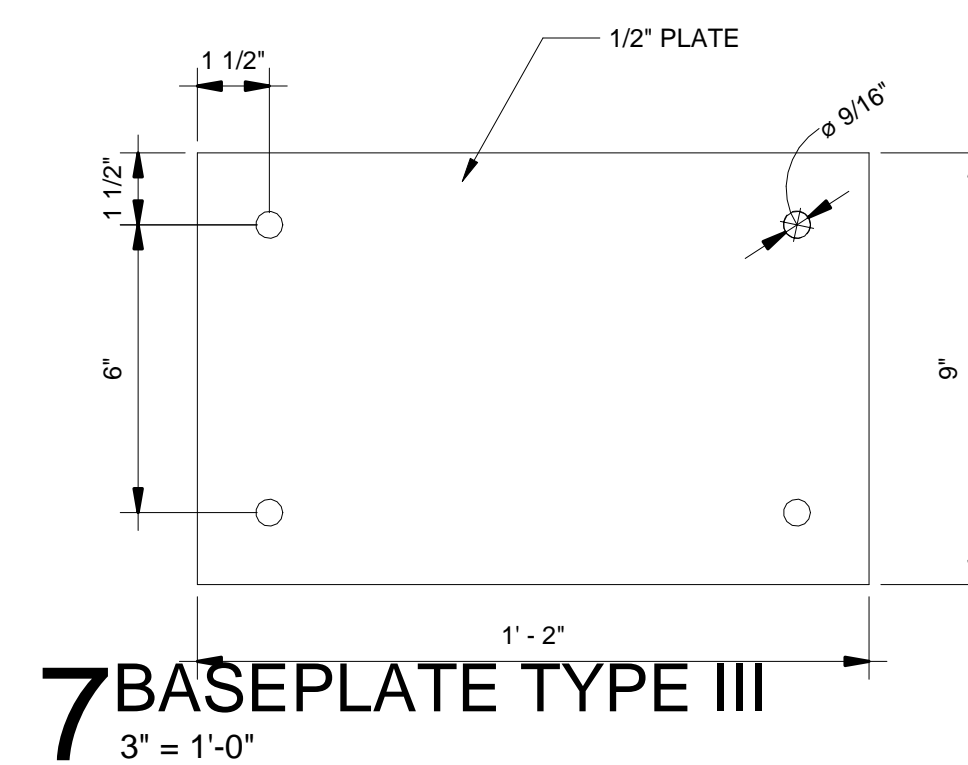
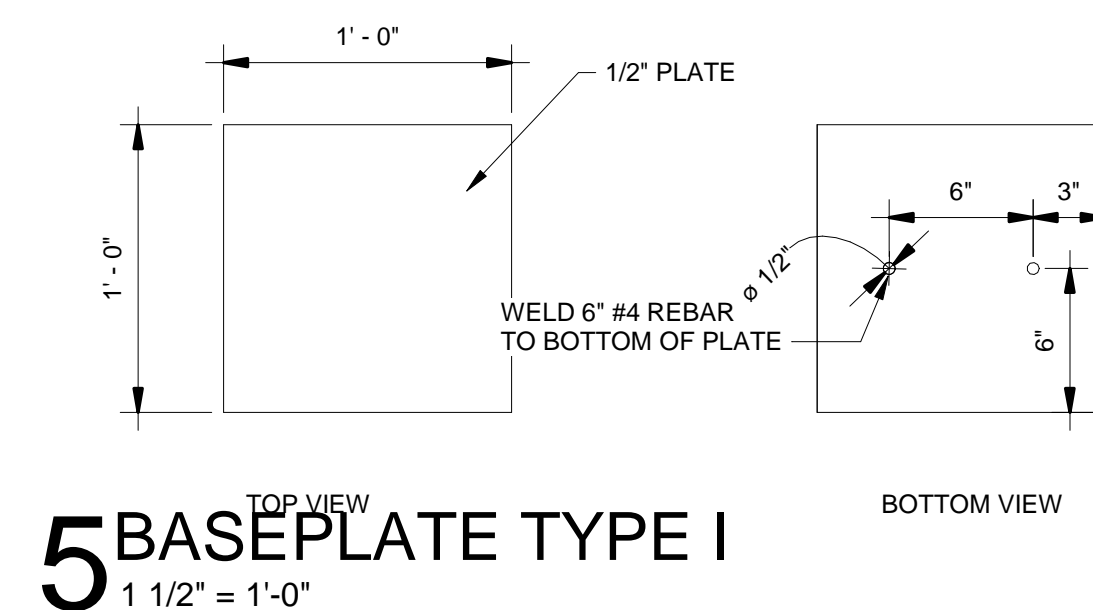
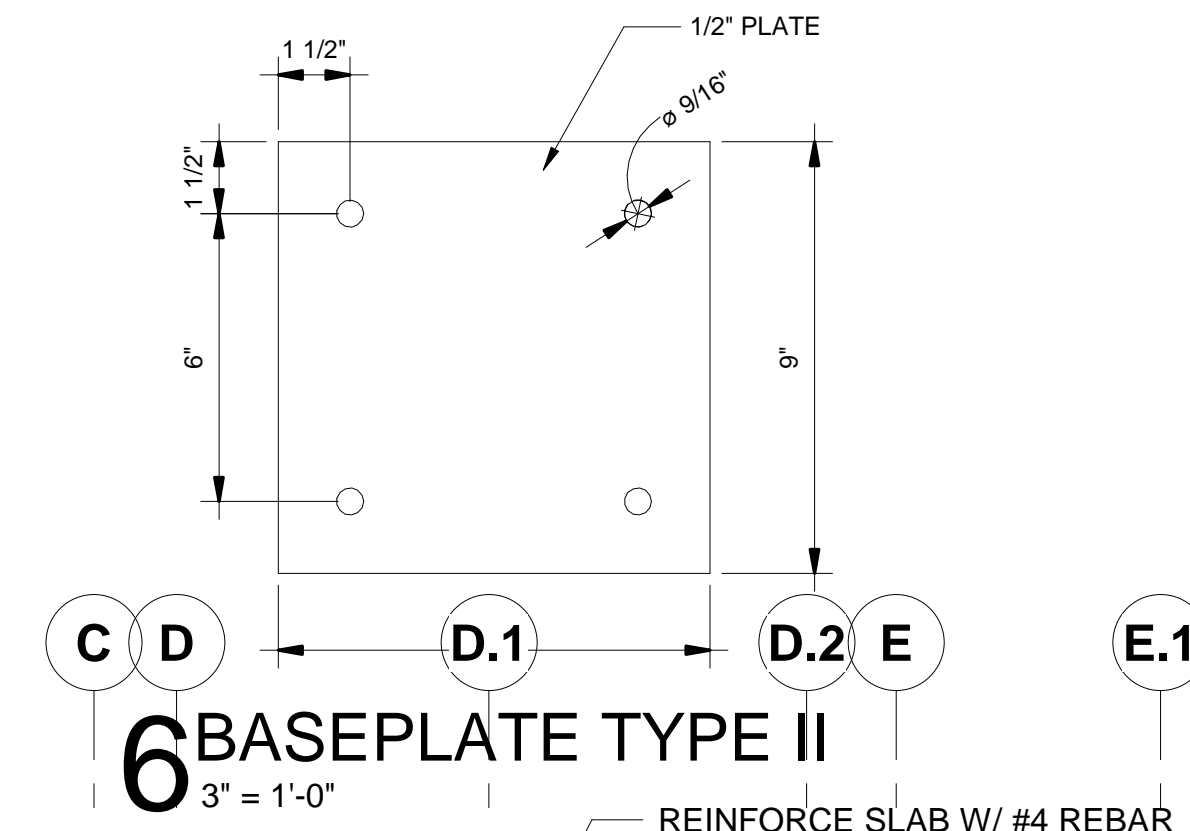
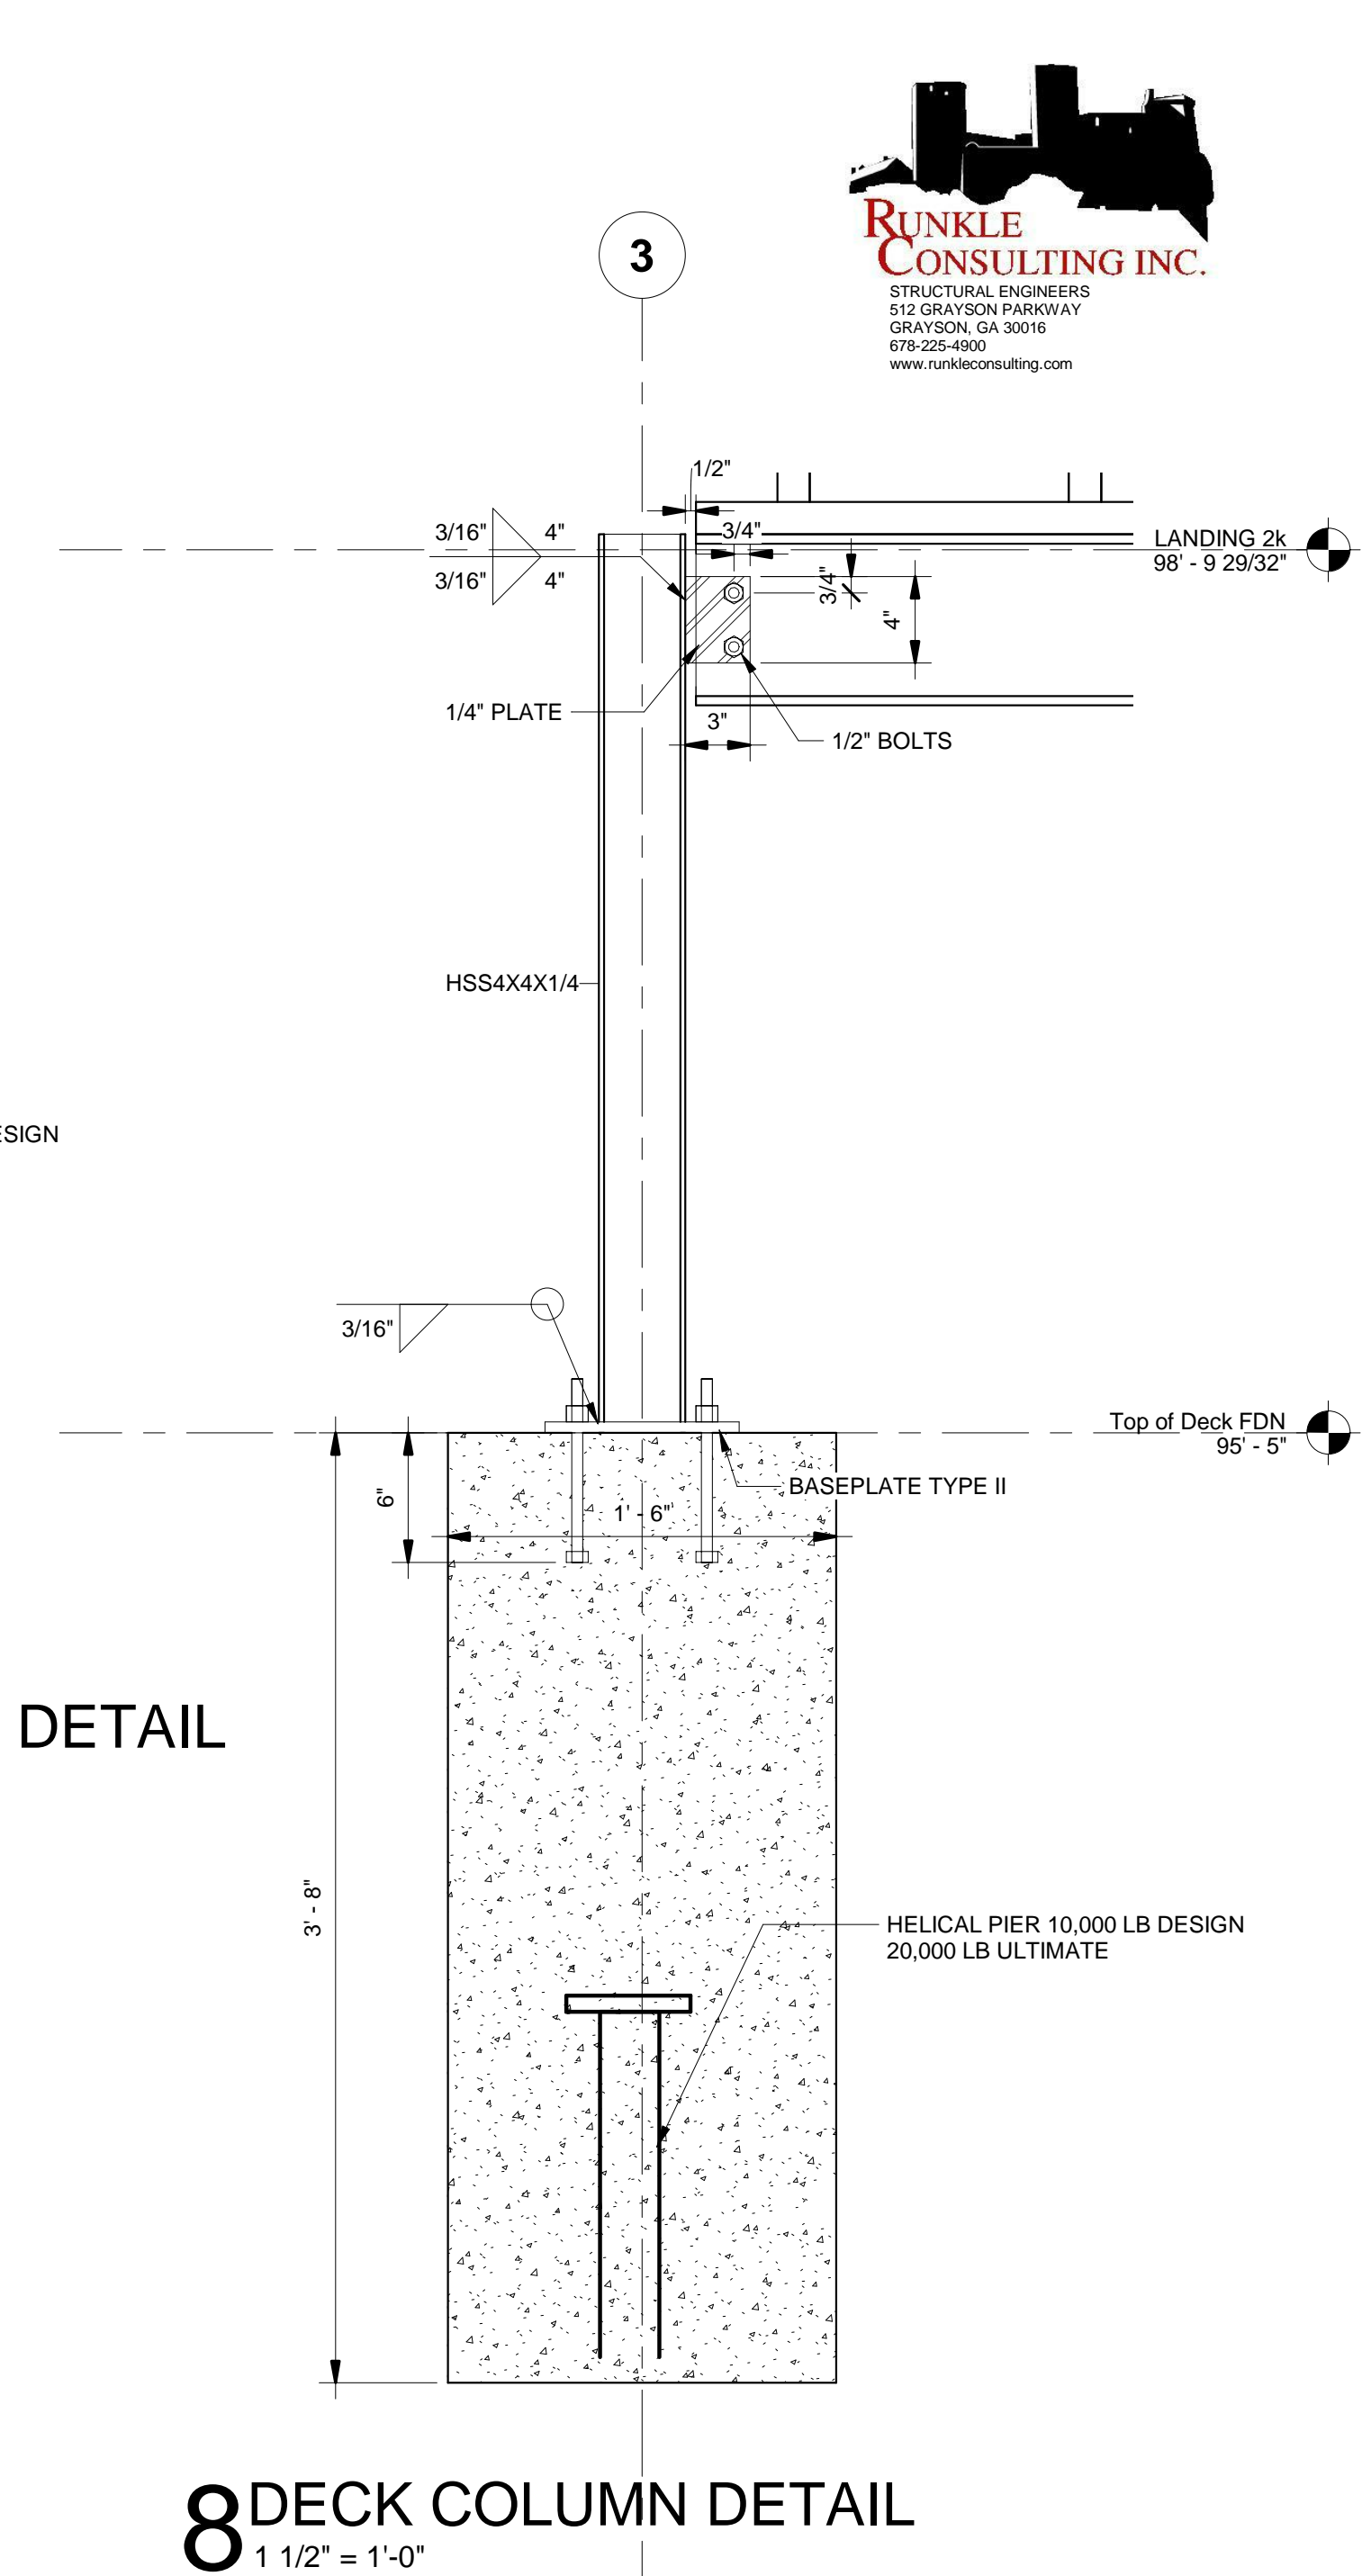
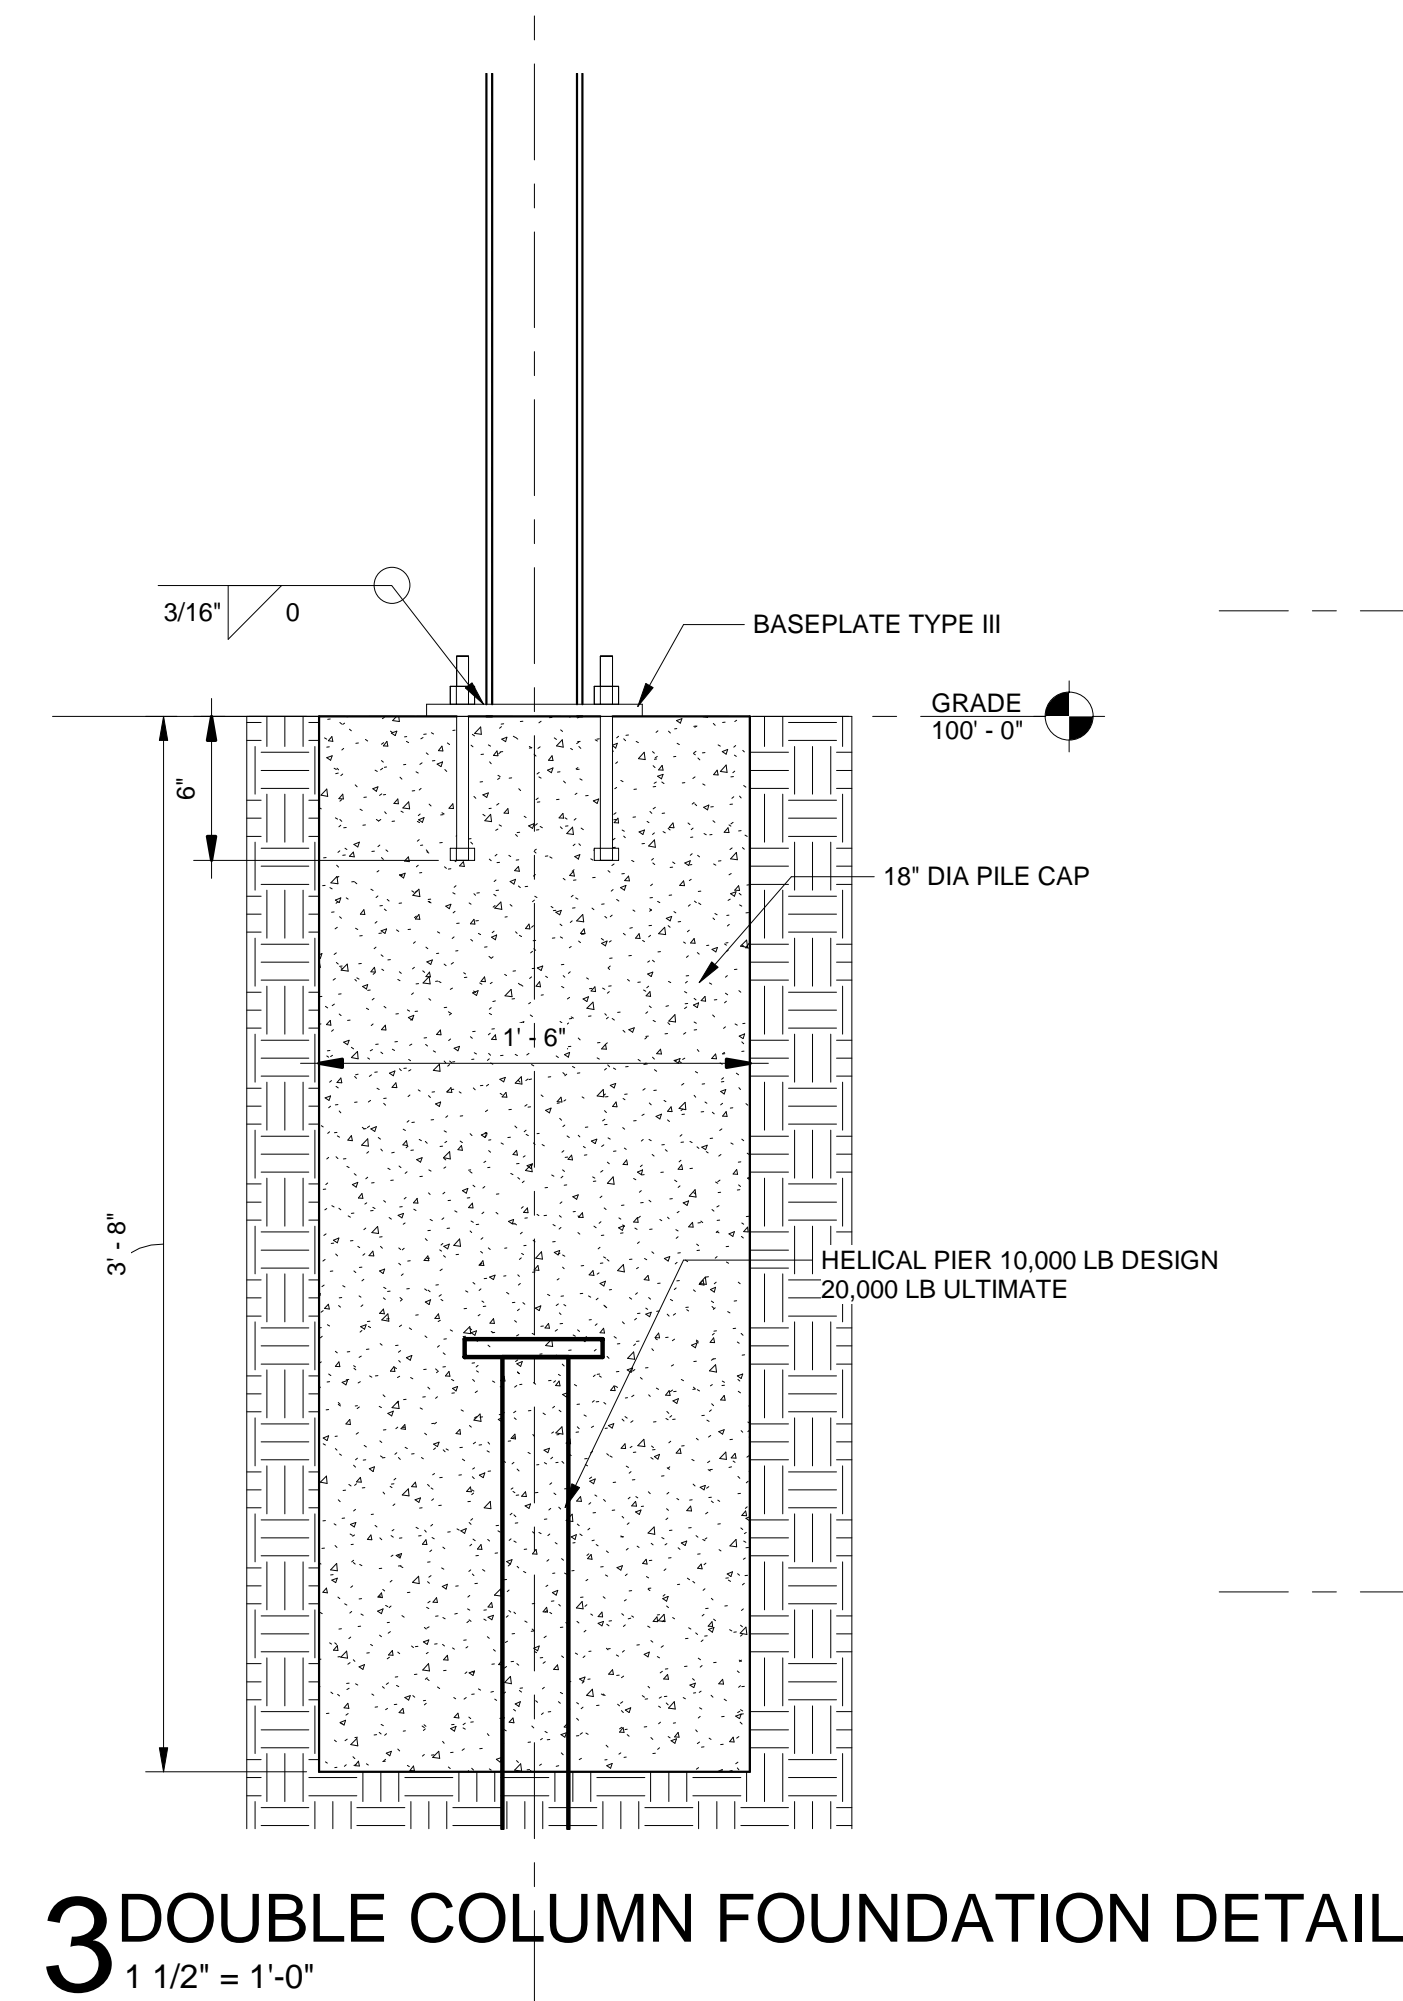
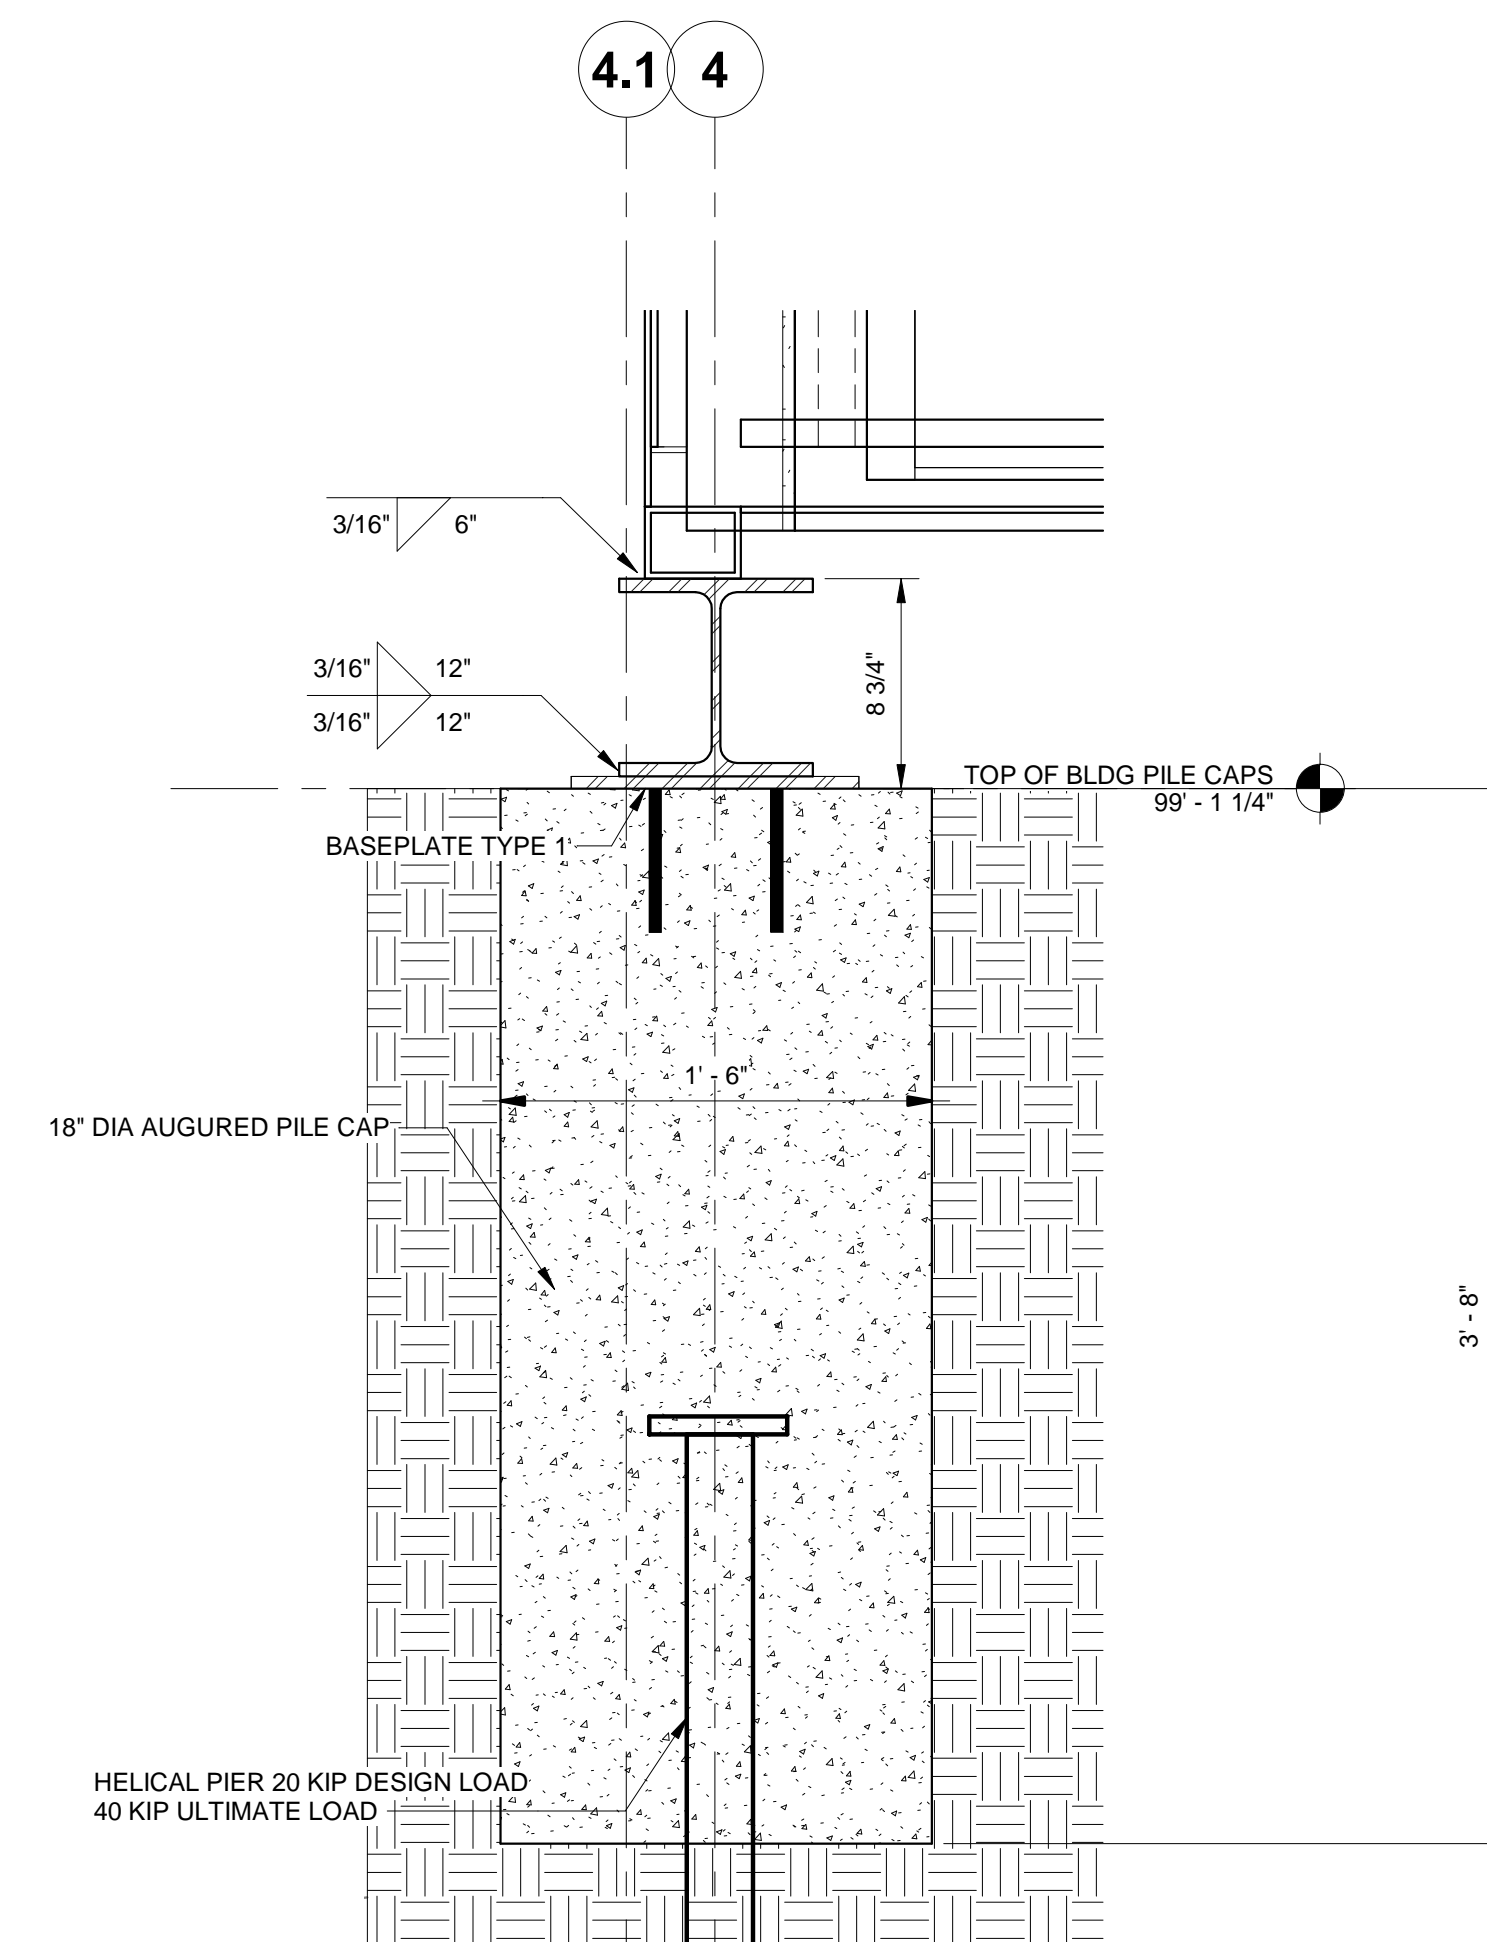
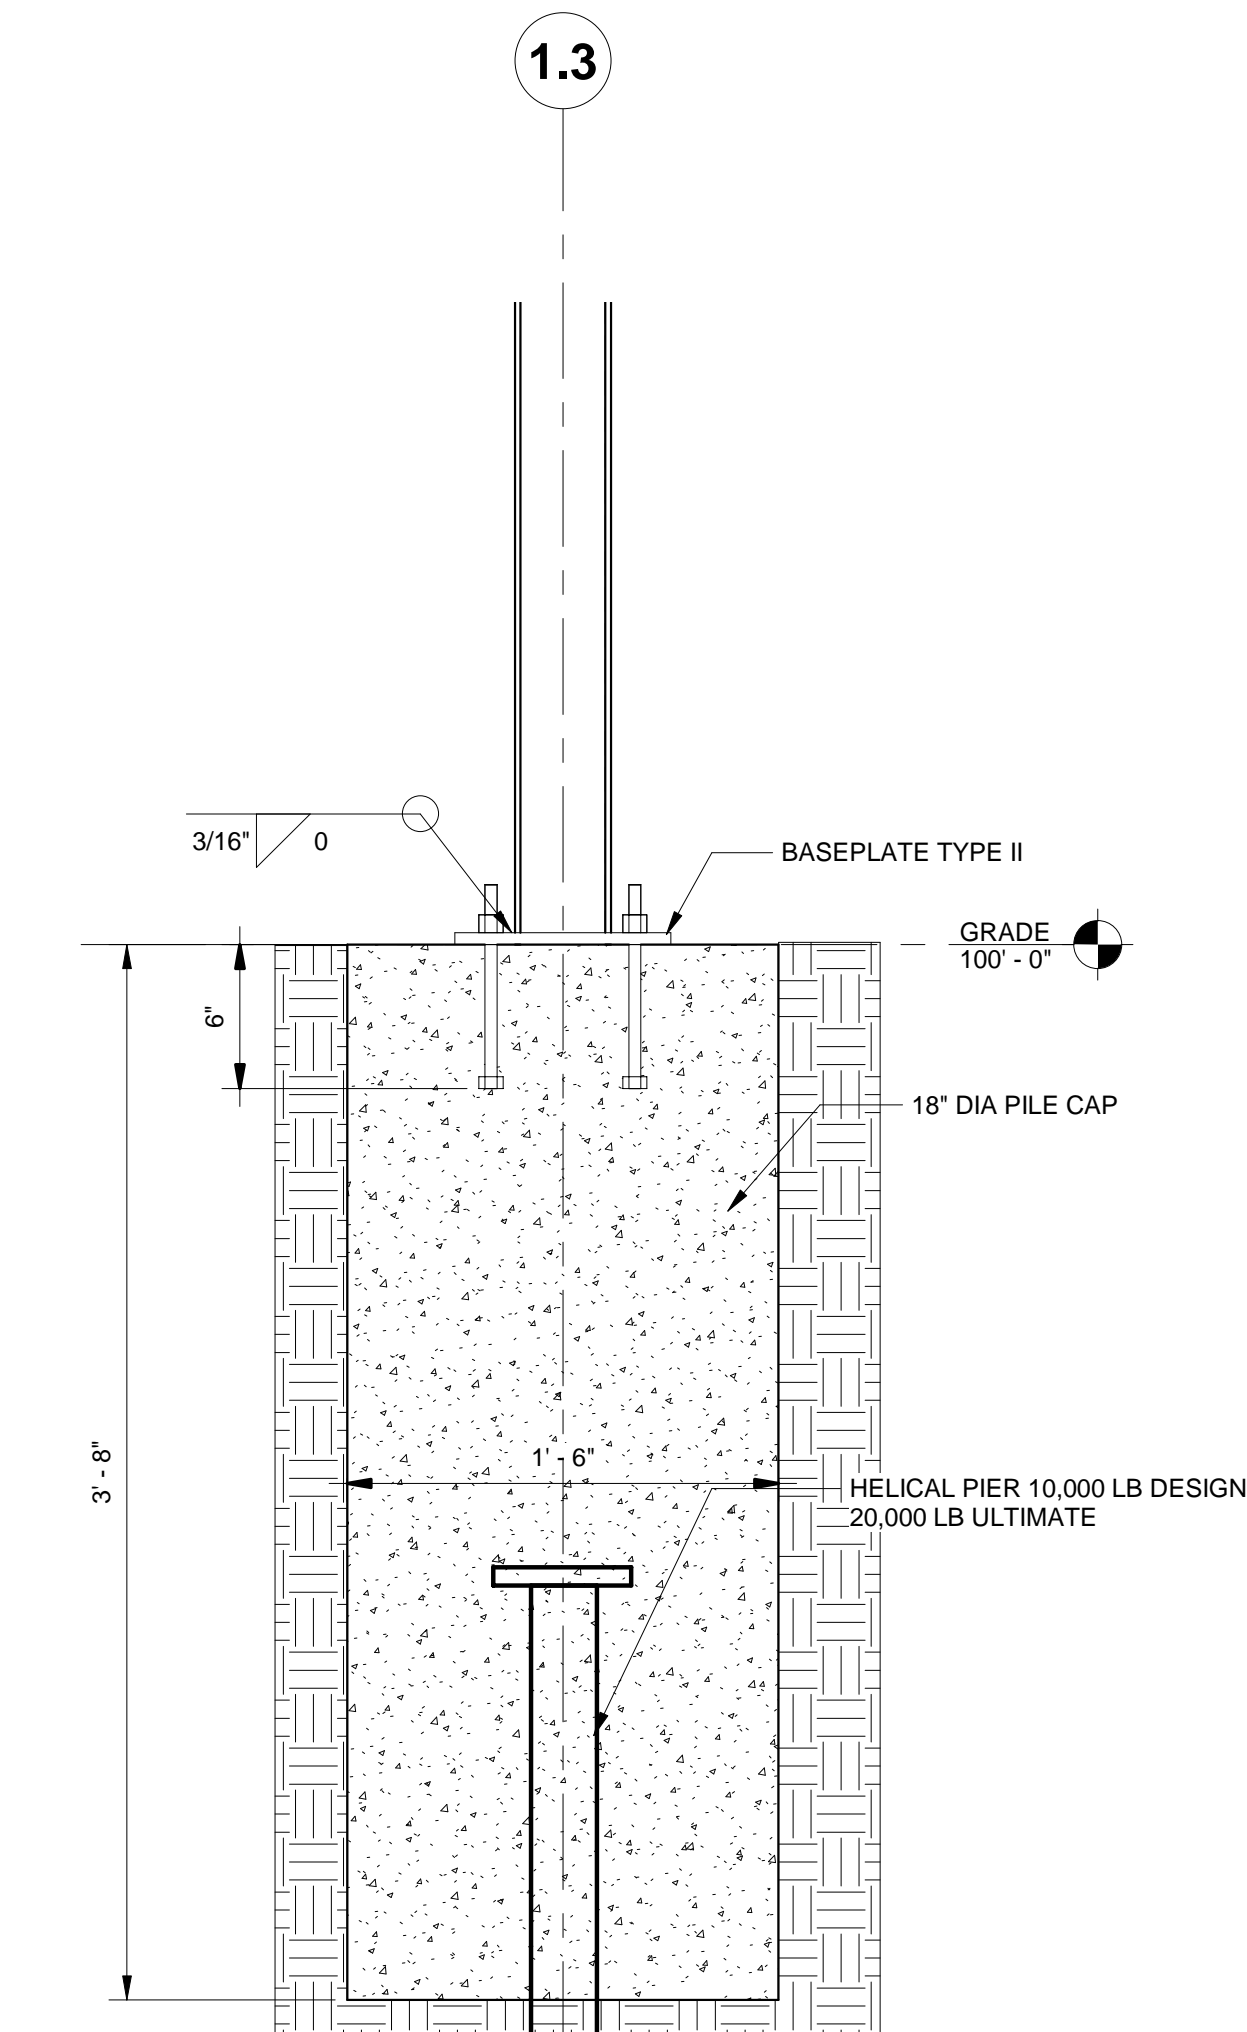
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**SHEET SECOND FLOOR FRAMING**

SHEET

**S4**  
ORIGINAL SHEET SIZE  
24" x 36"





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SHEET TITLE

**FOUNDATION  
DETAILS**


SHEET

# S5

ORIGINAL SHEET SIZE  
24" x 36"




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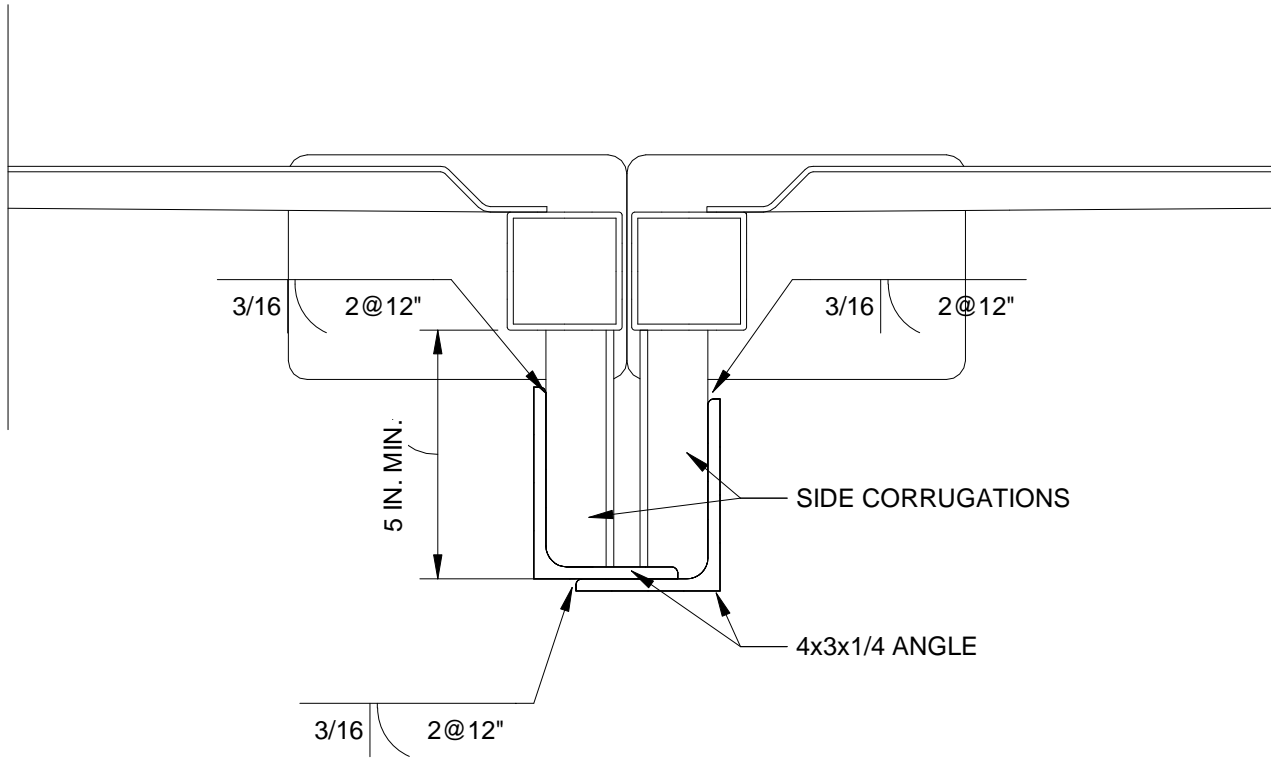
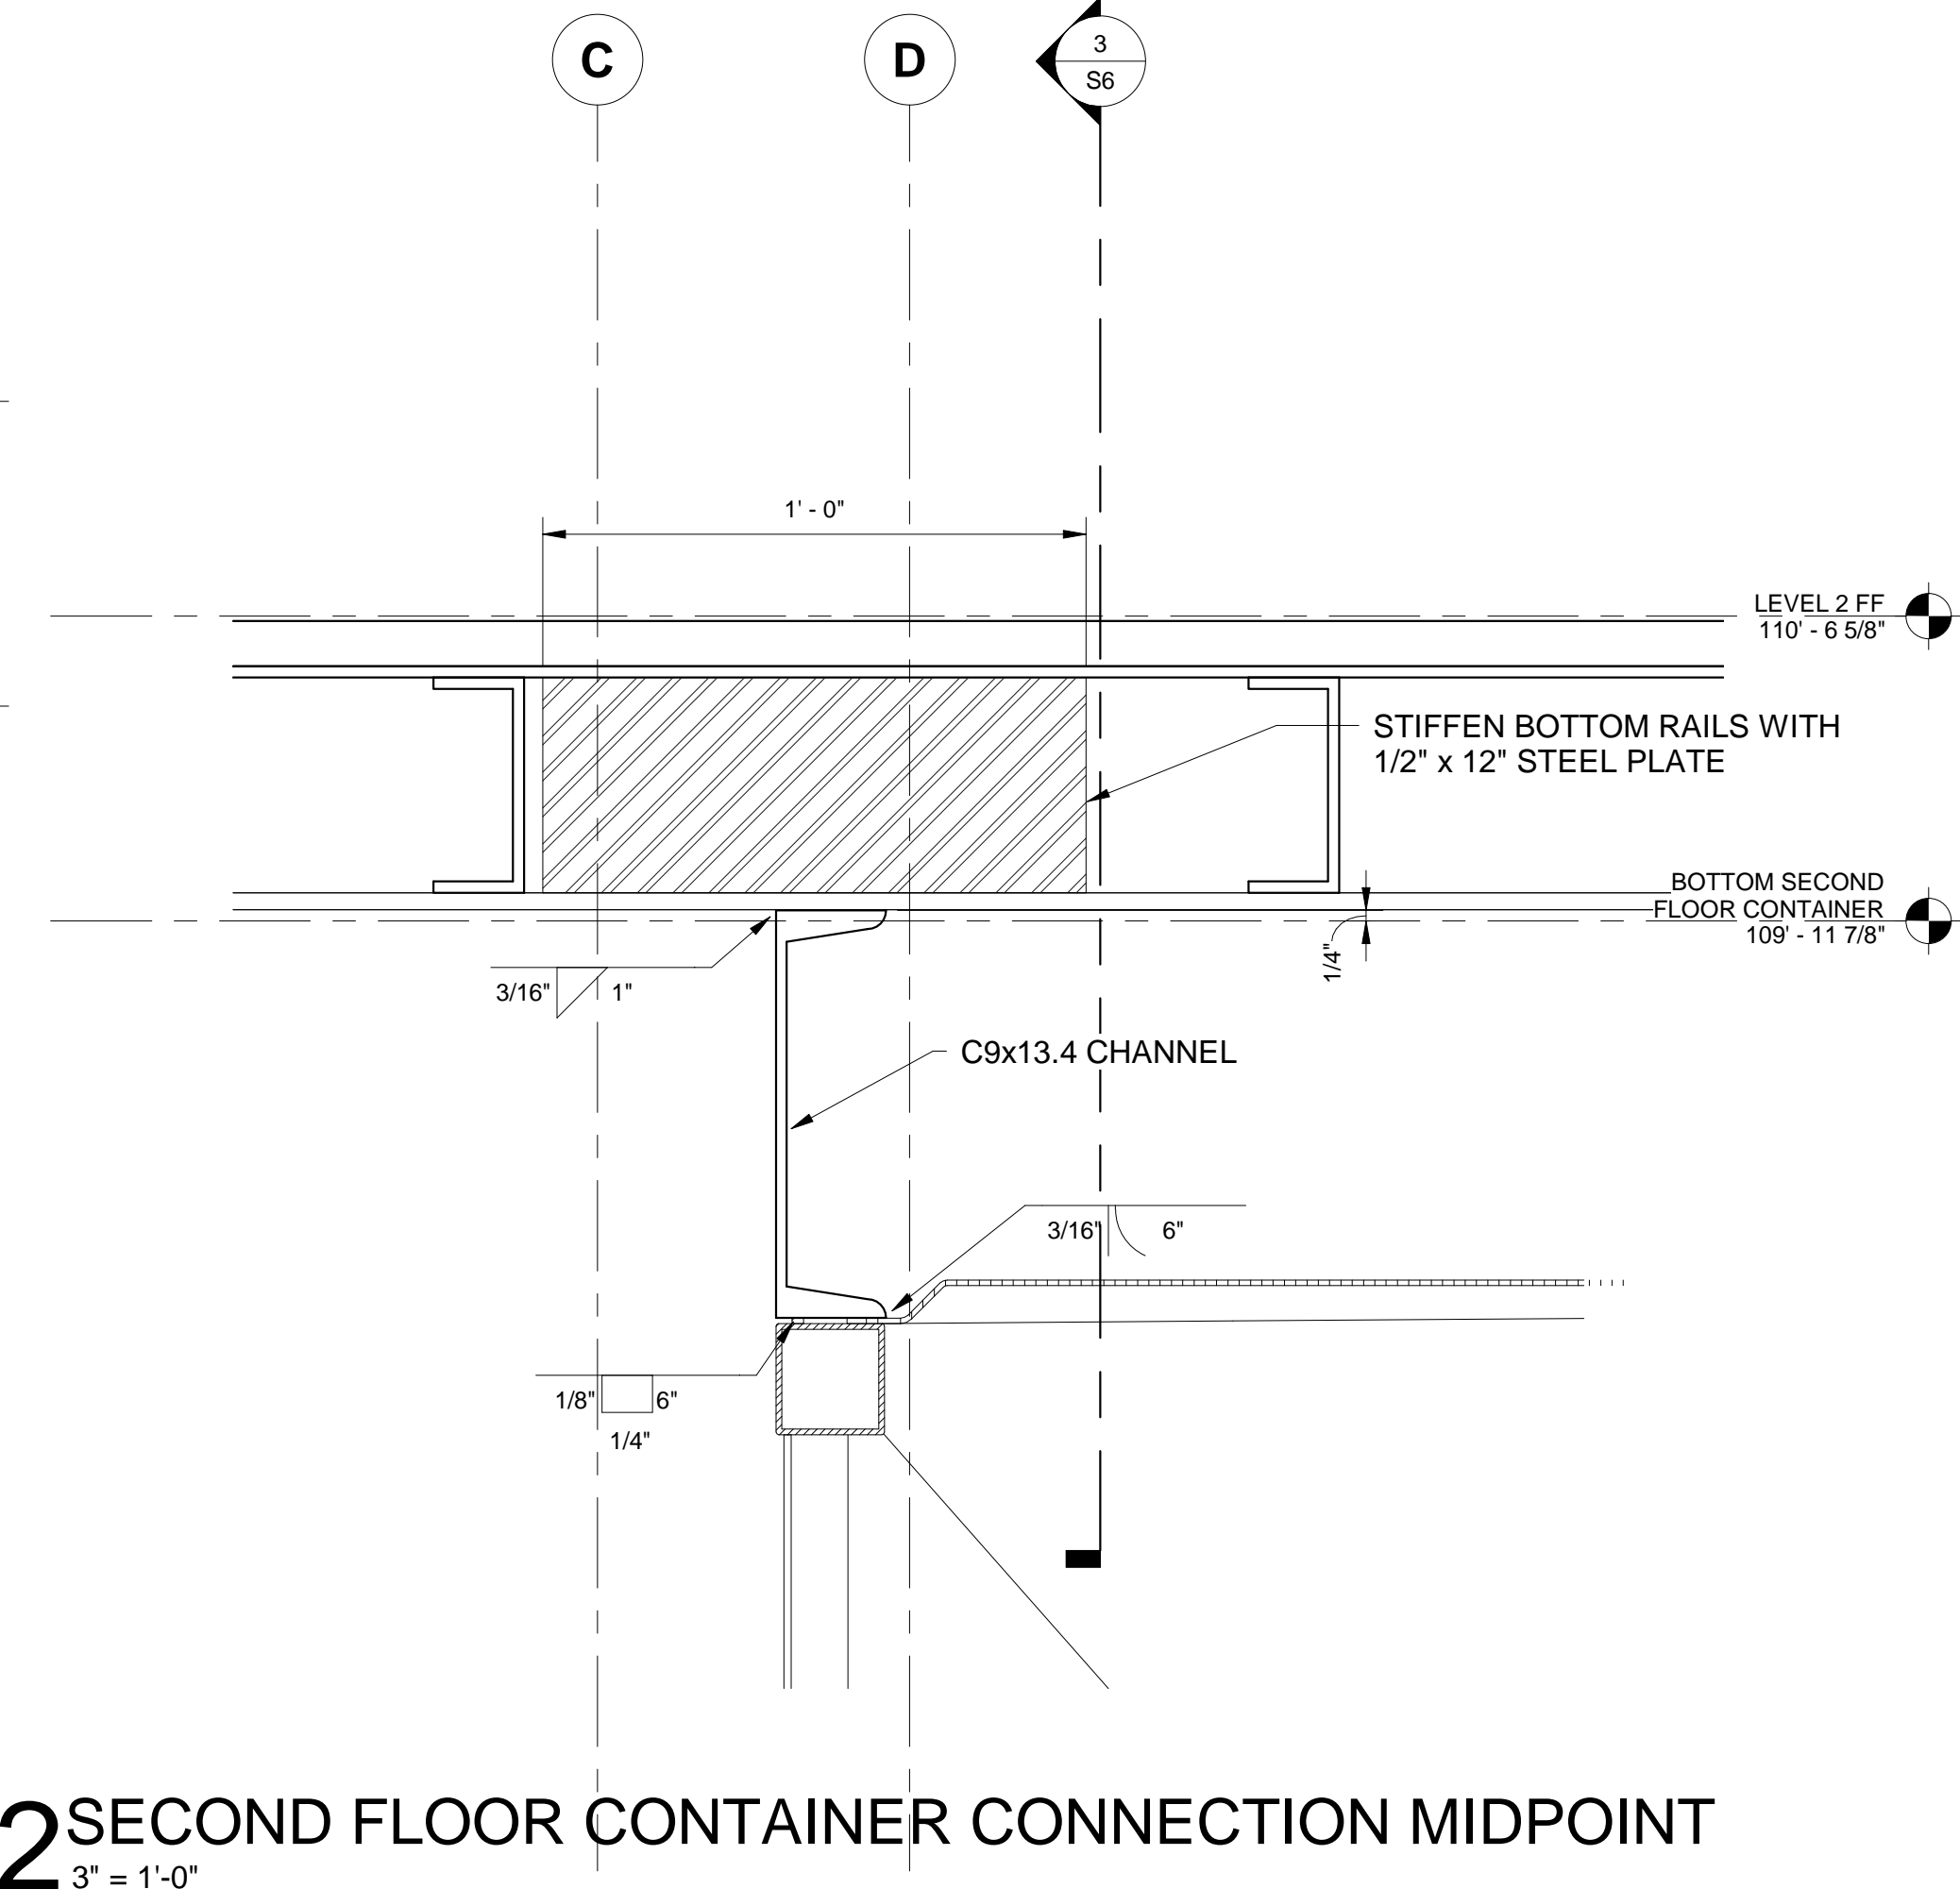


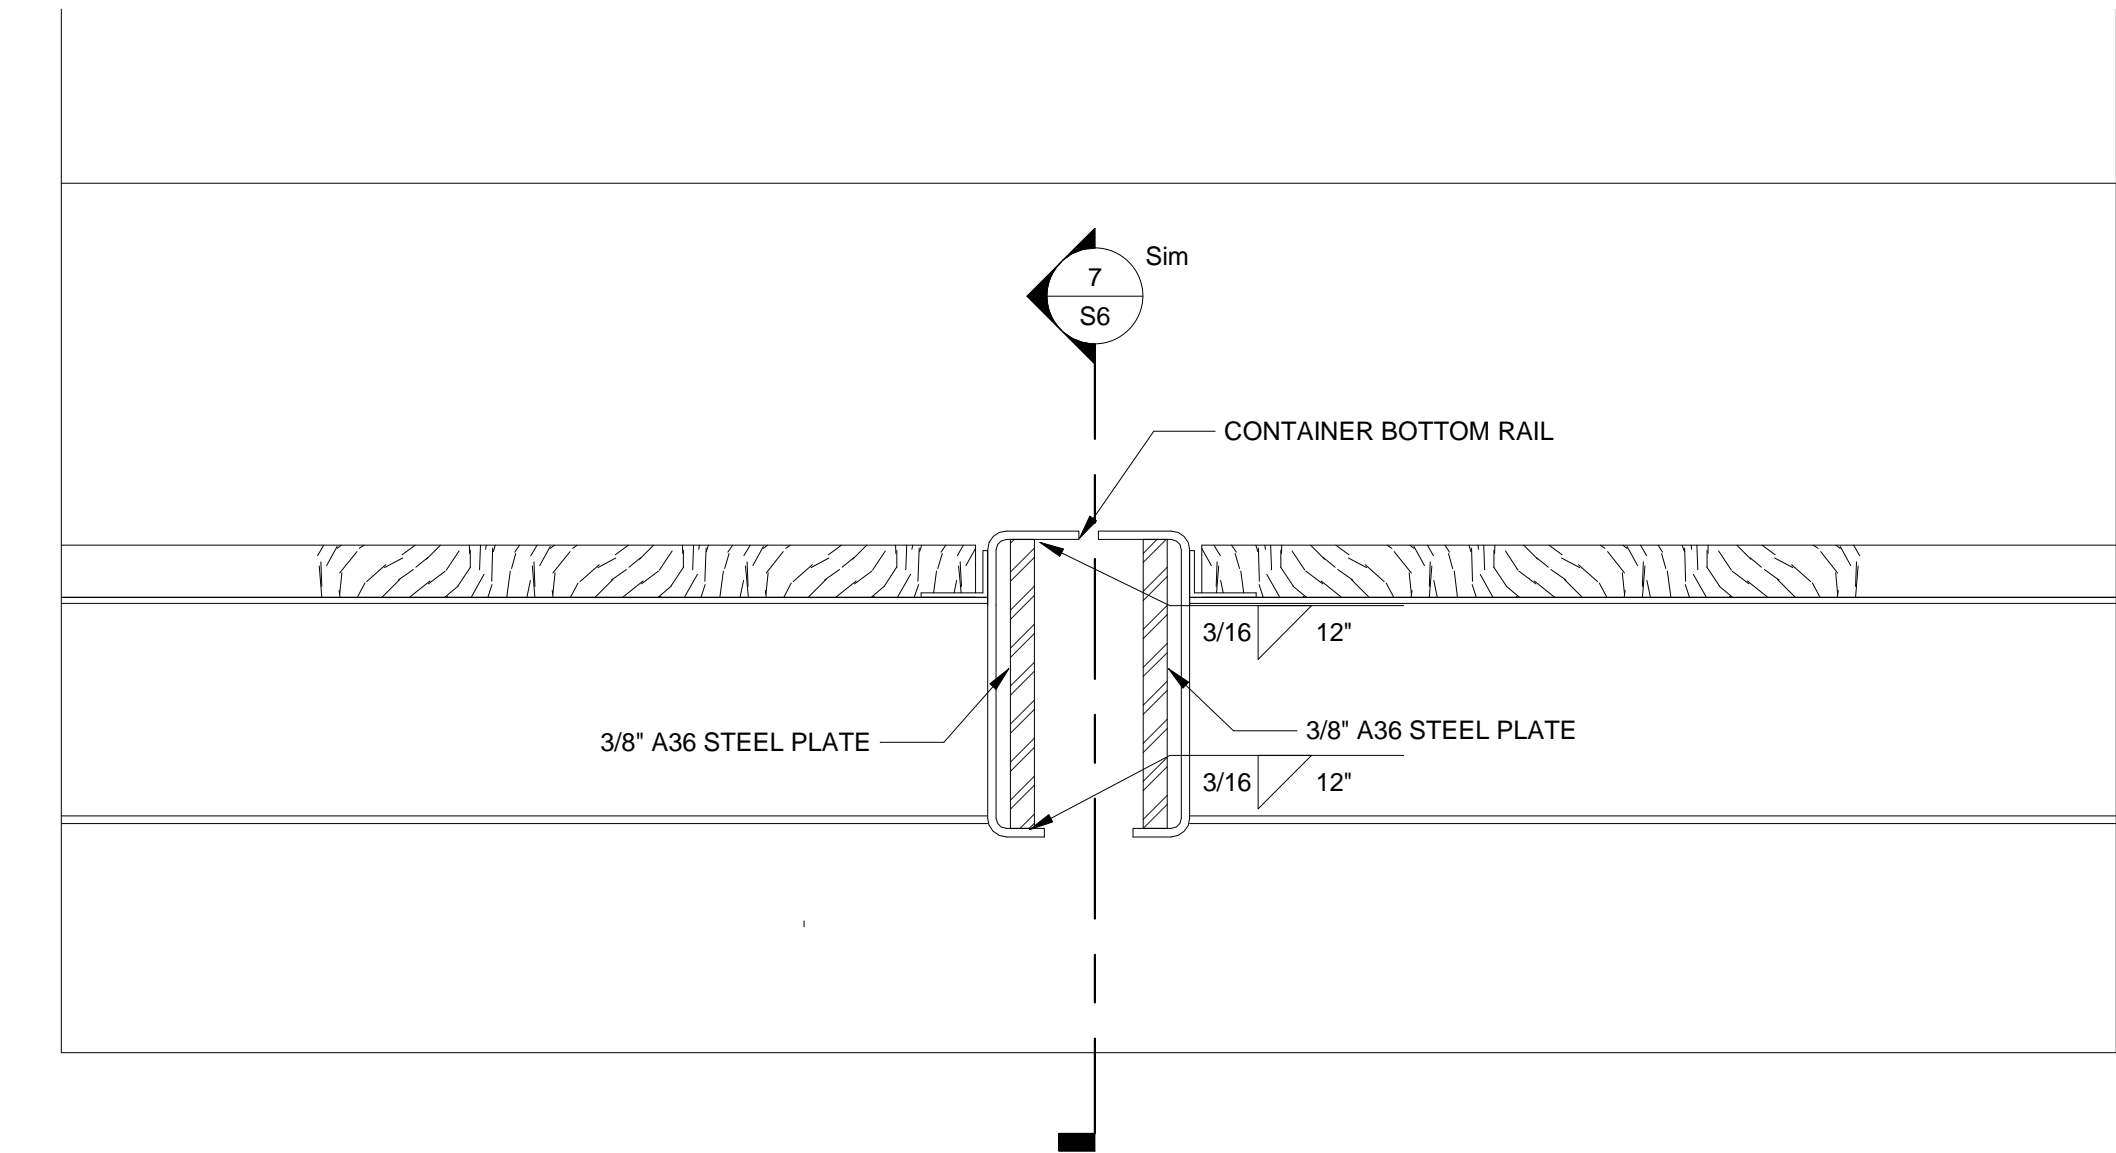**4** STIFFEN BOTTOM RAIL AT OVERHANG  
3" = 1'-0"


**1** SECOND FLOOR CONTAINER CONNECTION AT REAR  
3" = 1'-0"

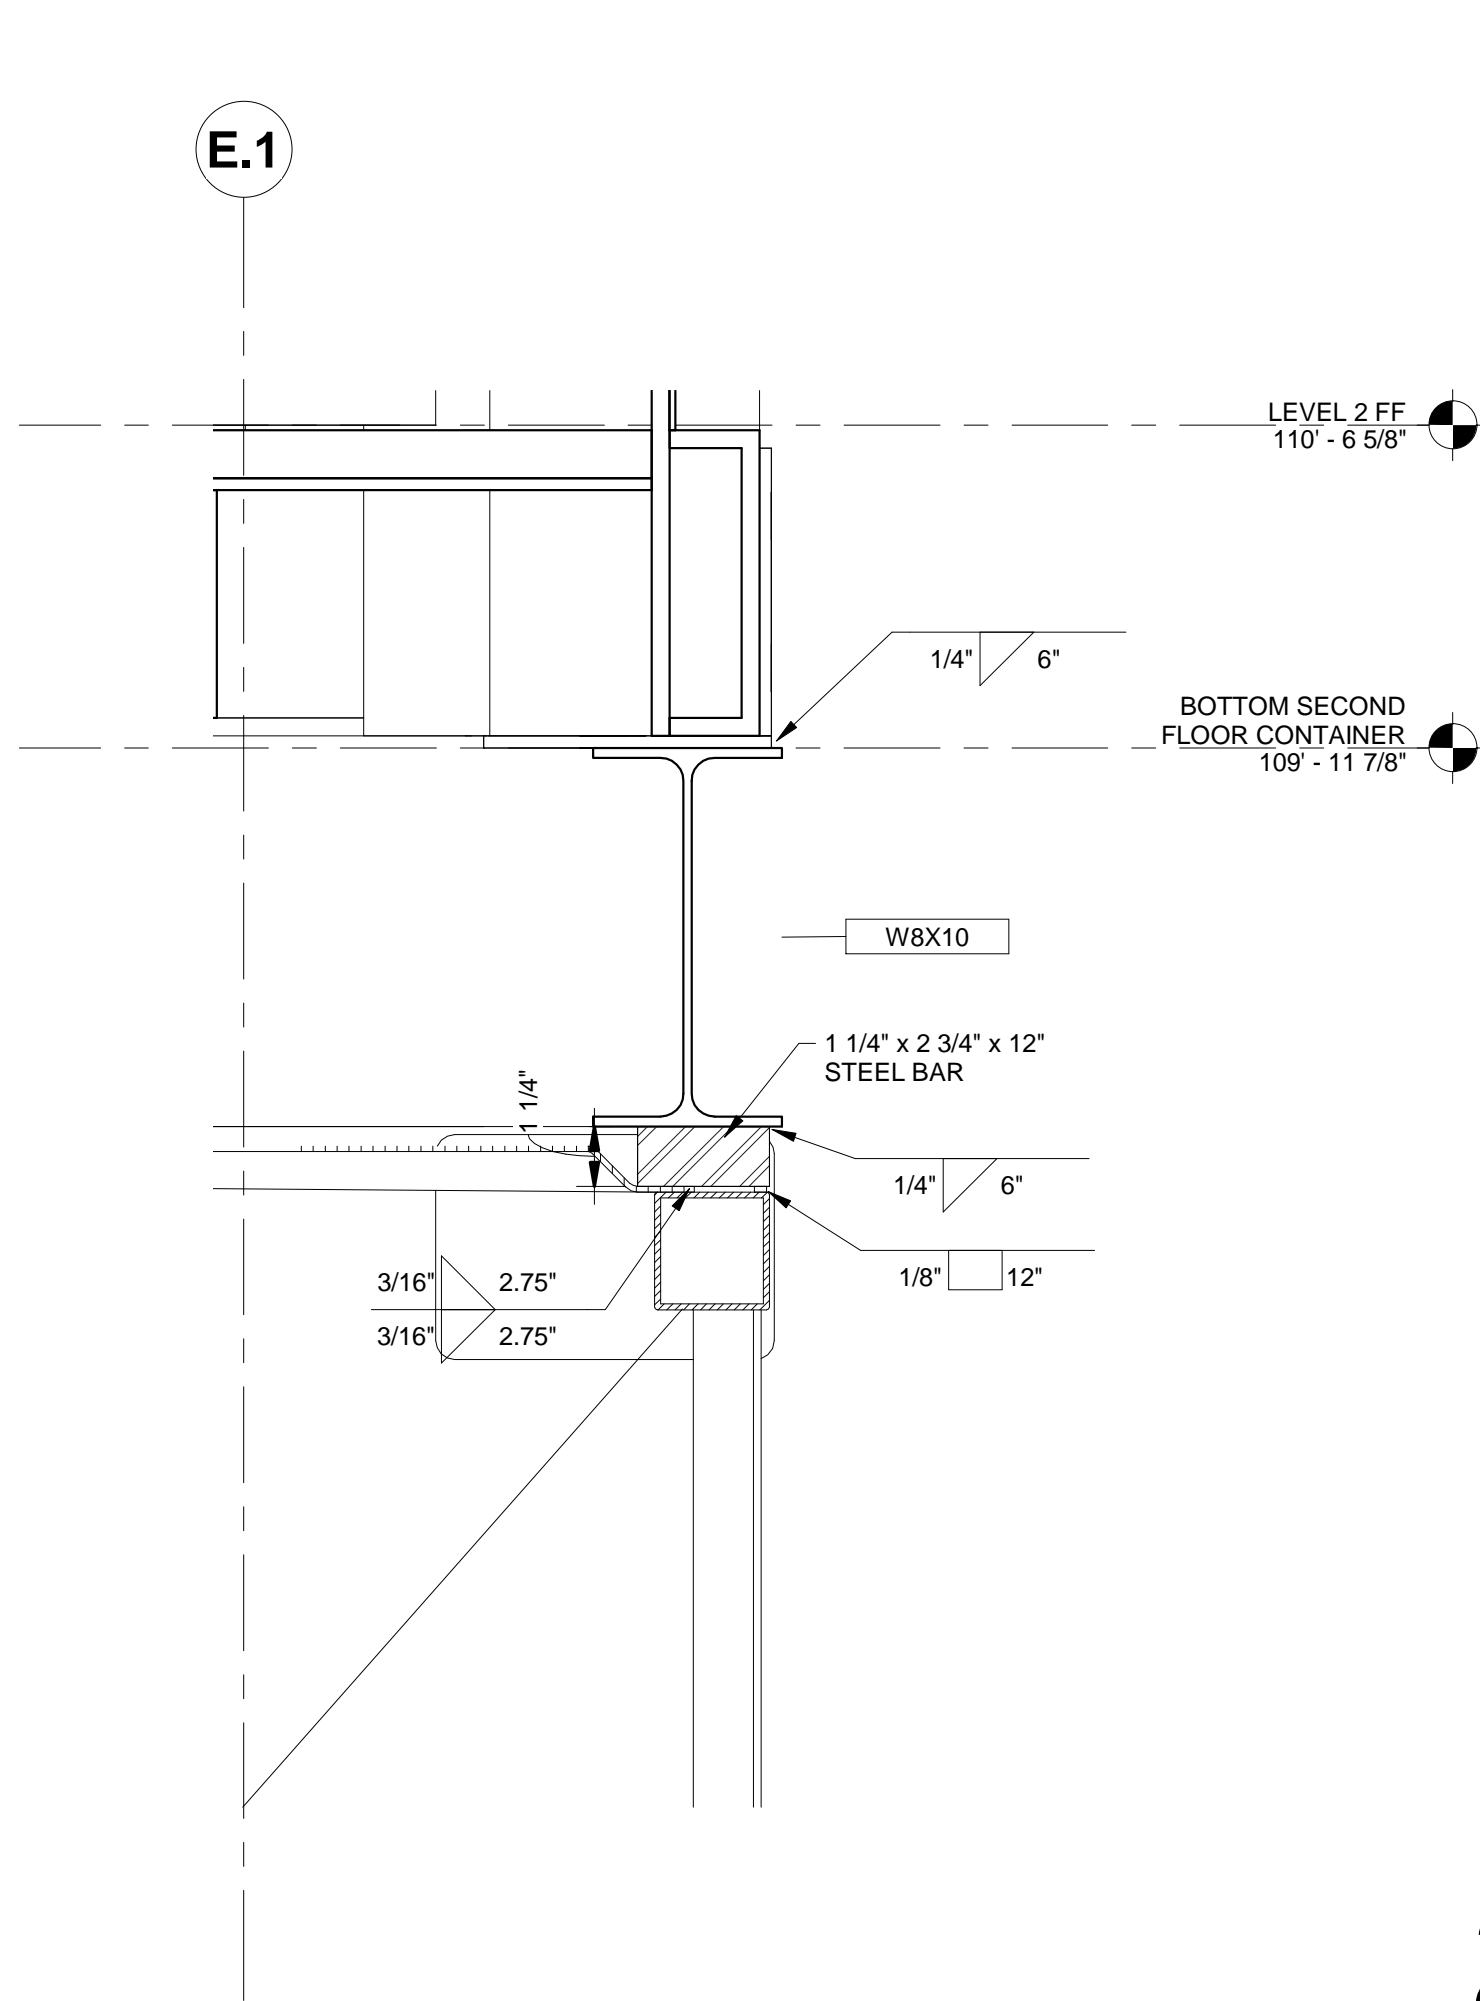

**2** SECOND FLOOR CONTAINER CONNECTION MIDPOINT  
3" = 1'-0"





**5** TOP RAIL STIFFENING  
3" = 1'-0"

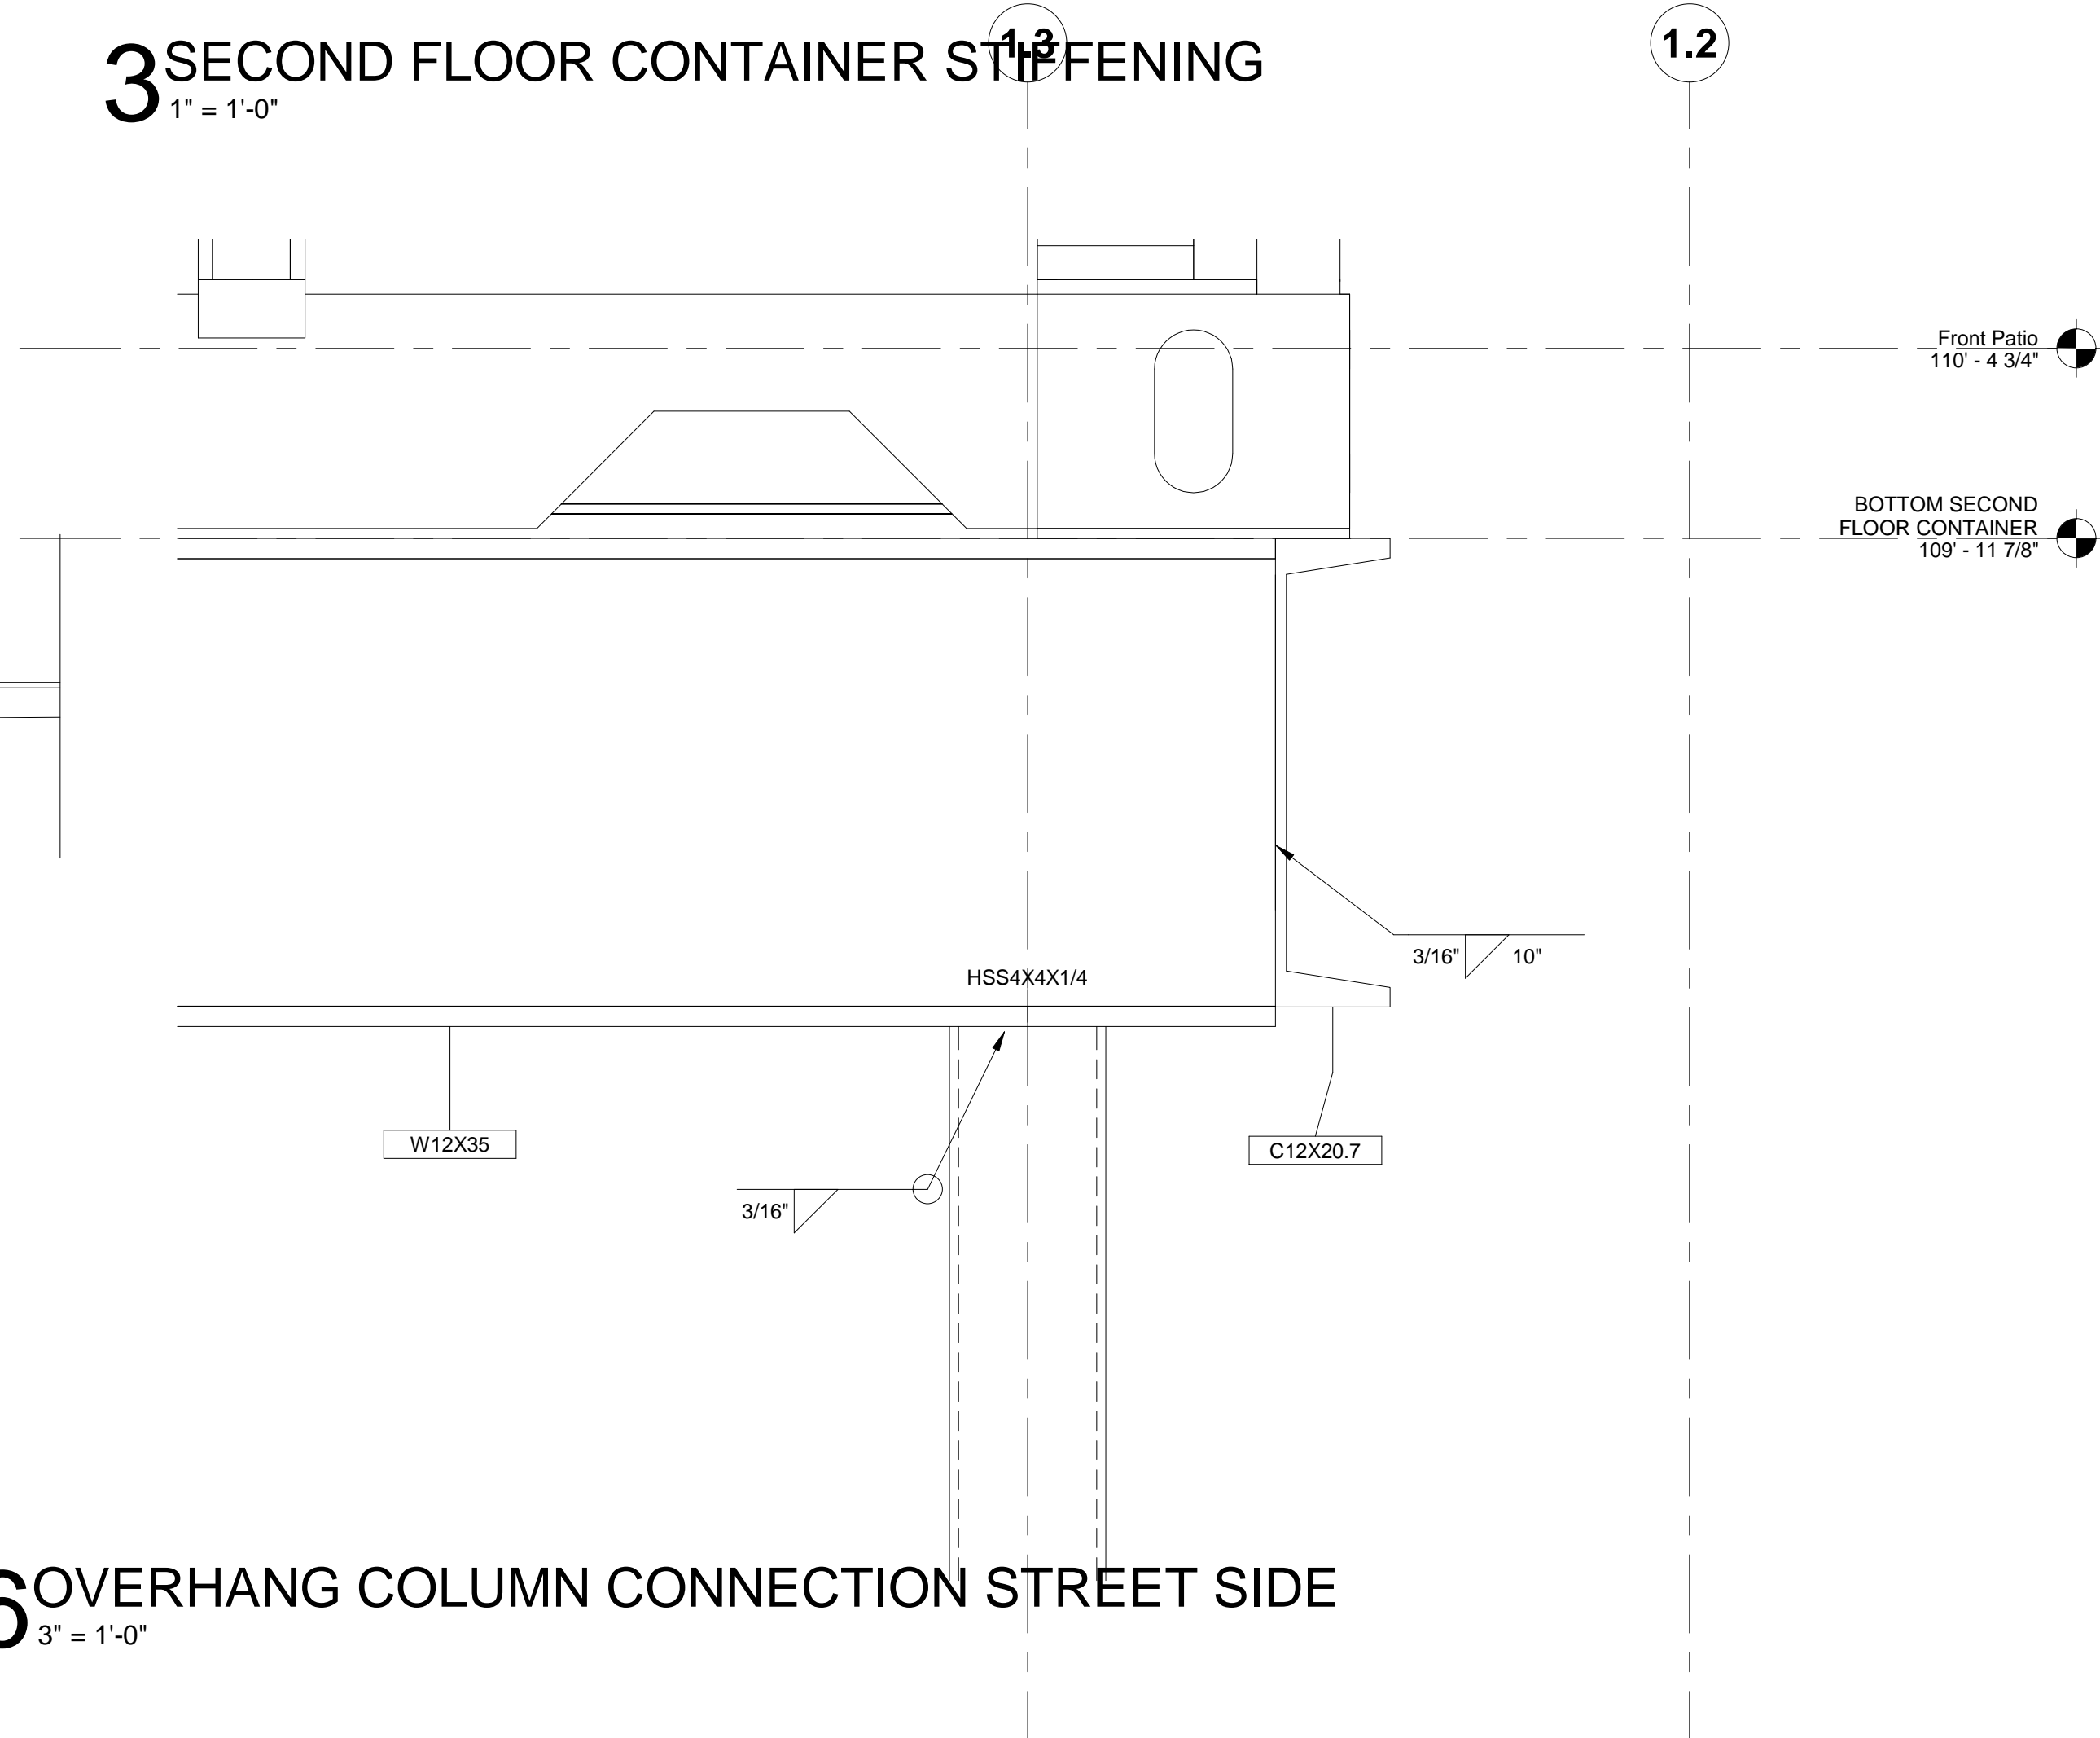


**6** OVERHANG COLUMN CONNECTION STREET SIDE  
3" = 1'-0"

**3** SECOND FLOOR CONTAINER STIFFENING  
1" = 1'-0"

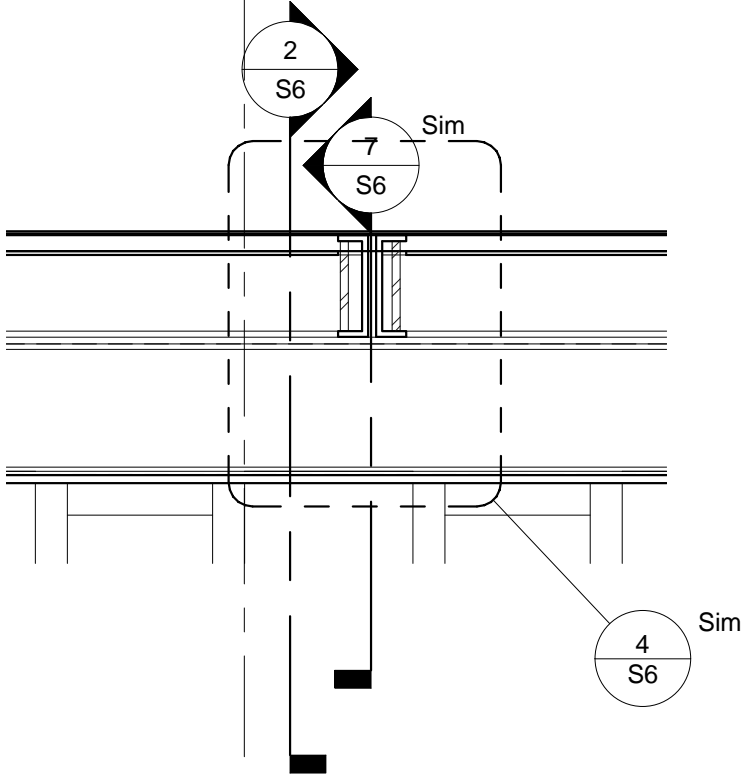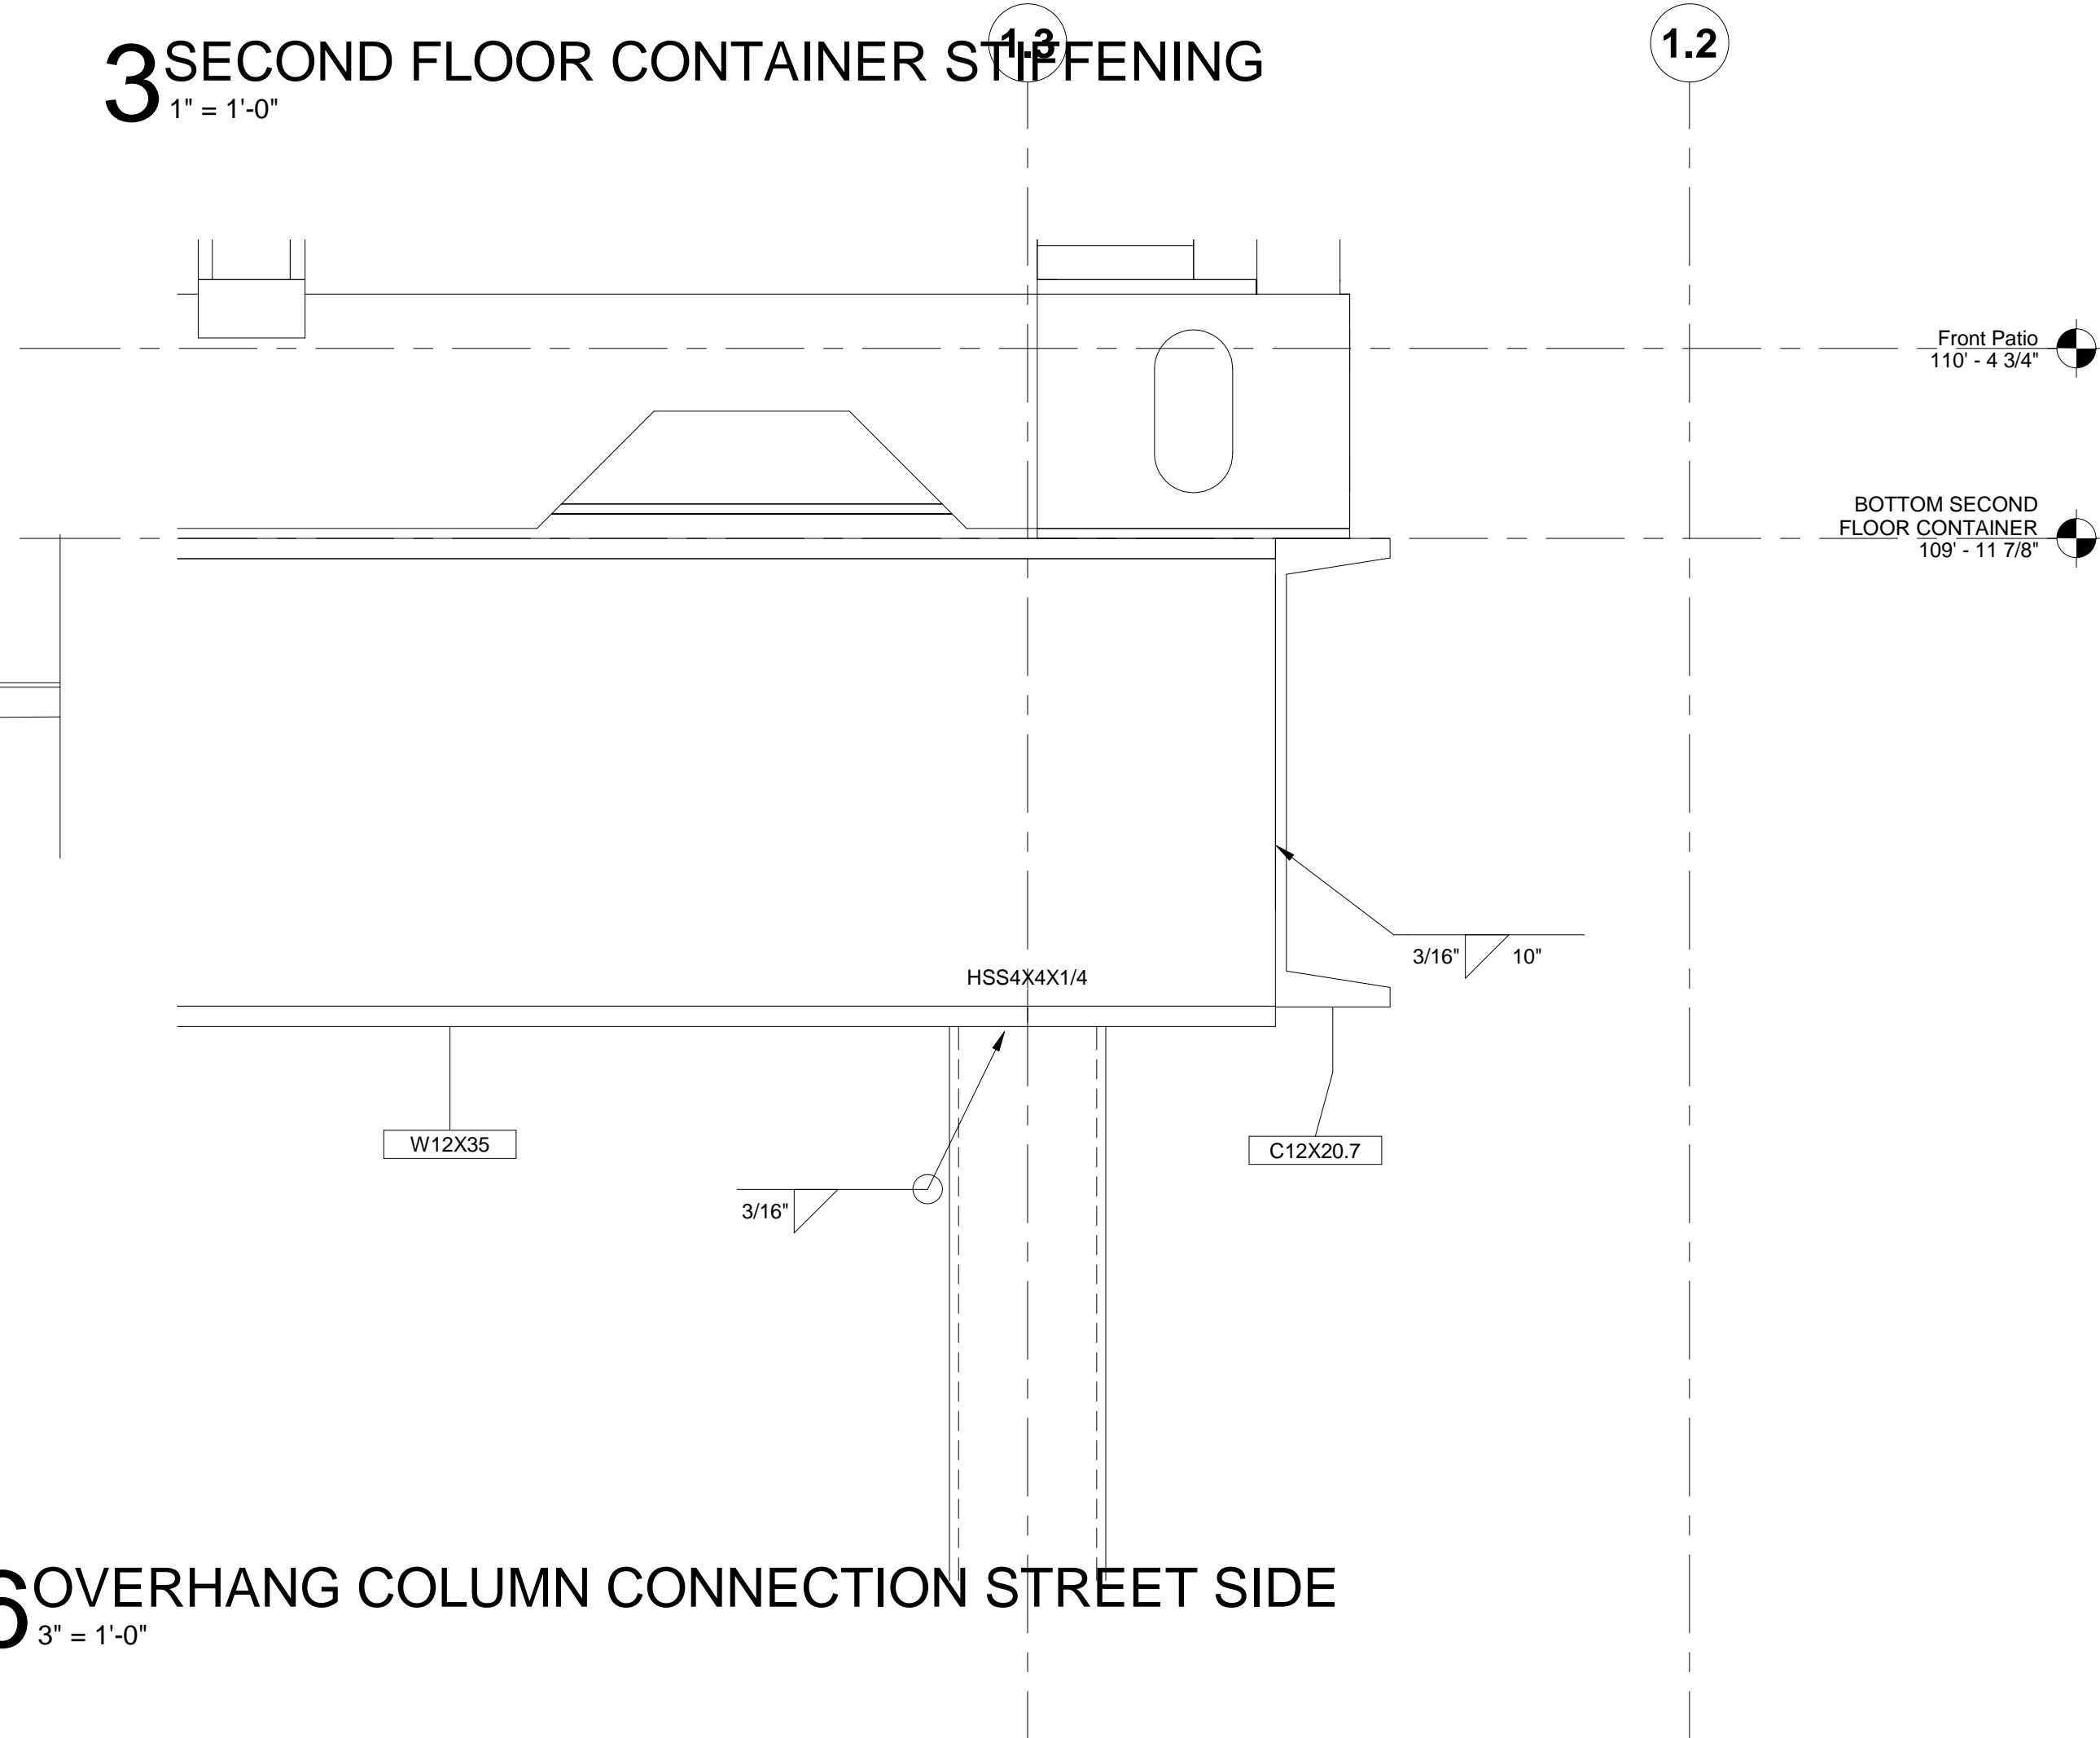

**7** MIDDLE CONNECTION SIDE VIEW  
3" = 1'-0"

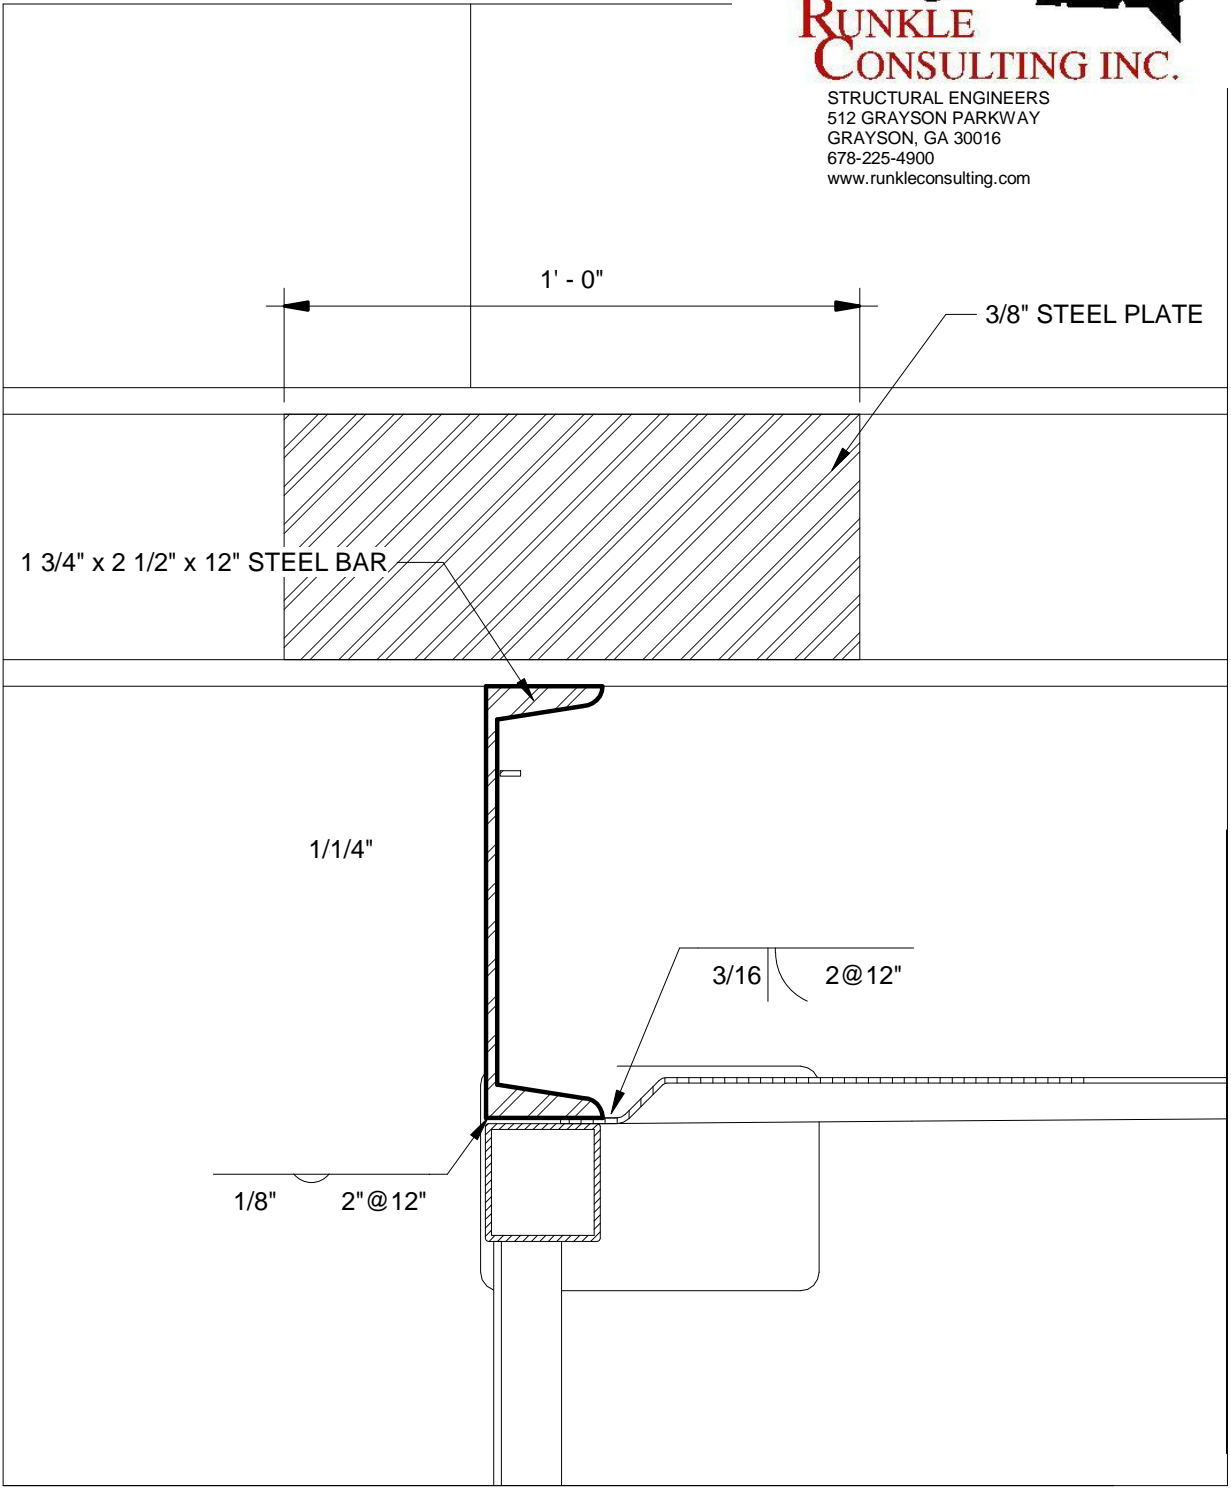

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SHEET  
**SECOND  
FLOOR  
CONNECTIONS**

**S6**  
ORIGINAL SHEET SIZE  
24" x 36"

**CONTAINER COFFEE SHOP**  
**79 SOUTH MAIN STREET**  
**PITTSBURGH, PA**  
CRAIG A. SLOCUM, ARCHITECT

CRAIG A. SLOCUM, ARCHITECT  
1777 S BELLAIRE ST, SUITE 100  
DENVER, CO 80222  
(303) 962-9164  
www.csllpa.com

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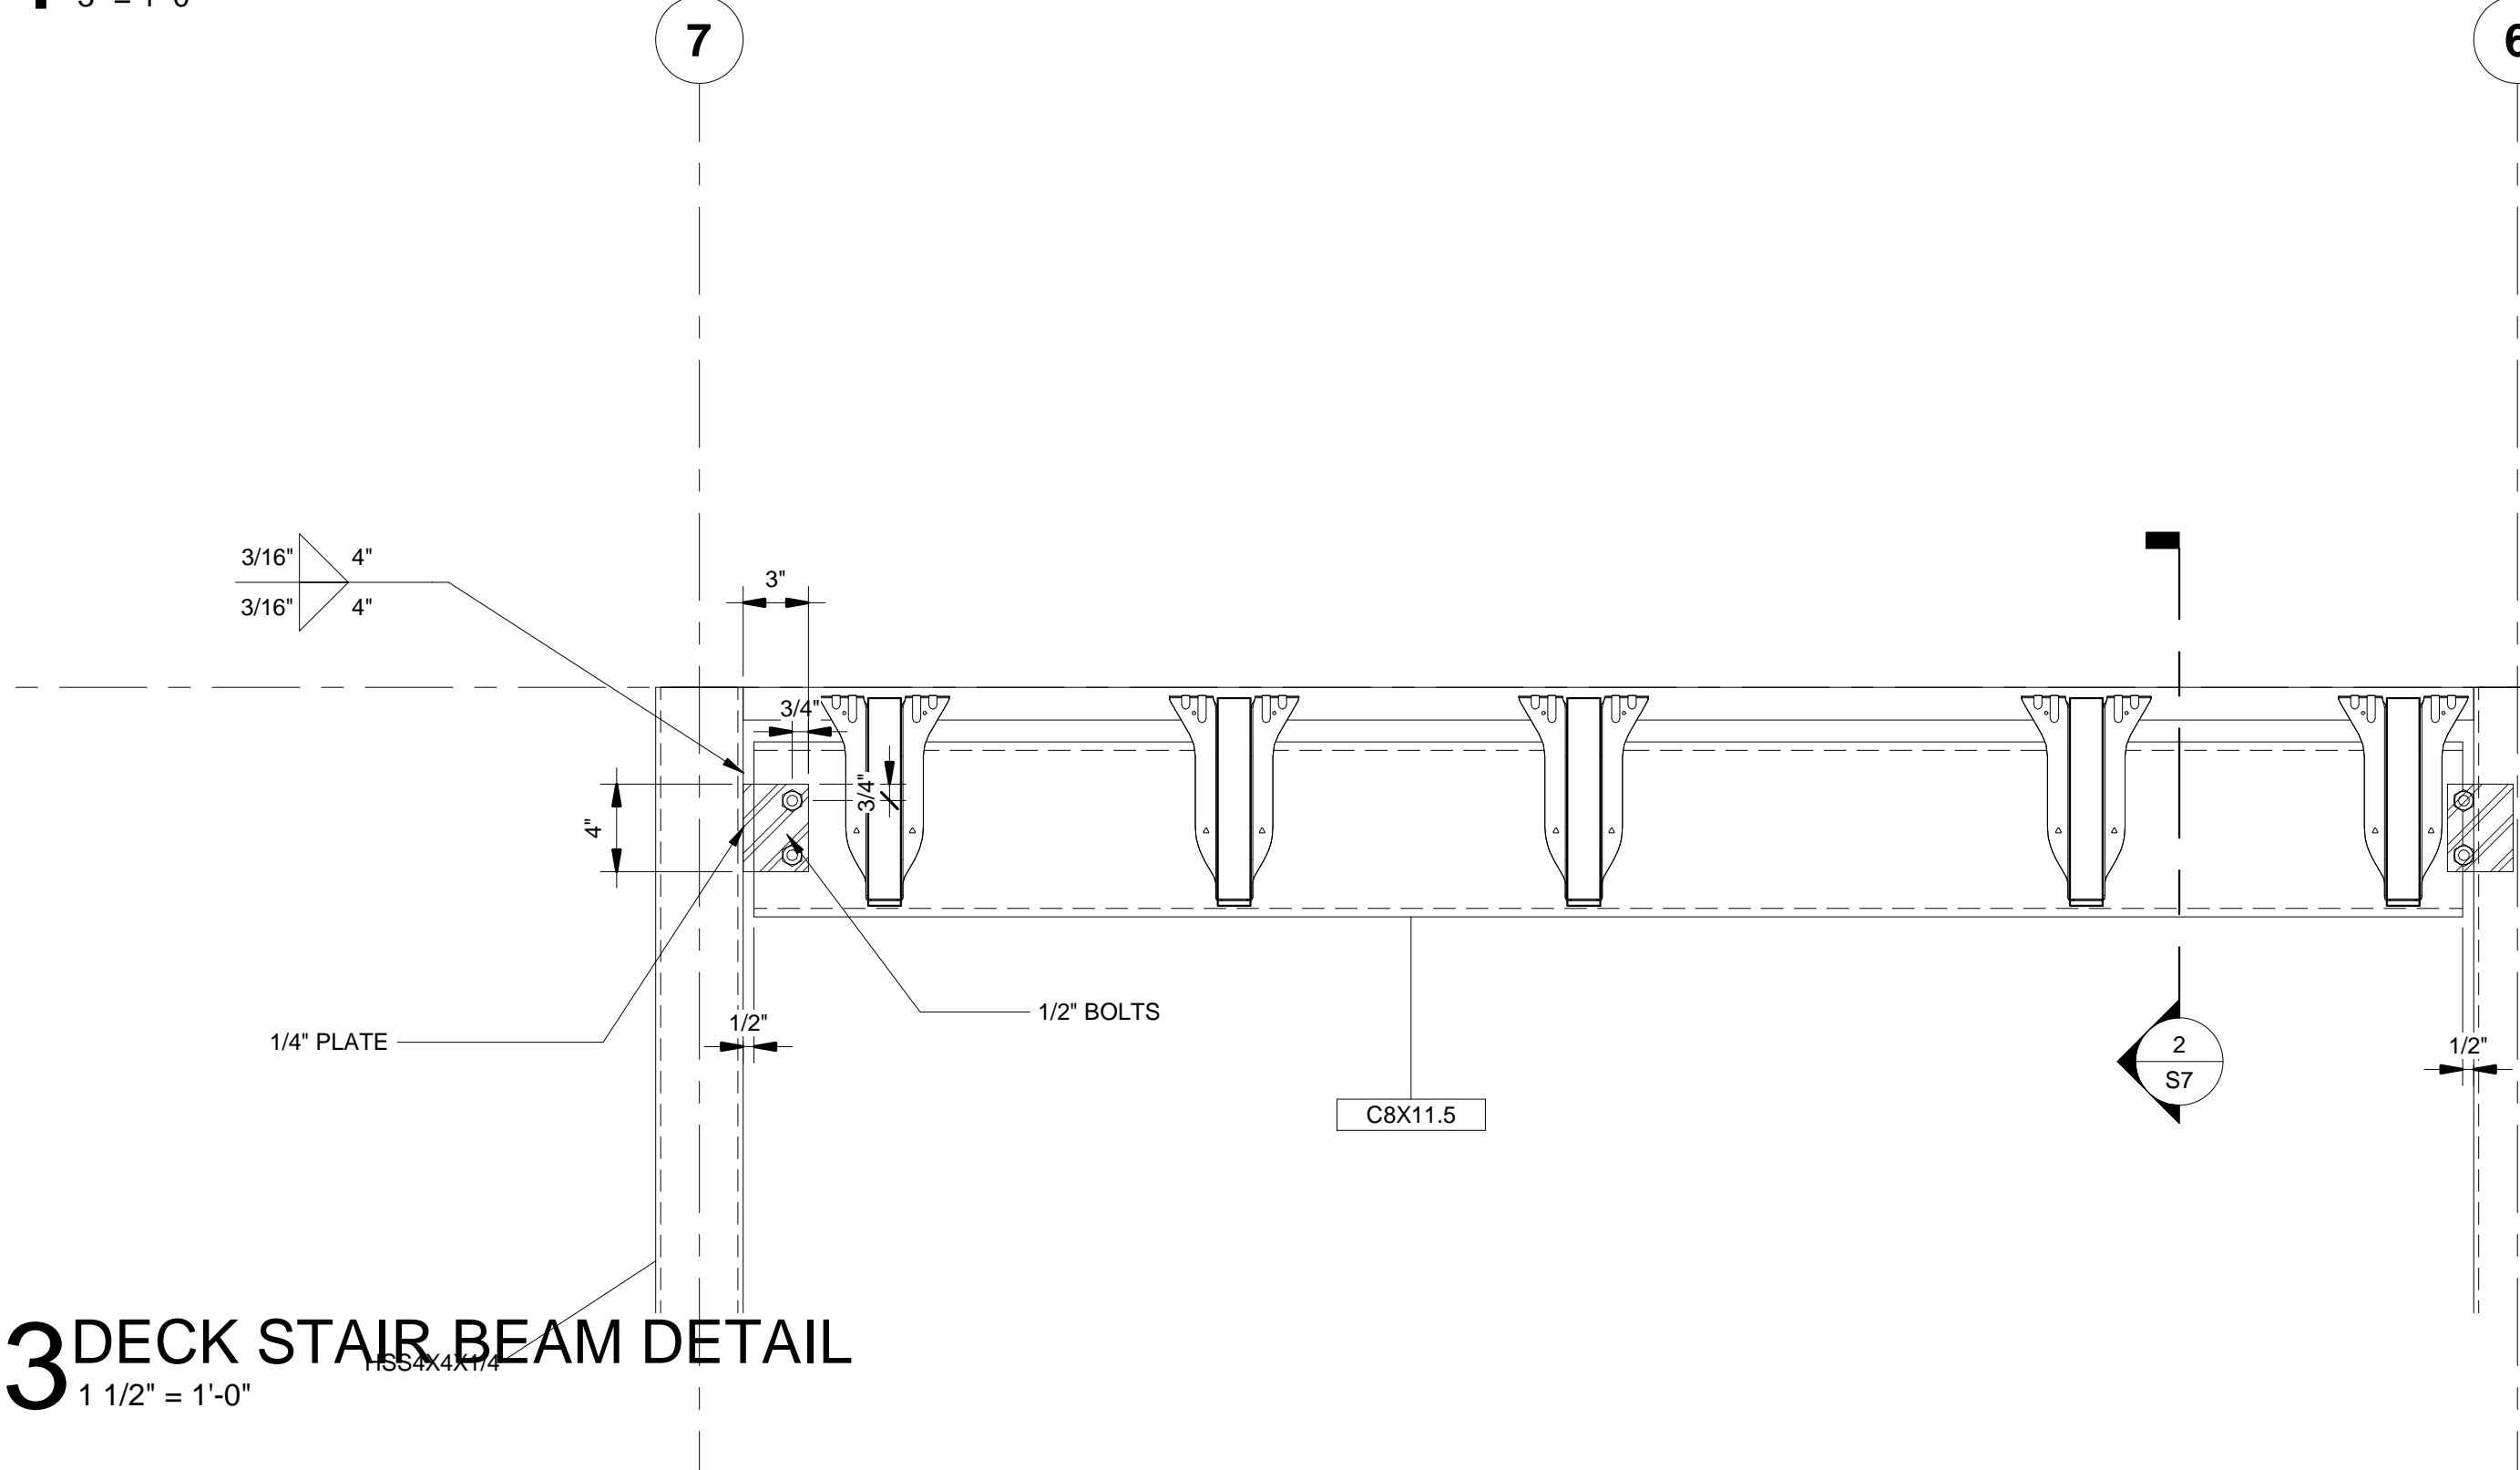
REVISED

GROUND  
FLOOR DECK  
FRAMING  
DETAILS


SHEET

S7  
ORIGINAL SHEET SIZE  
24" x 36"

1 JOISTS ATTACHMENT TO STEEL DROP BEAM  
3" = 1'-0"



2 JOIST SUPPORT ON CHANNELS  
3" = 1'-0"

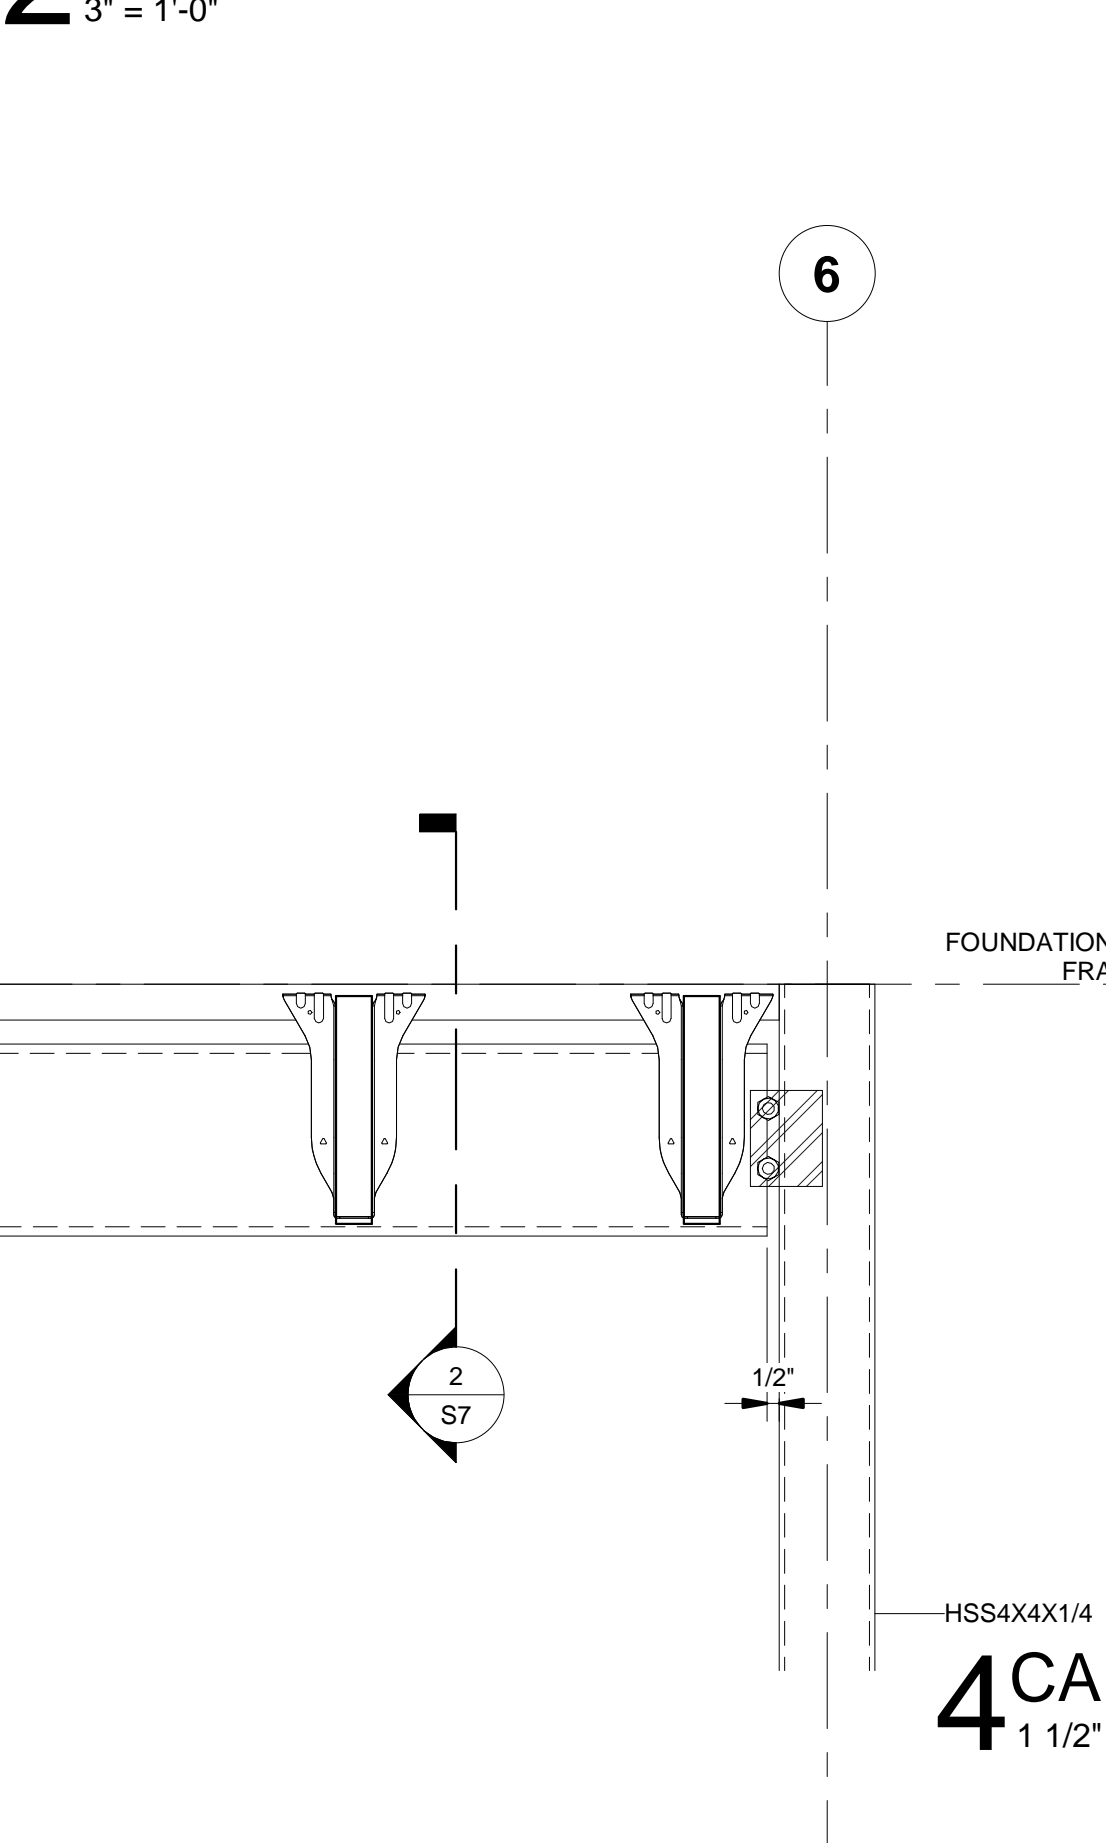

4 CANTILEVER BASE AND DECK JOIST HANGER DETAIL  
1 1/2" = 1'-0"



5 DOUBLE DECK BEAM CONNECTION  
3" = 1'-0"







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PITTSBURGH, PA

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DENVER, CO 80222


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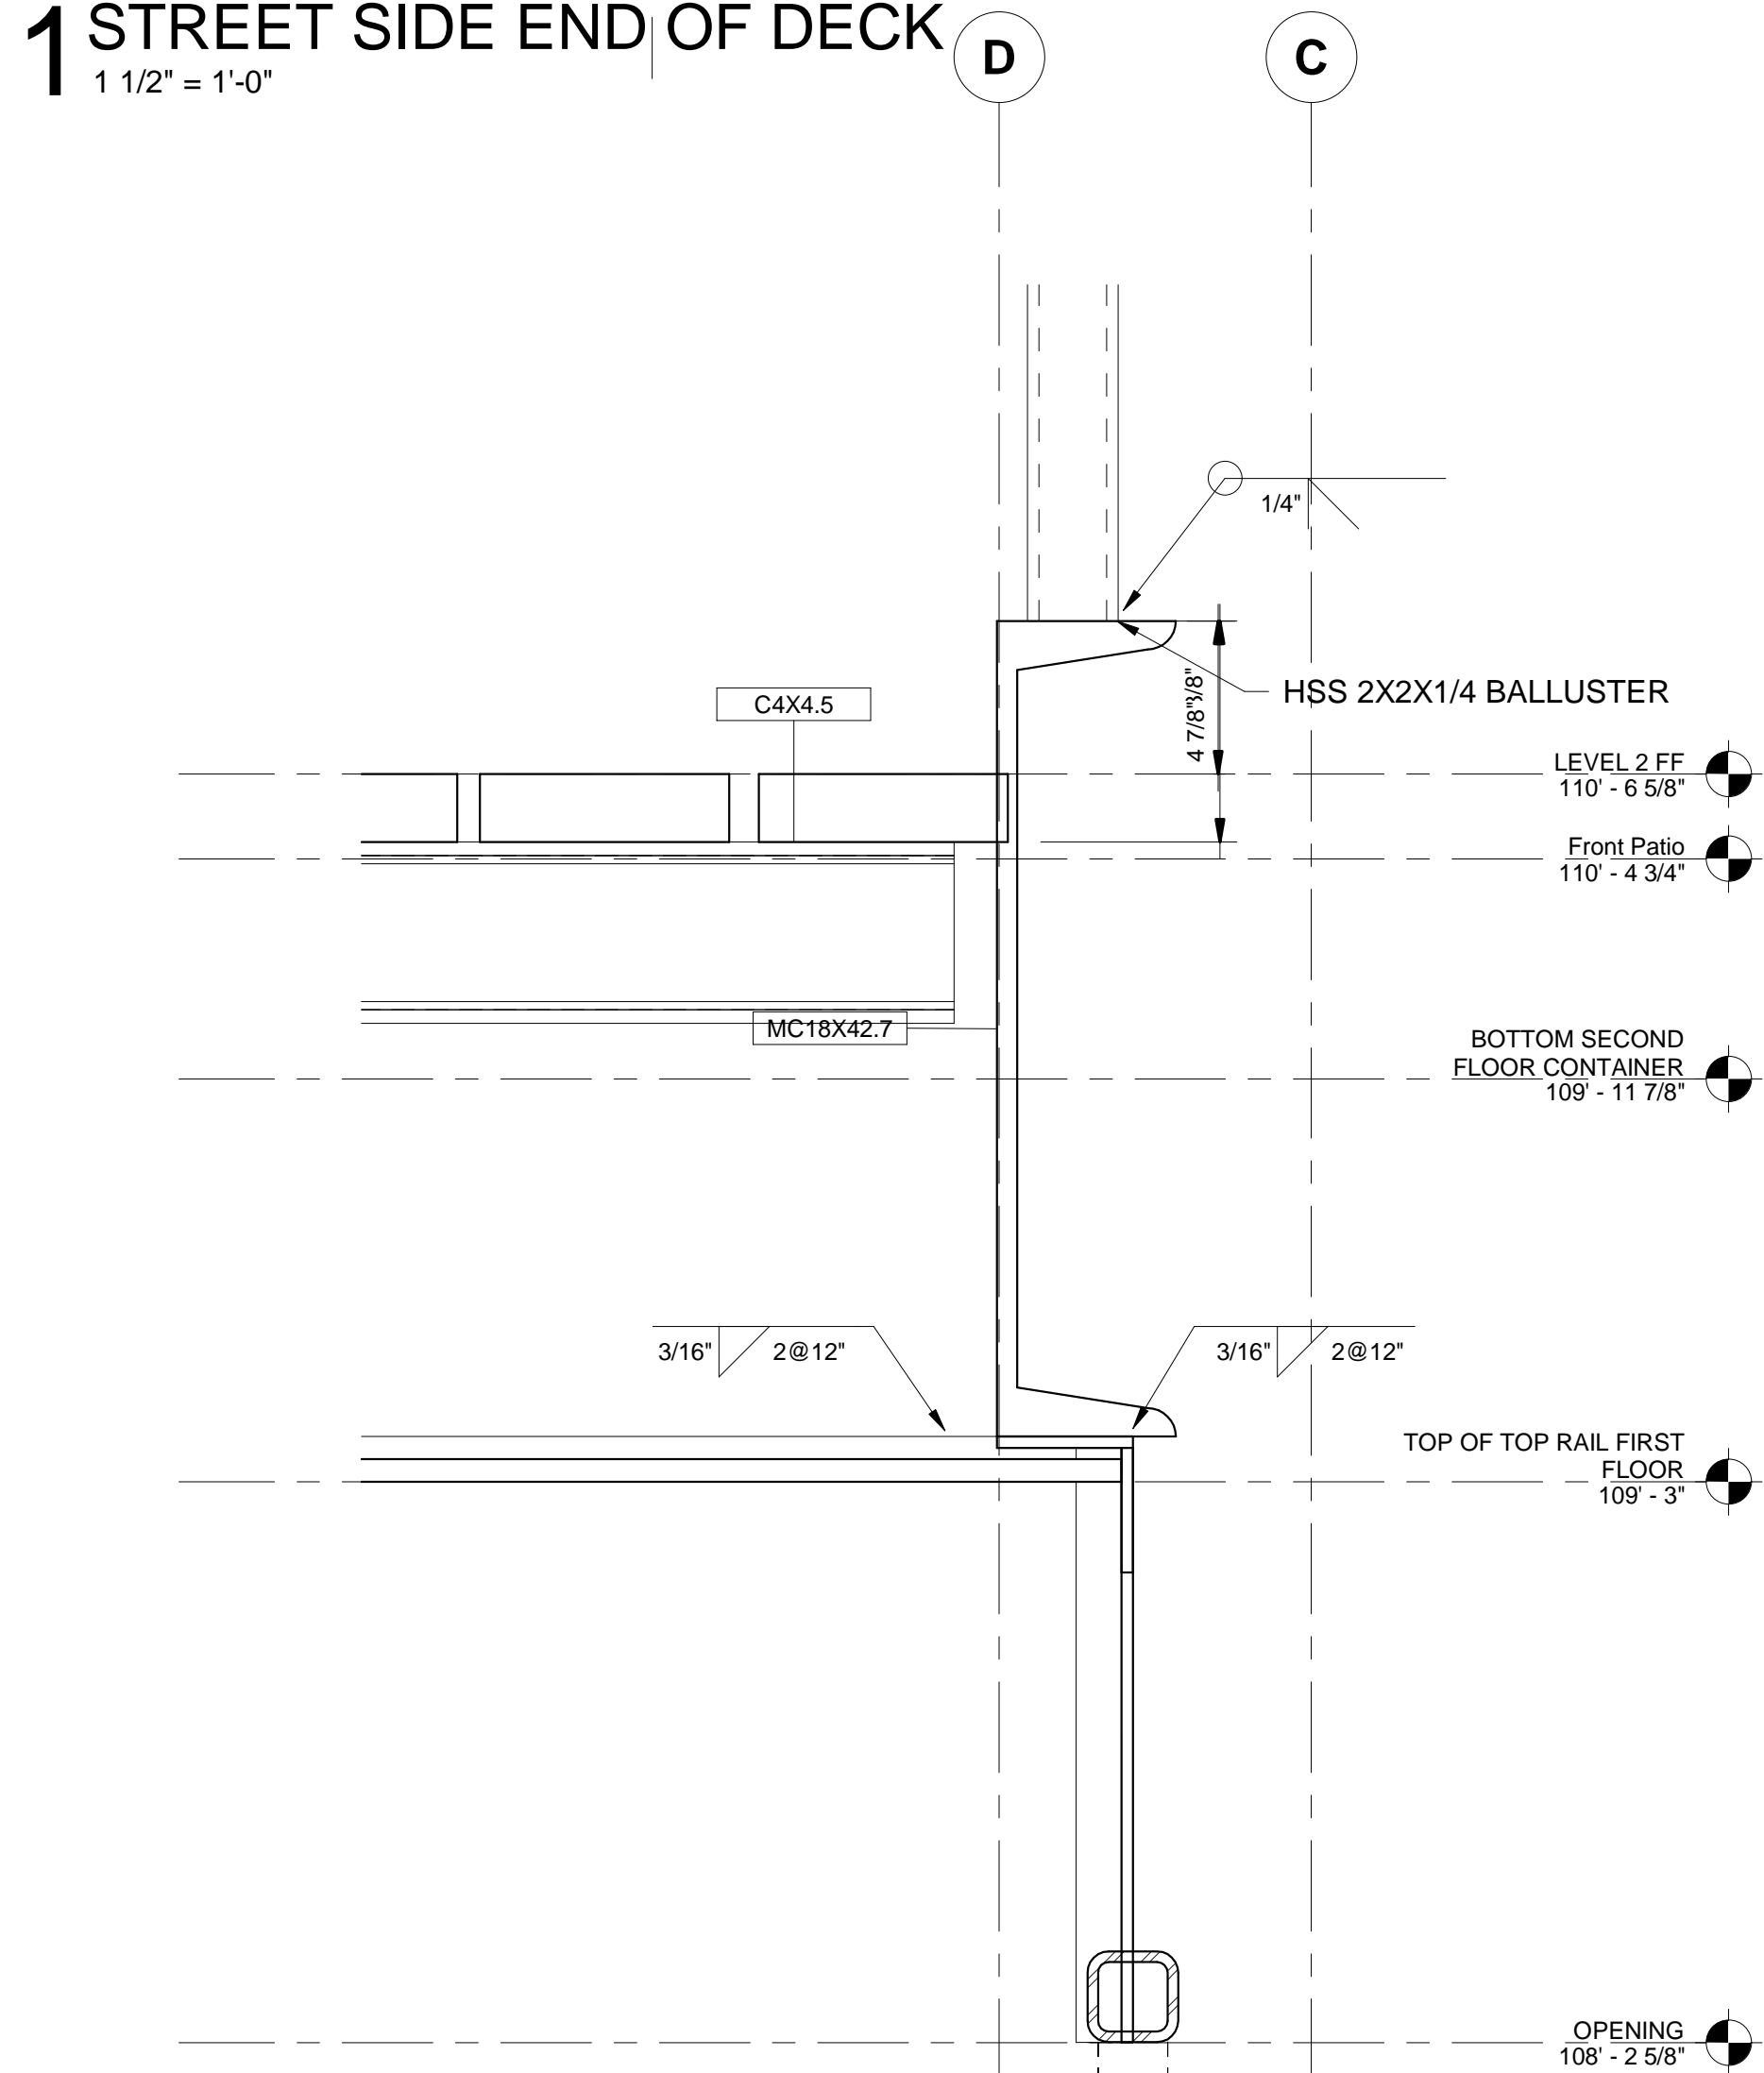
PROJECT 19176	DATE 5-29-2020
DRAWN gwr	CHECKED Checker

SHEET TITLE  
FRONT DECK  
DETAILS


SHEET  
S8  
ORIGINAL SHEET SIZE  
24" x 36"




1 STREET SIDE END OF DECK  
1 1/2" = 1'-0"

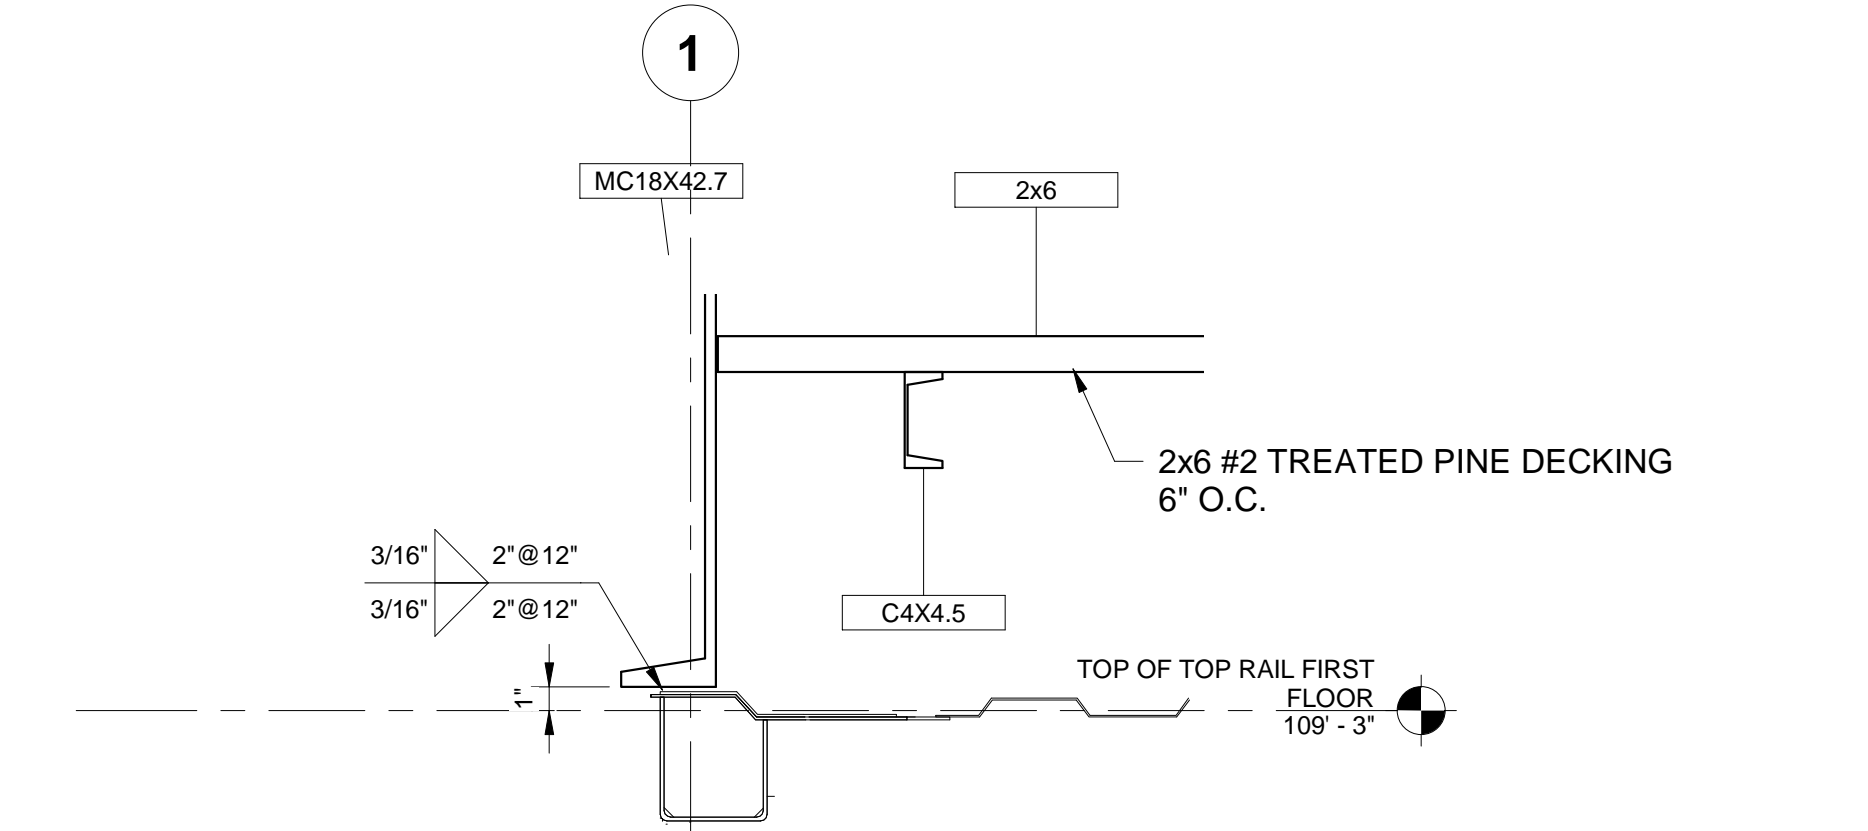

3 DECK EDGE SECTION AND WALL OPENING DETAIL  
3" = 1'-0"

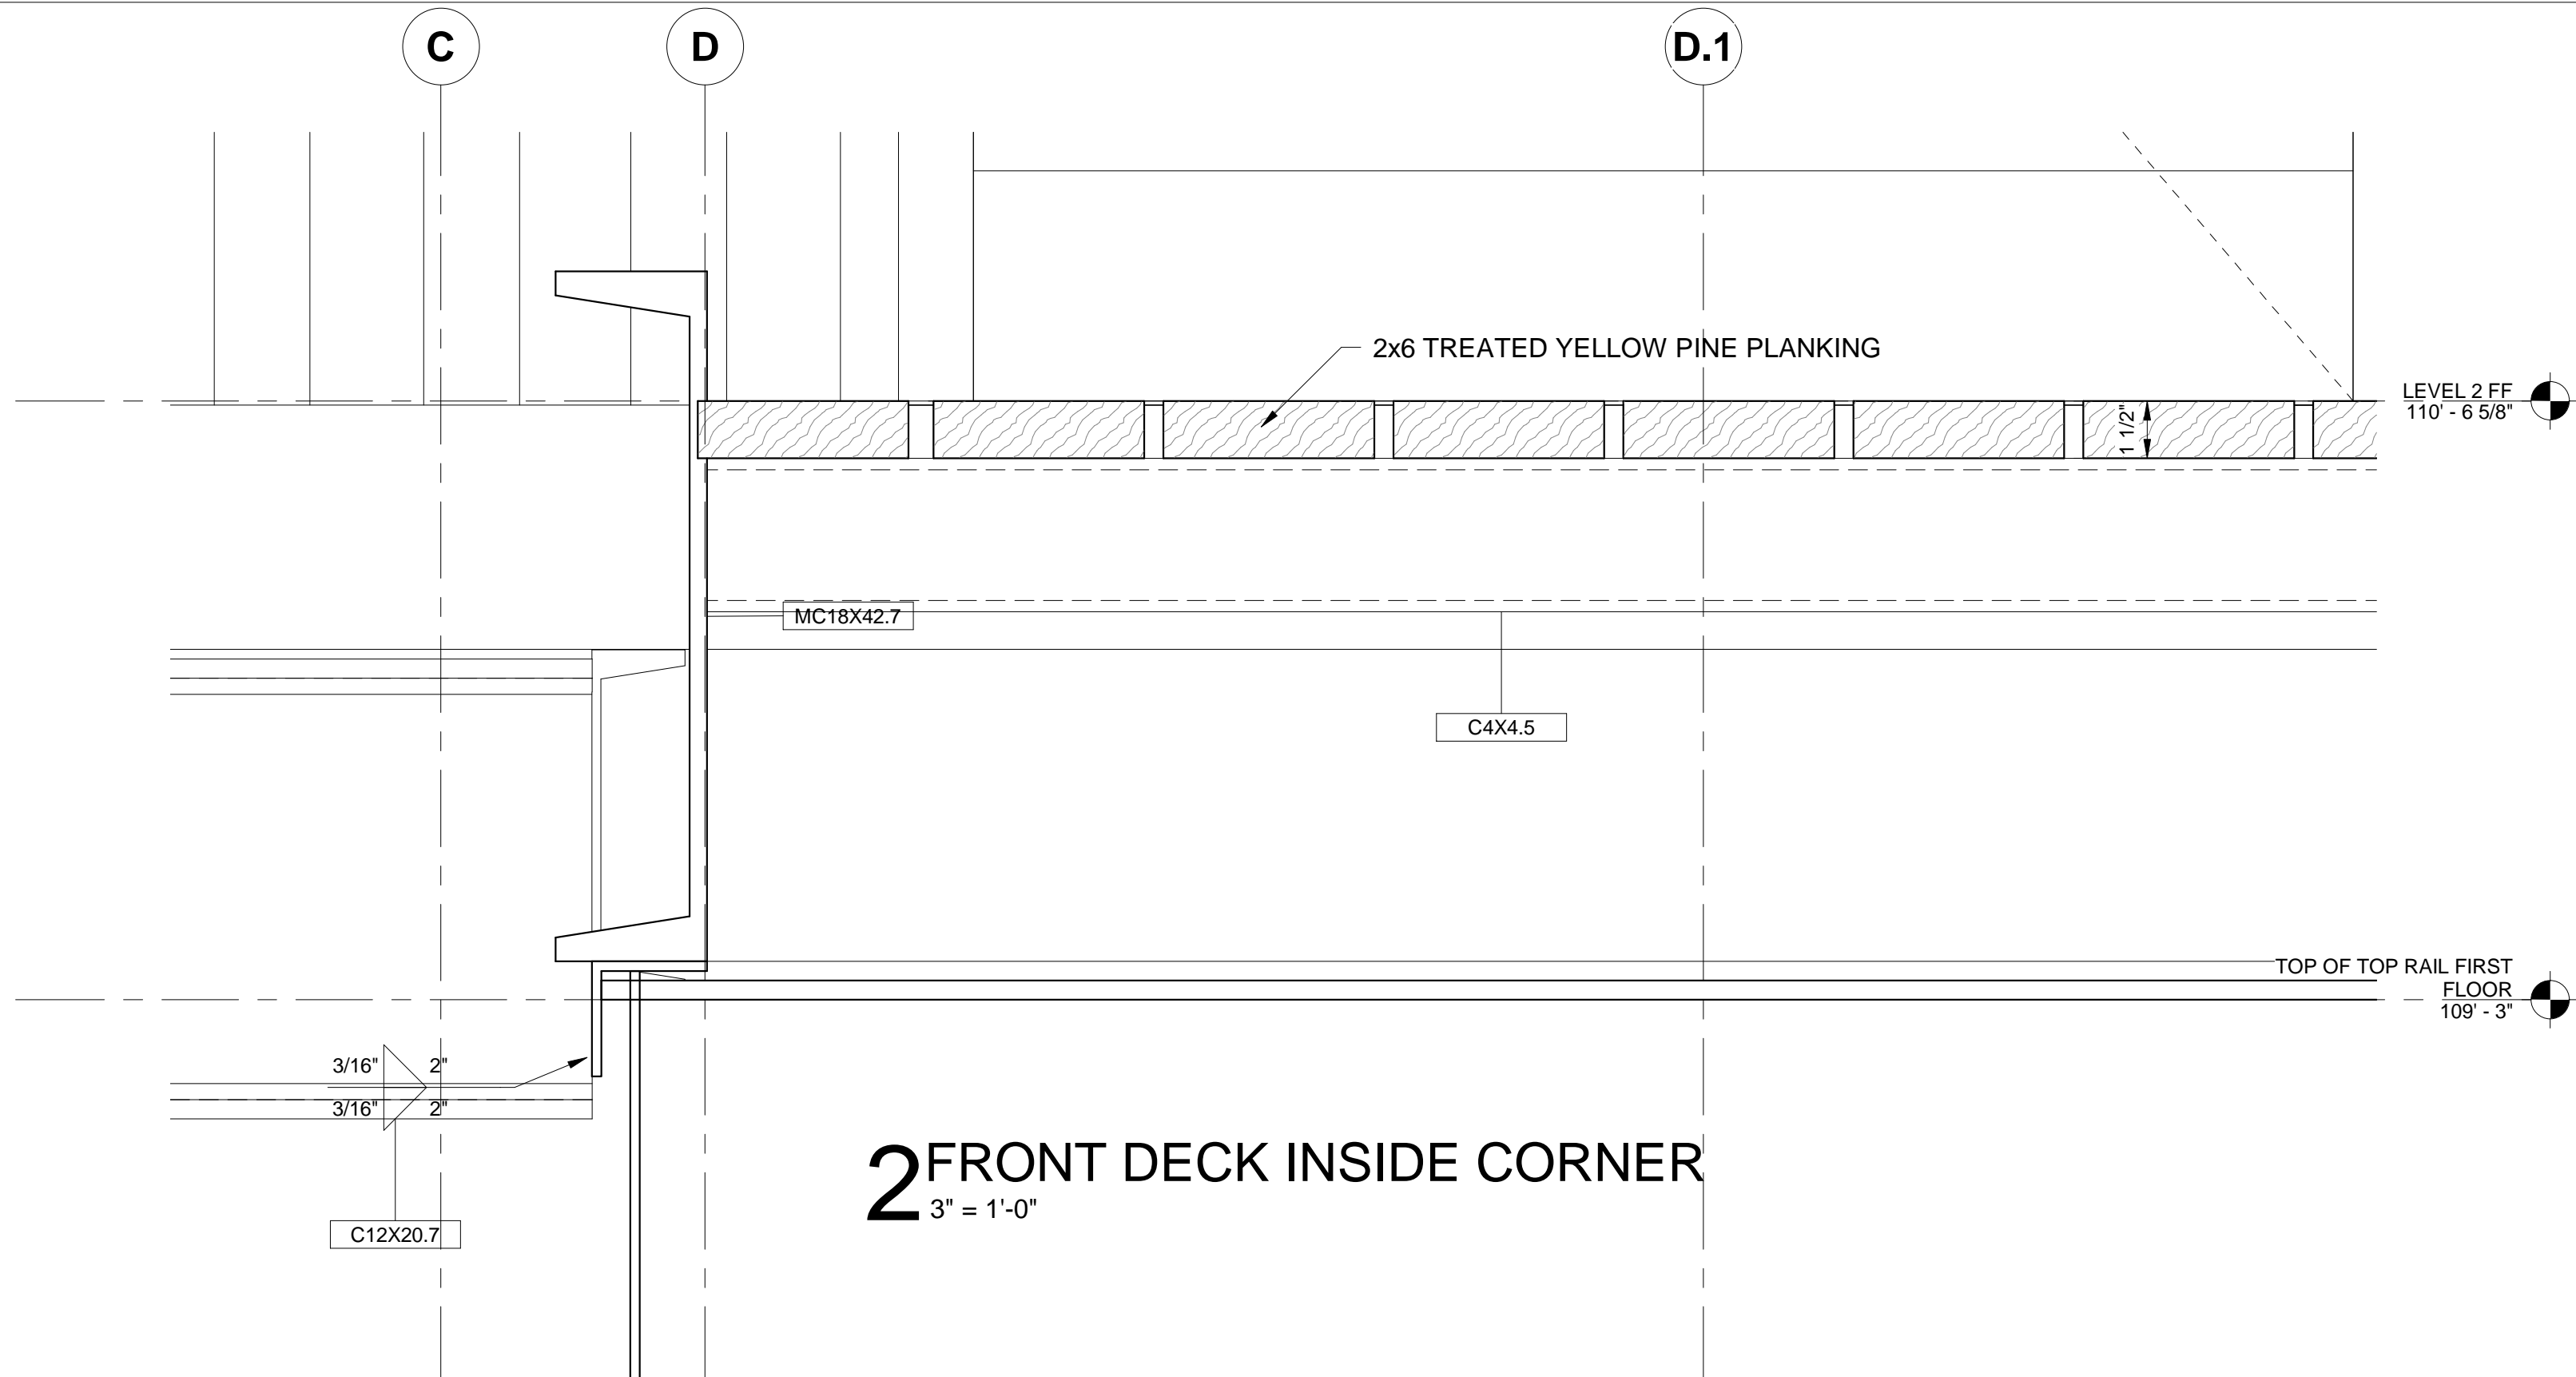

2 FRONT DECK INSIDE CORNER  
3" = 1'-0"

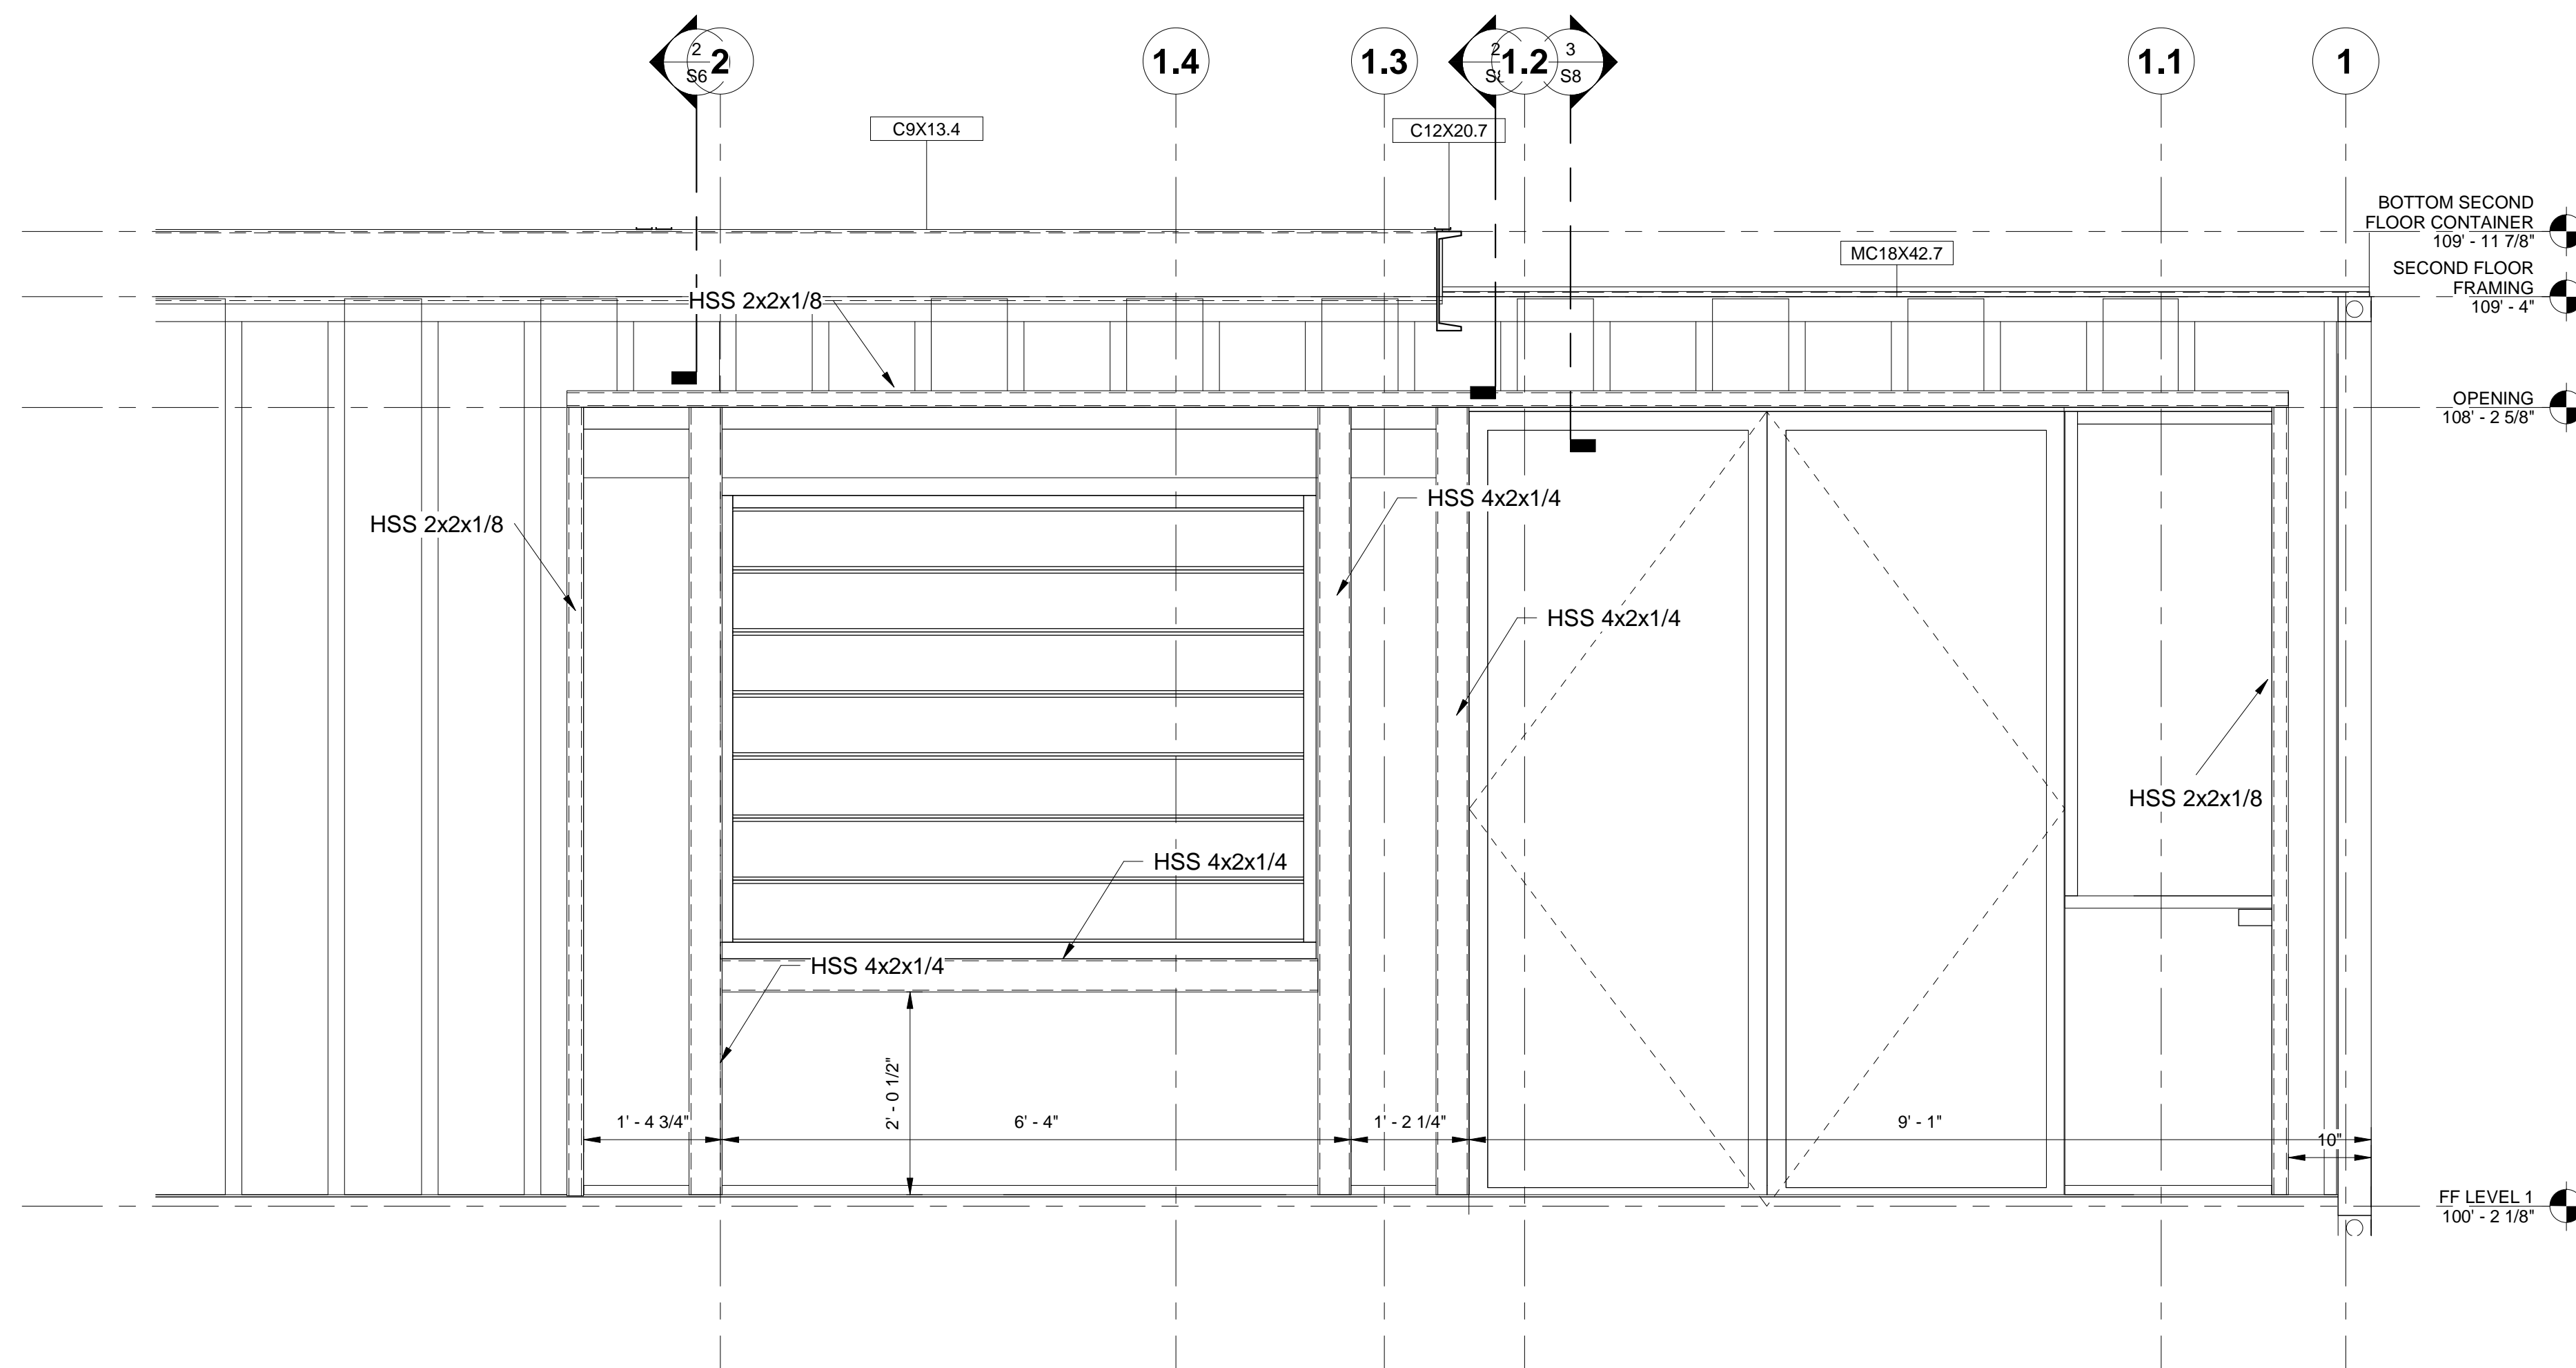

4 GROUND FLOOR OPENING FRAMING  
3/4" = 1'-0"





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**CONTAINER COFFEE SHOP**  
79 SOUTH MAIN STREET    PITTSTON, PA

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PROJECT 19176	DATE 5-29-2020
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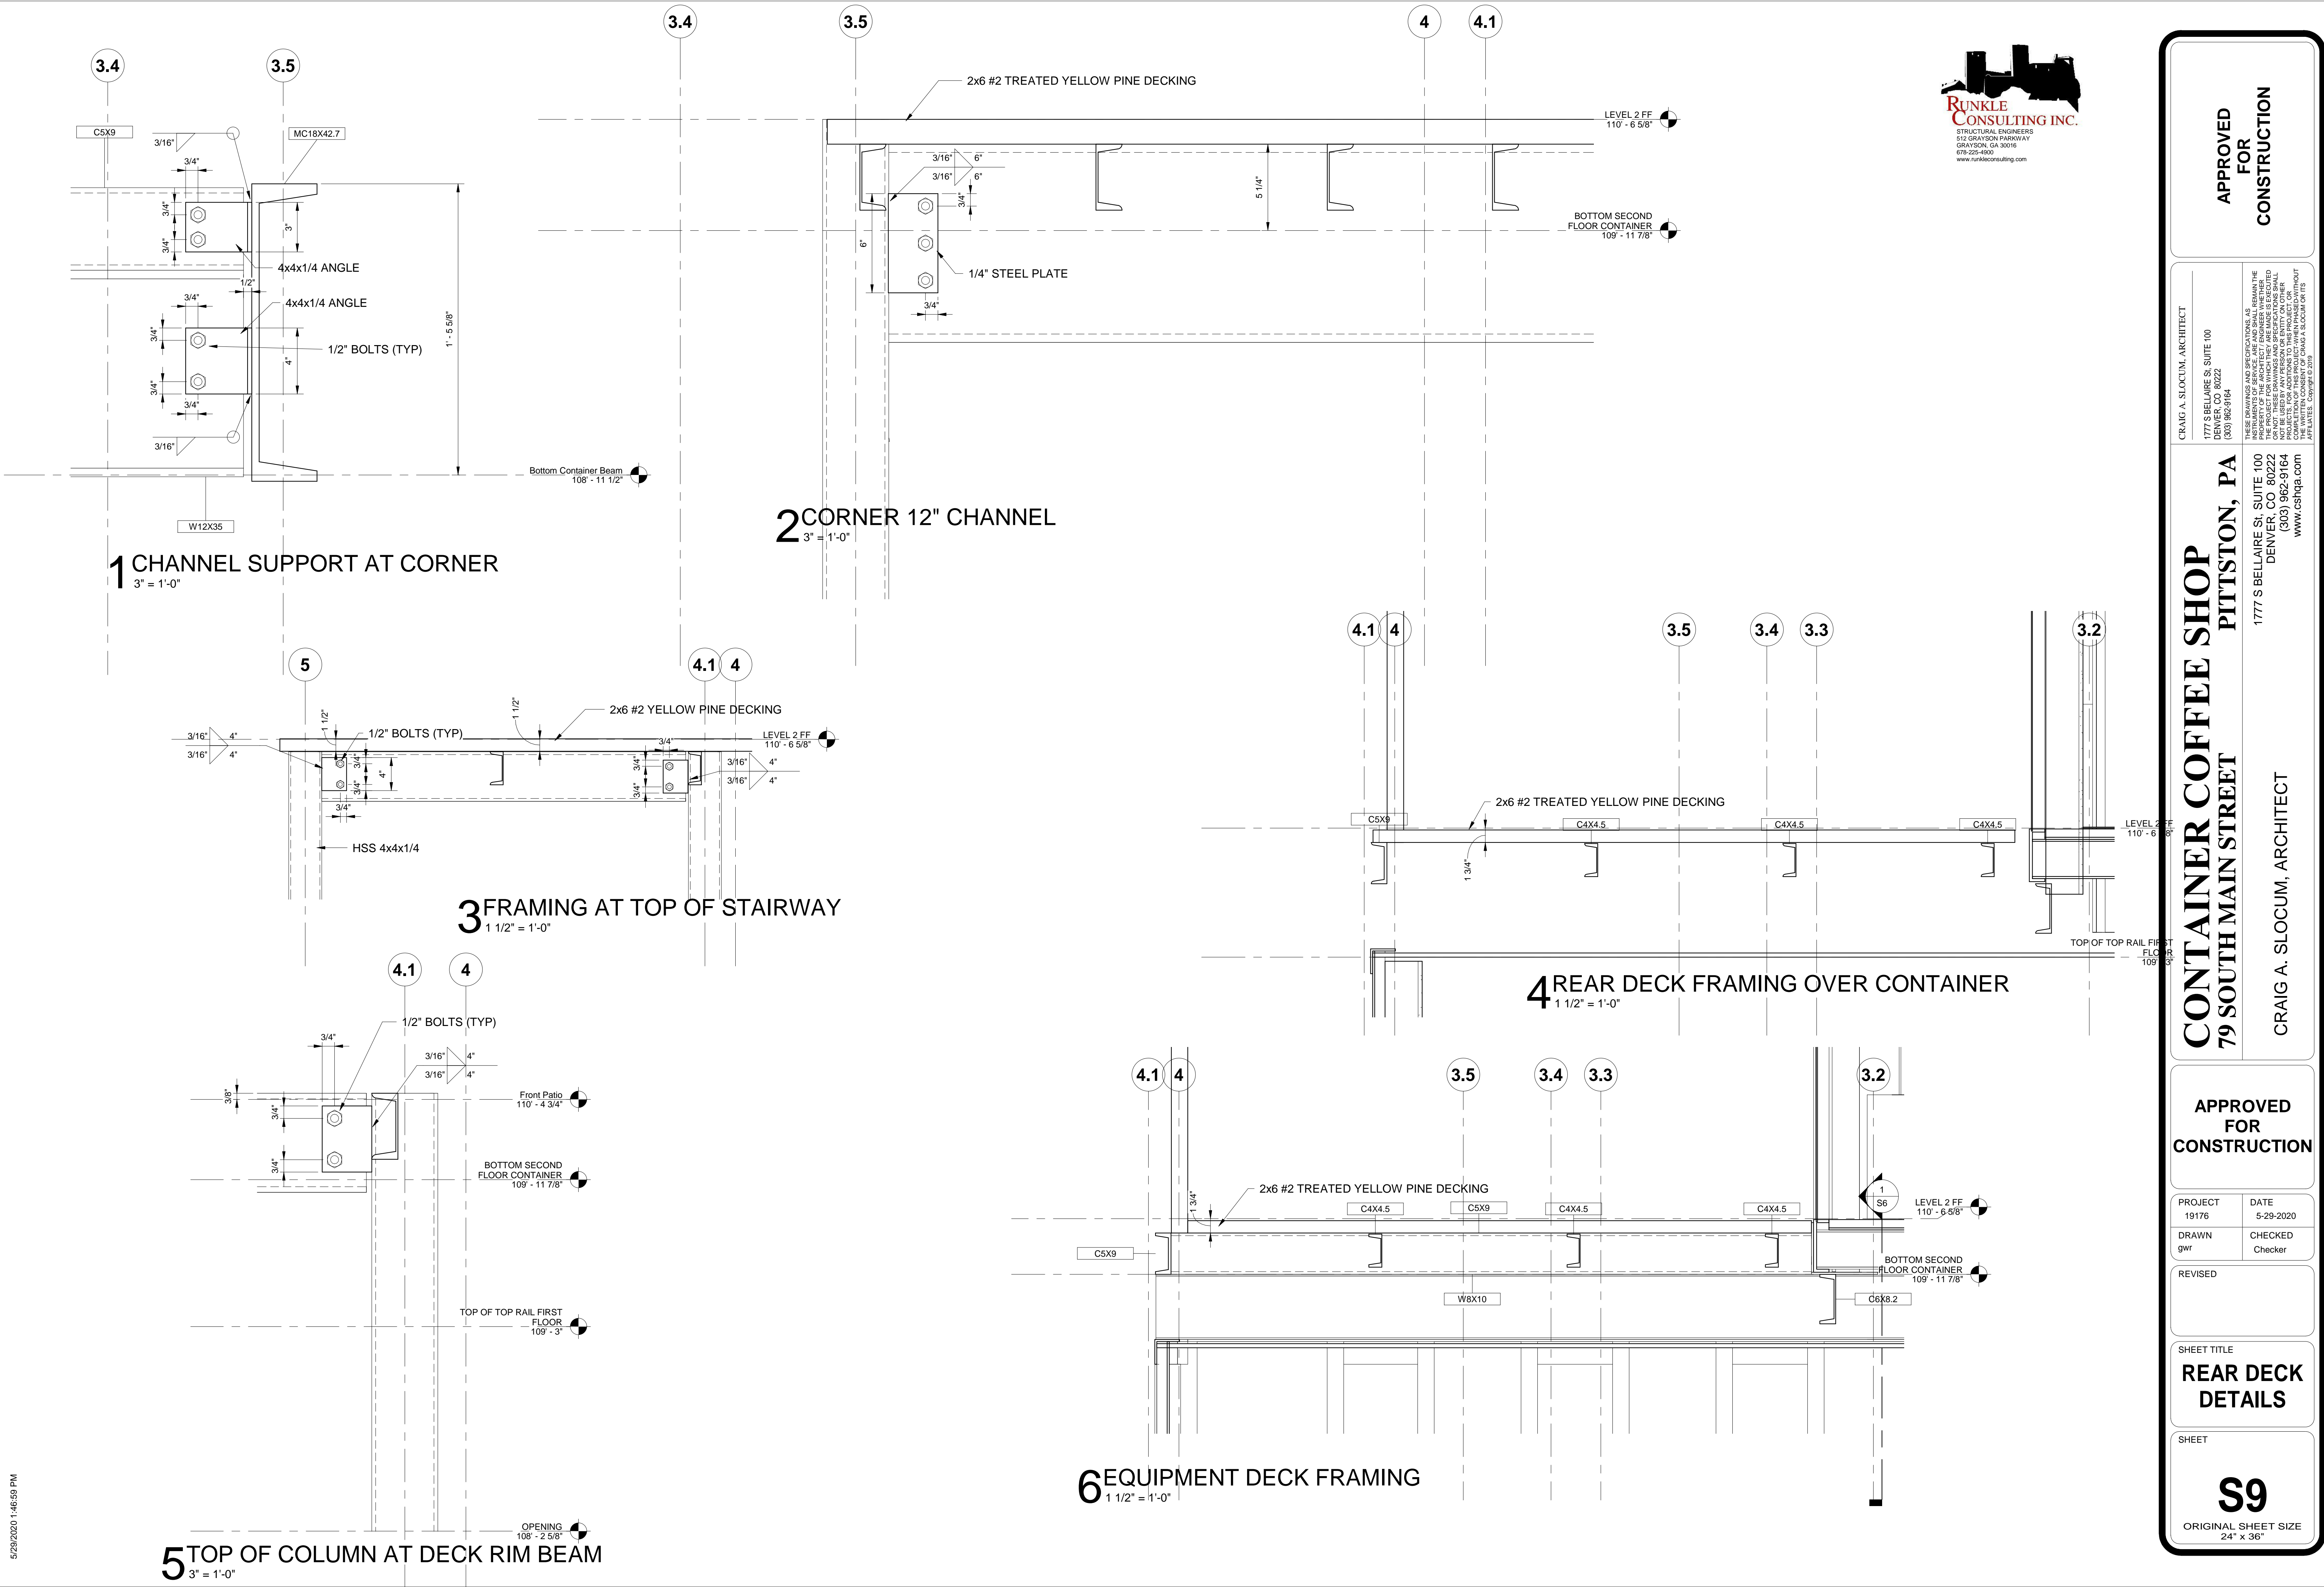
SHEET TITLE

**REAR DECK  
DETAILS**

SHEET

**S9**

ORIGINAL SHEET SIZE  
24" x 36"





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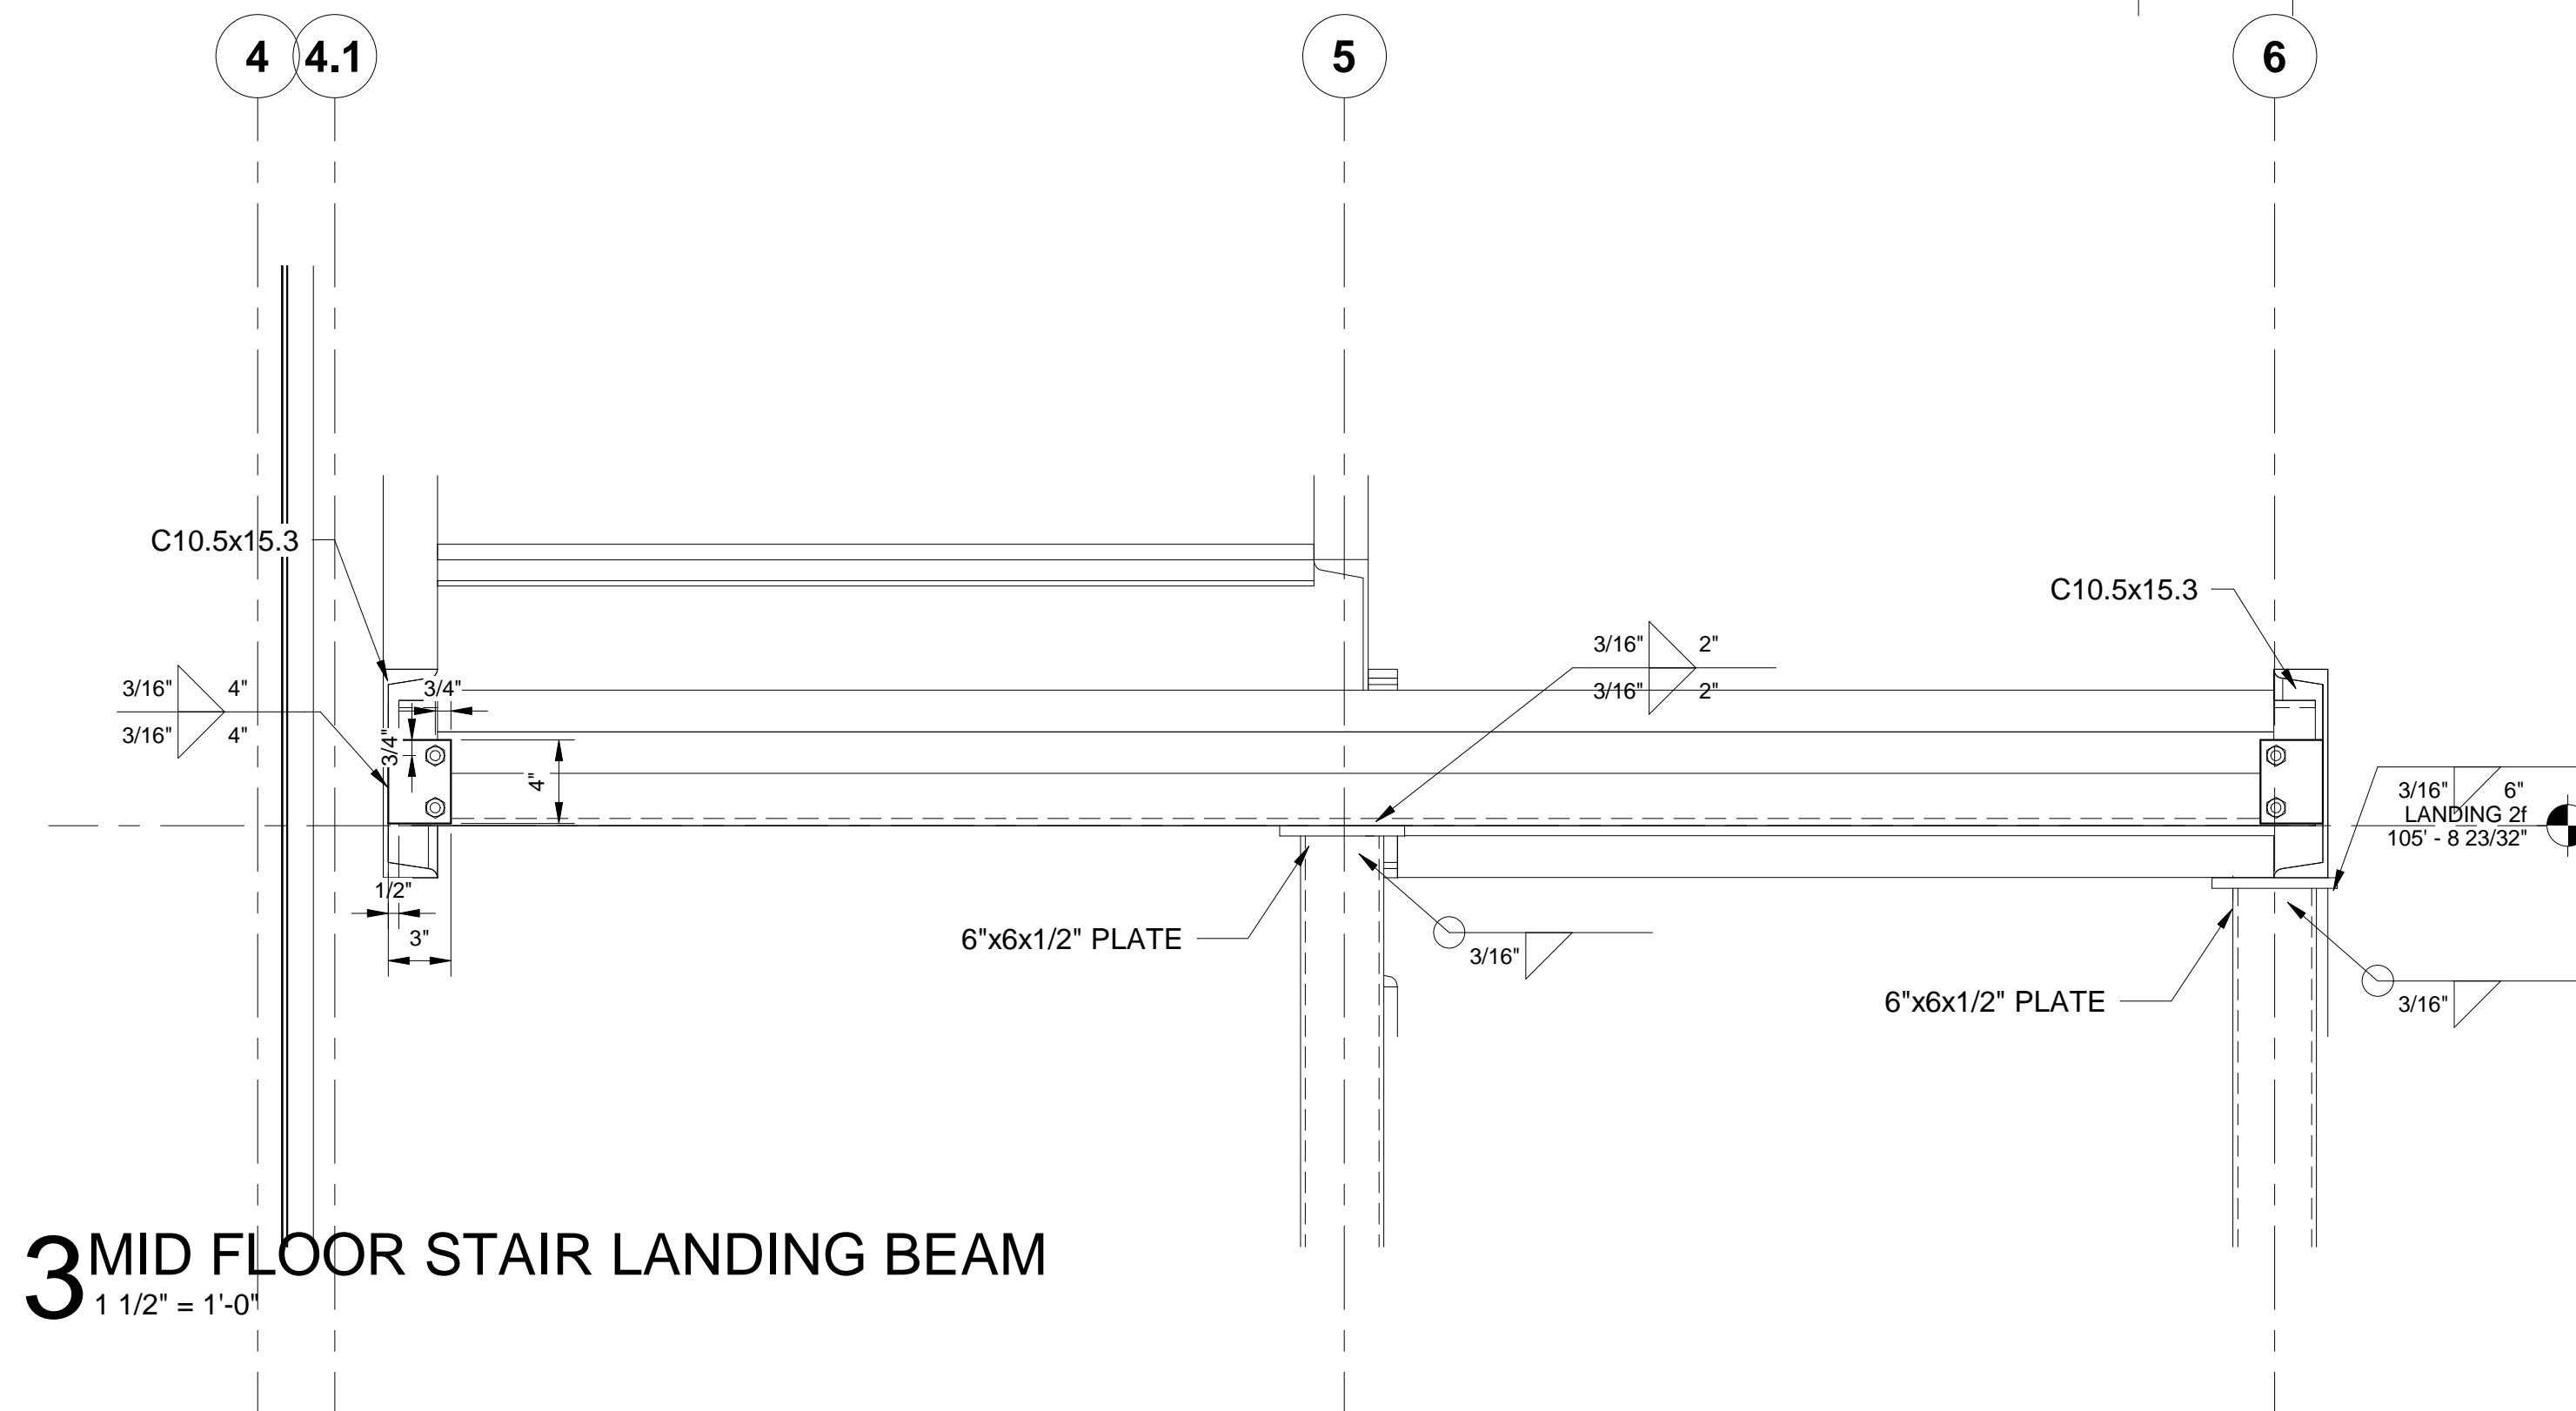
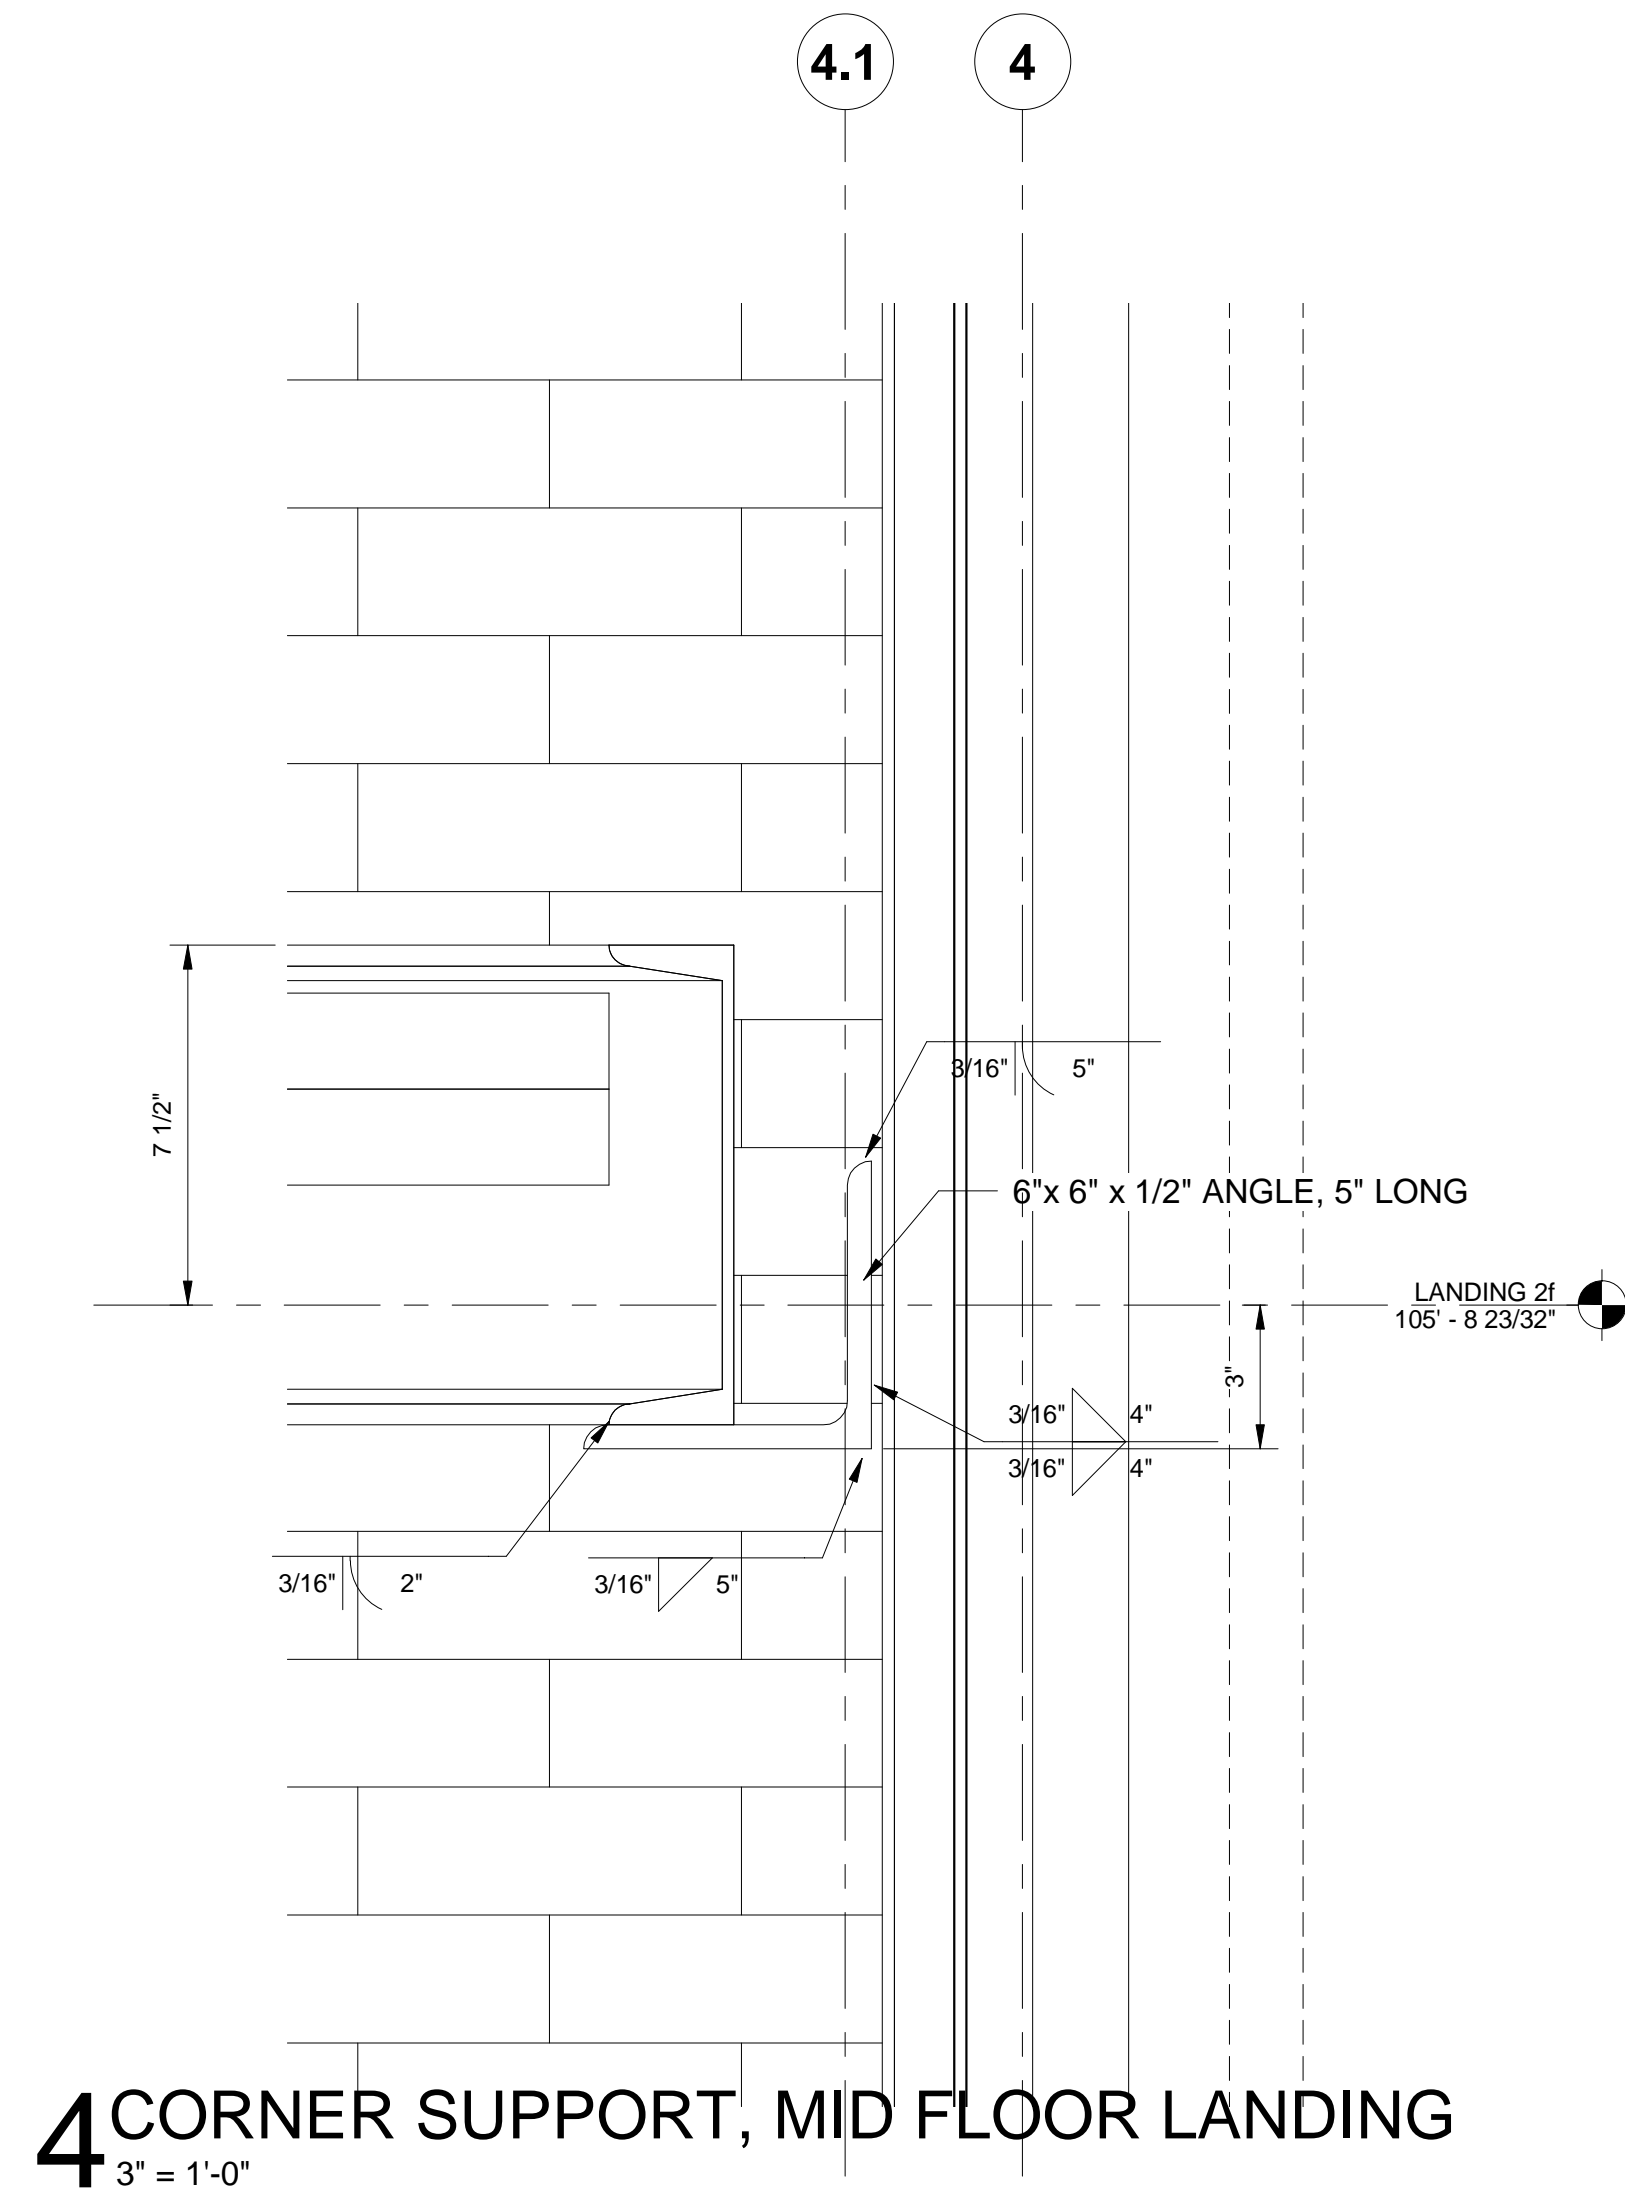
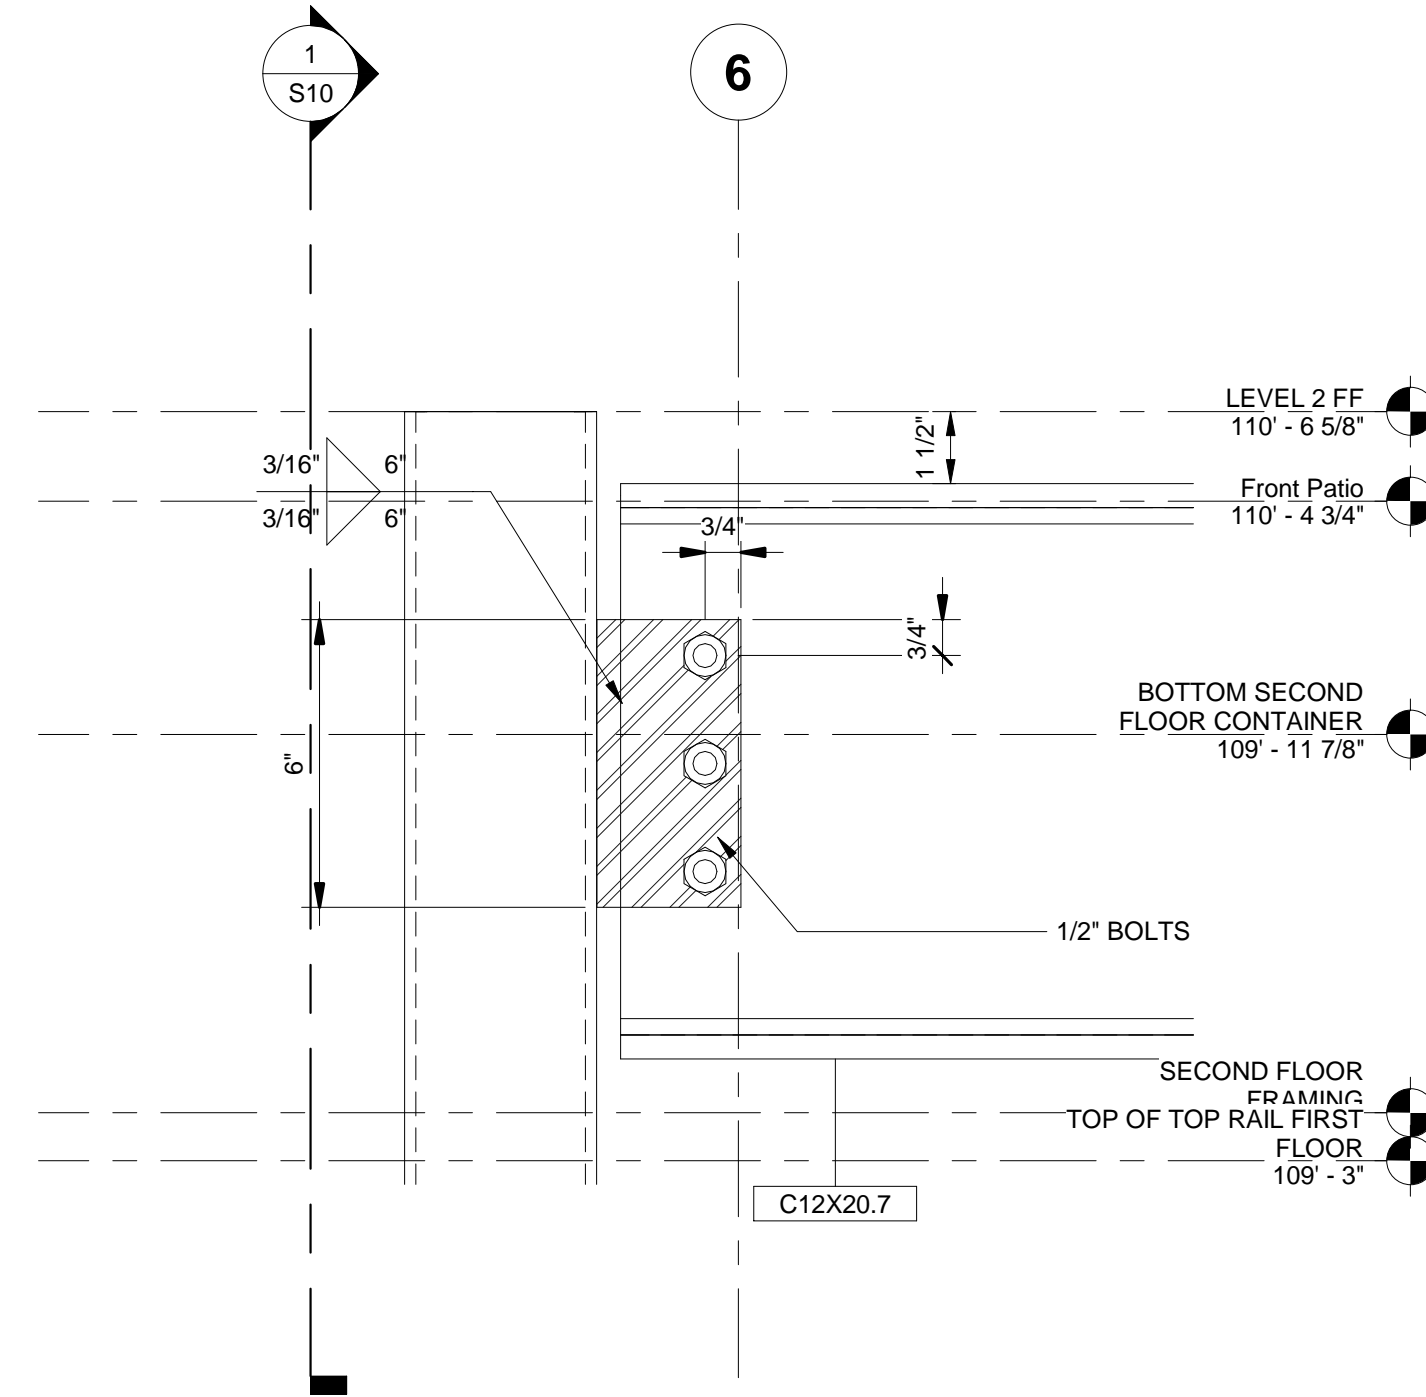
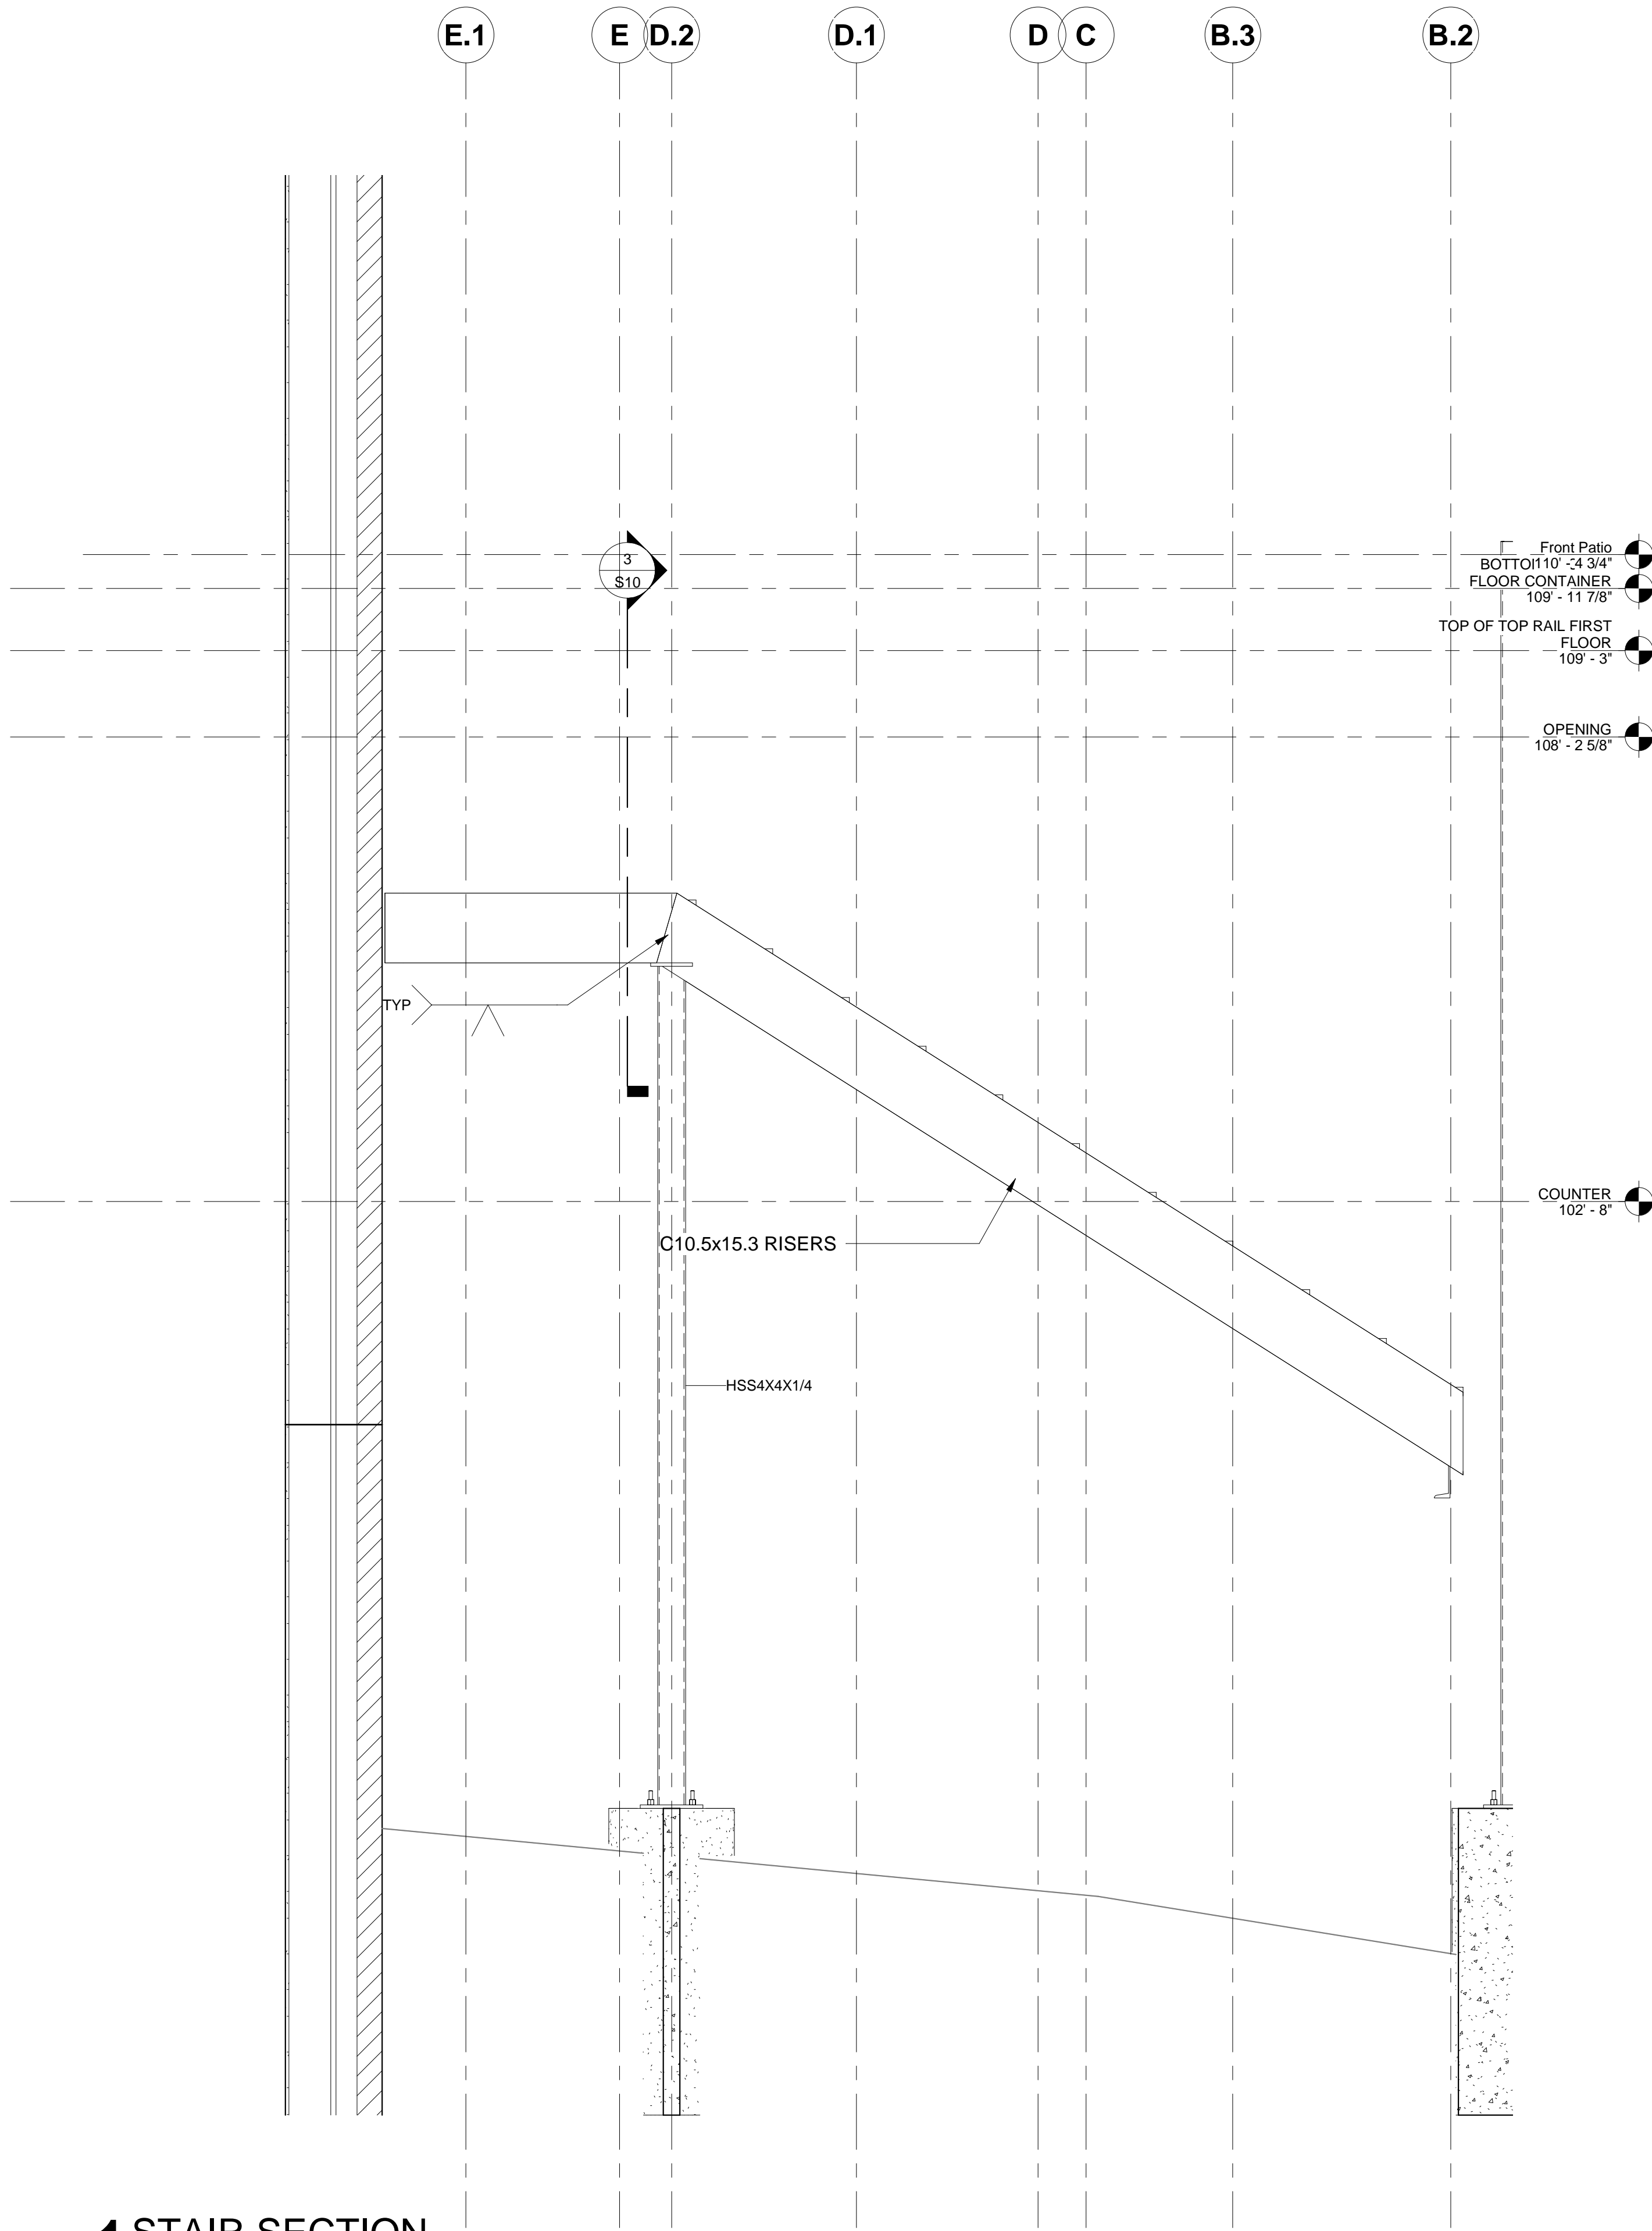
REVISED

SHEET TITLE  
**STAIRWAY  
DETAILS**

SHEET



**S10**

ORIGINAL SHEET SIZE  
24" x 36"






5/29/2020 1:47:07 PM

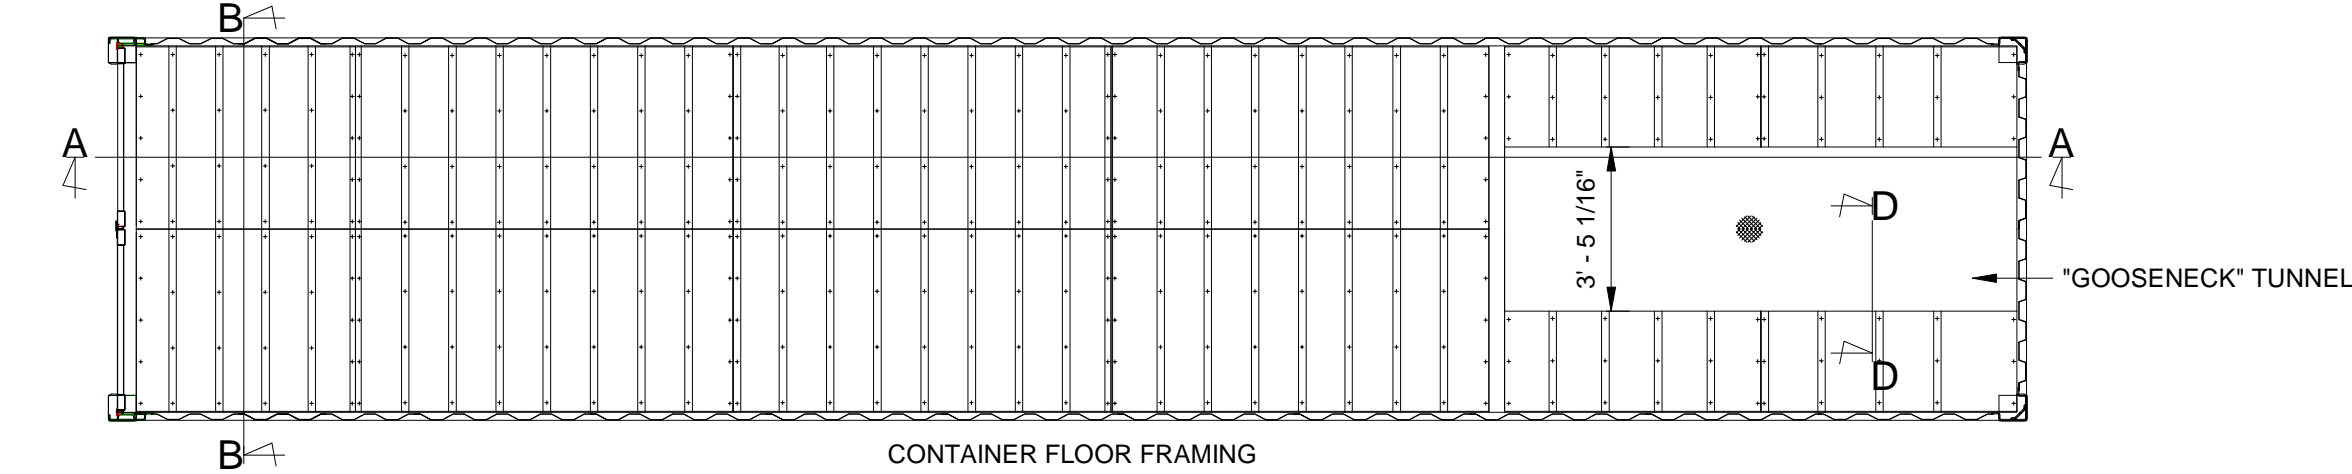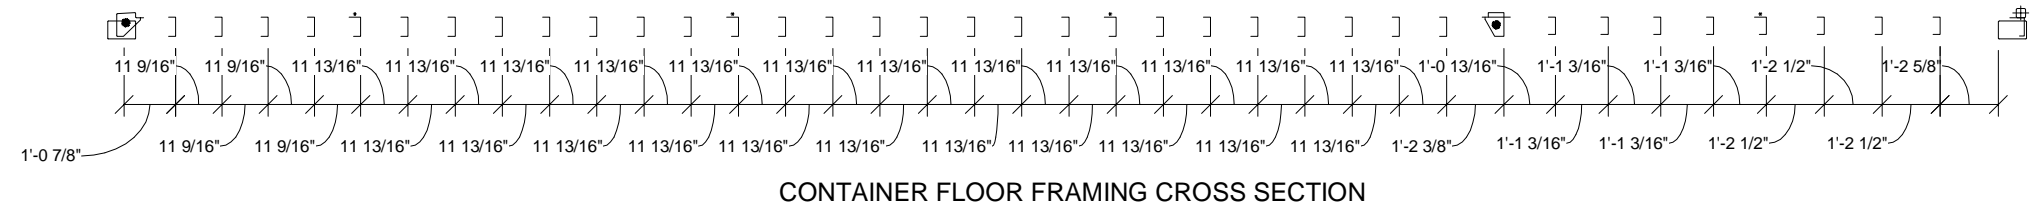








1 TYPICAL CONTAINER  
1/4" = 1'-0"

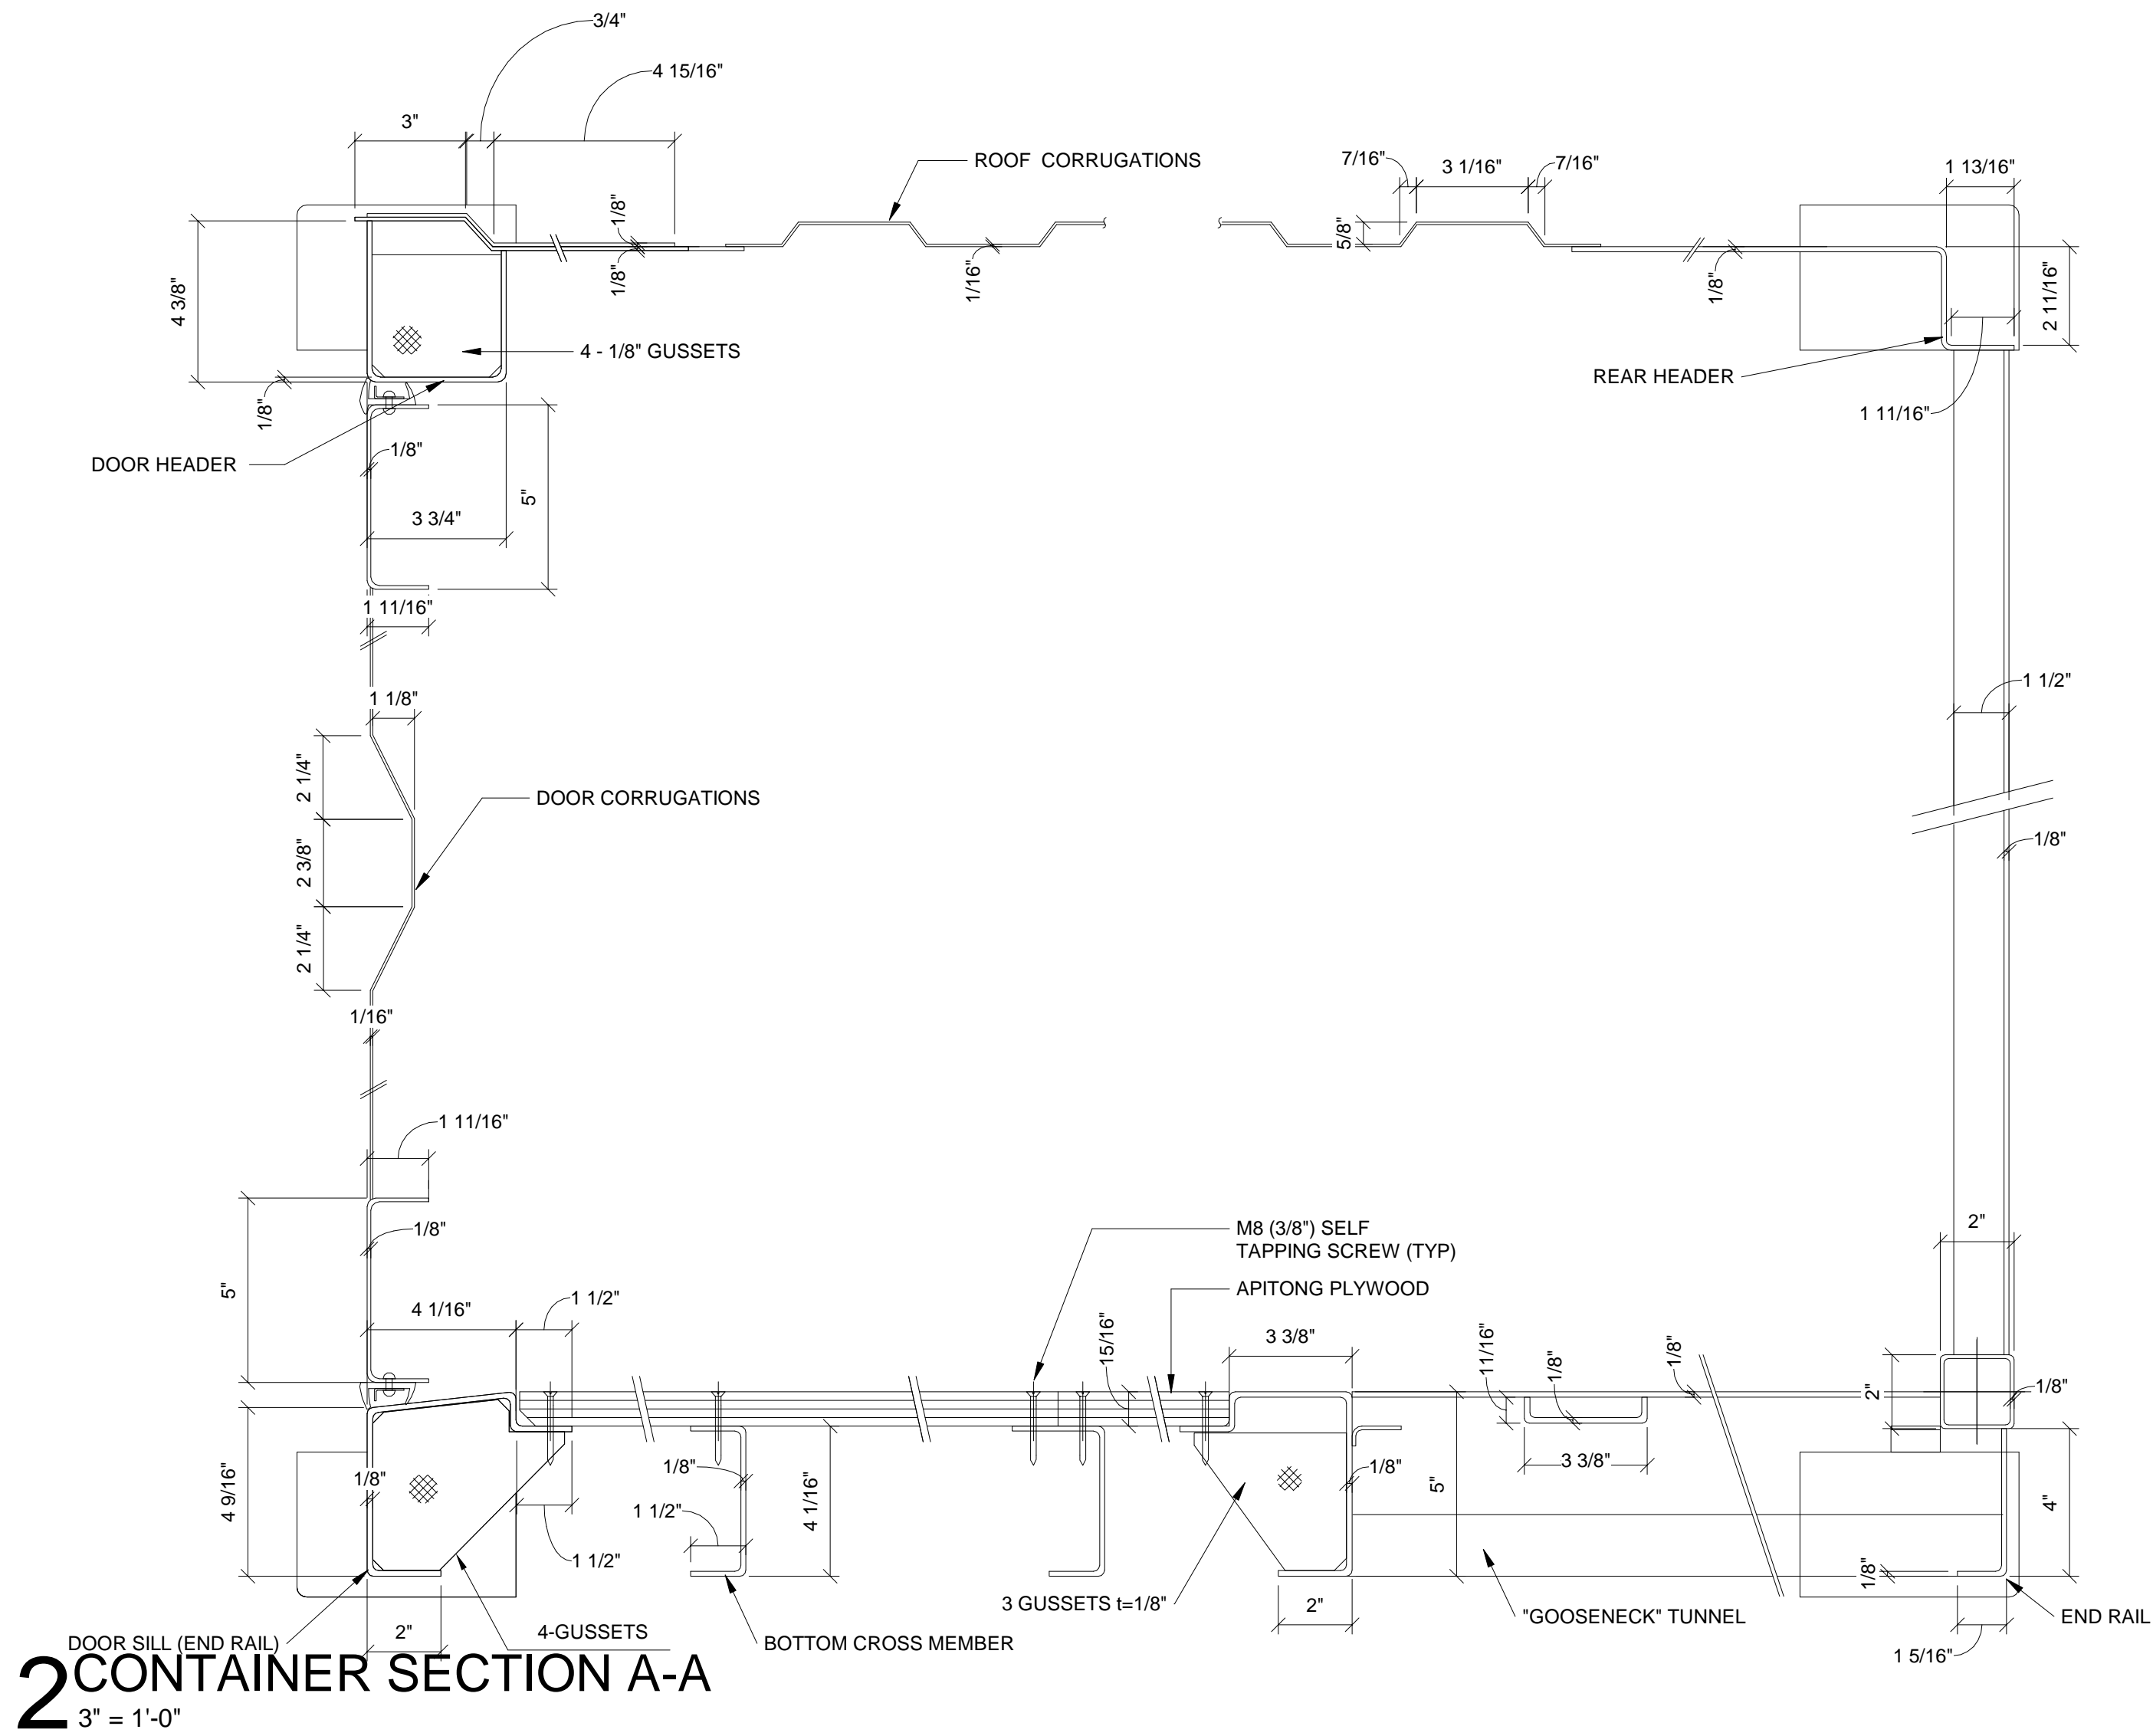

CLASSIFICATION	DIMENSION	
INTERNAL CUBIC CAPACITY	76.2 CU.M	2,690 CU.FT
MAX. GROSS WEIGHT	32,500 KG	71,650 LB
TARE WEIGHT	3,900 KG	8,600 LB
MAX. PAYLOAD	28,600 KG	63,050 LB
STACKING TEST LOAD	97,200 KG	214,290 LB
FLOOR STRENGTH	5,460 KG	12,000 LB

CLASSIFICATION	DIMENSION		
EXTERNAL	LENGTH	+0 12,192 -10 MM	40' 0" -3/8"
	WIDTH	+0 2,438 -5 MM	8' 0" +0" -3/16"
	HEIGHT	+0 2,896 -5 MM	9' - 6" +0" -3/16"
INTERNAL	LENGTH	12,032 MM	39' 5 11/16"
	WIDTH	2,352 MM	7' 8 19/32"
	HEIGHT	2,695 MM	8' 10 1/8"
DOOR OPENING	WIDTH	+0 2,340 -5 MM	7' 8 1/8" +0" -3/16"
	HEIGHT	+0 2,585 -5 MM	8' 5 3/4" +0" -1/4"

PART NAME	MATERIAL	REMARK
FRAME	SIDE RAIL	SPA-H IS JIS G3125 STANDARD, ASTM A588 IS US EQUIVALENT
	END RAIL	SPA-H IS JIS G3125 STANDARD, ASTM A588 IS US EQUIVALENT
	CORNER POST	SPA-H IS JIS G3125 STANDARD, ASTM A588 IS US EQUIVALENT
	CROSS MEMBER	SPA-H IS JIS G3125 STANDARD, ASTM A588 IS US EQUIVALENT
PANEL	DOOR	SPA-H IS JIS G3125 STANDARD, ASTM A588 IS US EQUIVALENT
	ROOF	SPA-H IS JIS G3125 STANDARD, ASTM A588 IS US EQUIVALENT
	SIDE	SPA-H IS JIS G3125 STANDARD, ASTM A588 IS US EQUIVALENT
FLOOR	FRONT	SPA-H IS JIS G3125 STANDARD, ASTM A588 IS US EQUIVALENT
		PLYWOOD - APITONG OR APPROVED EQUAL 19-PLY

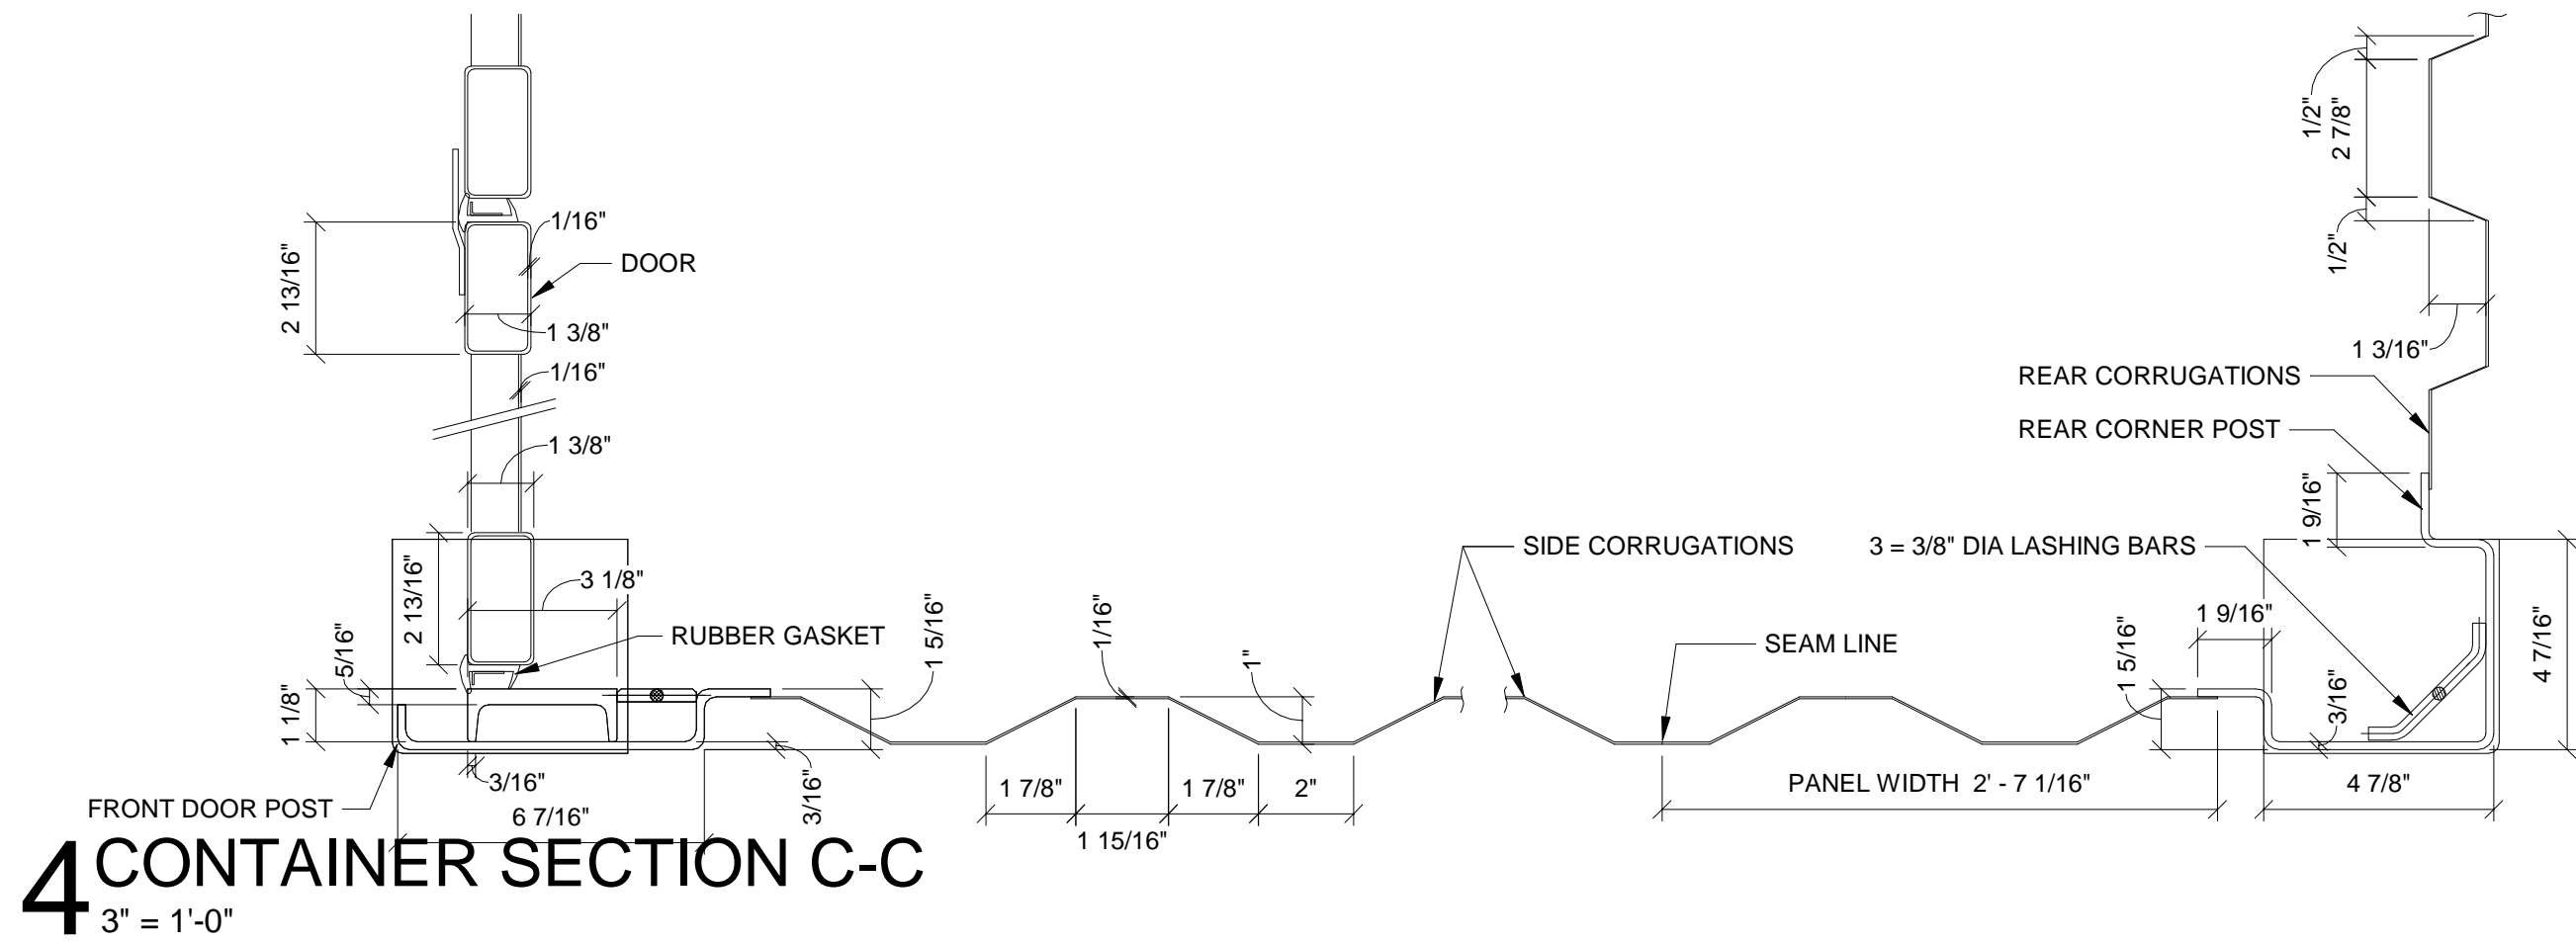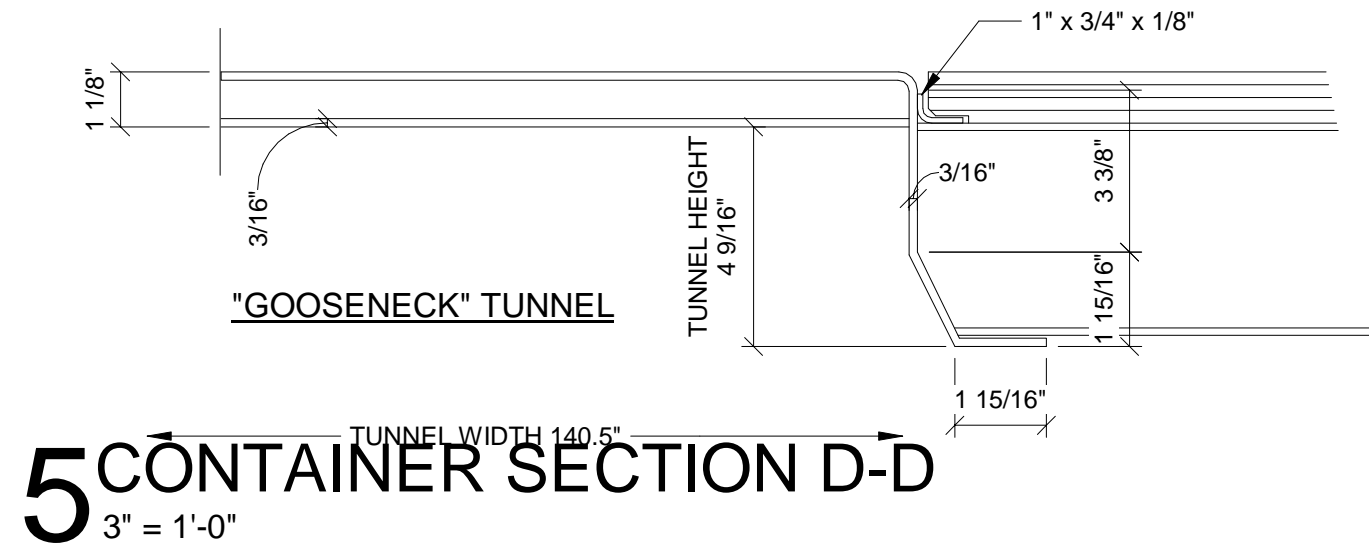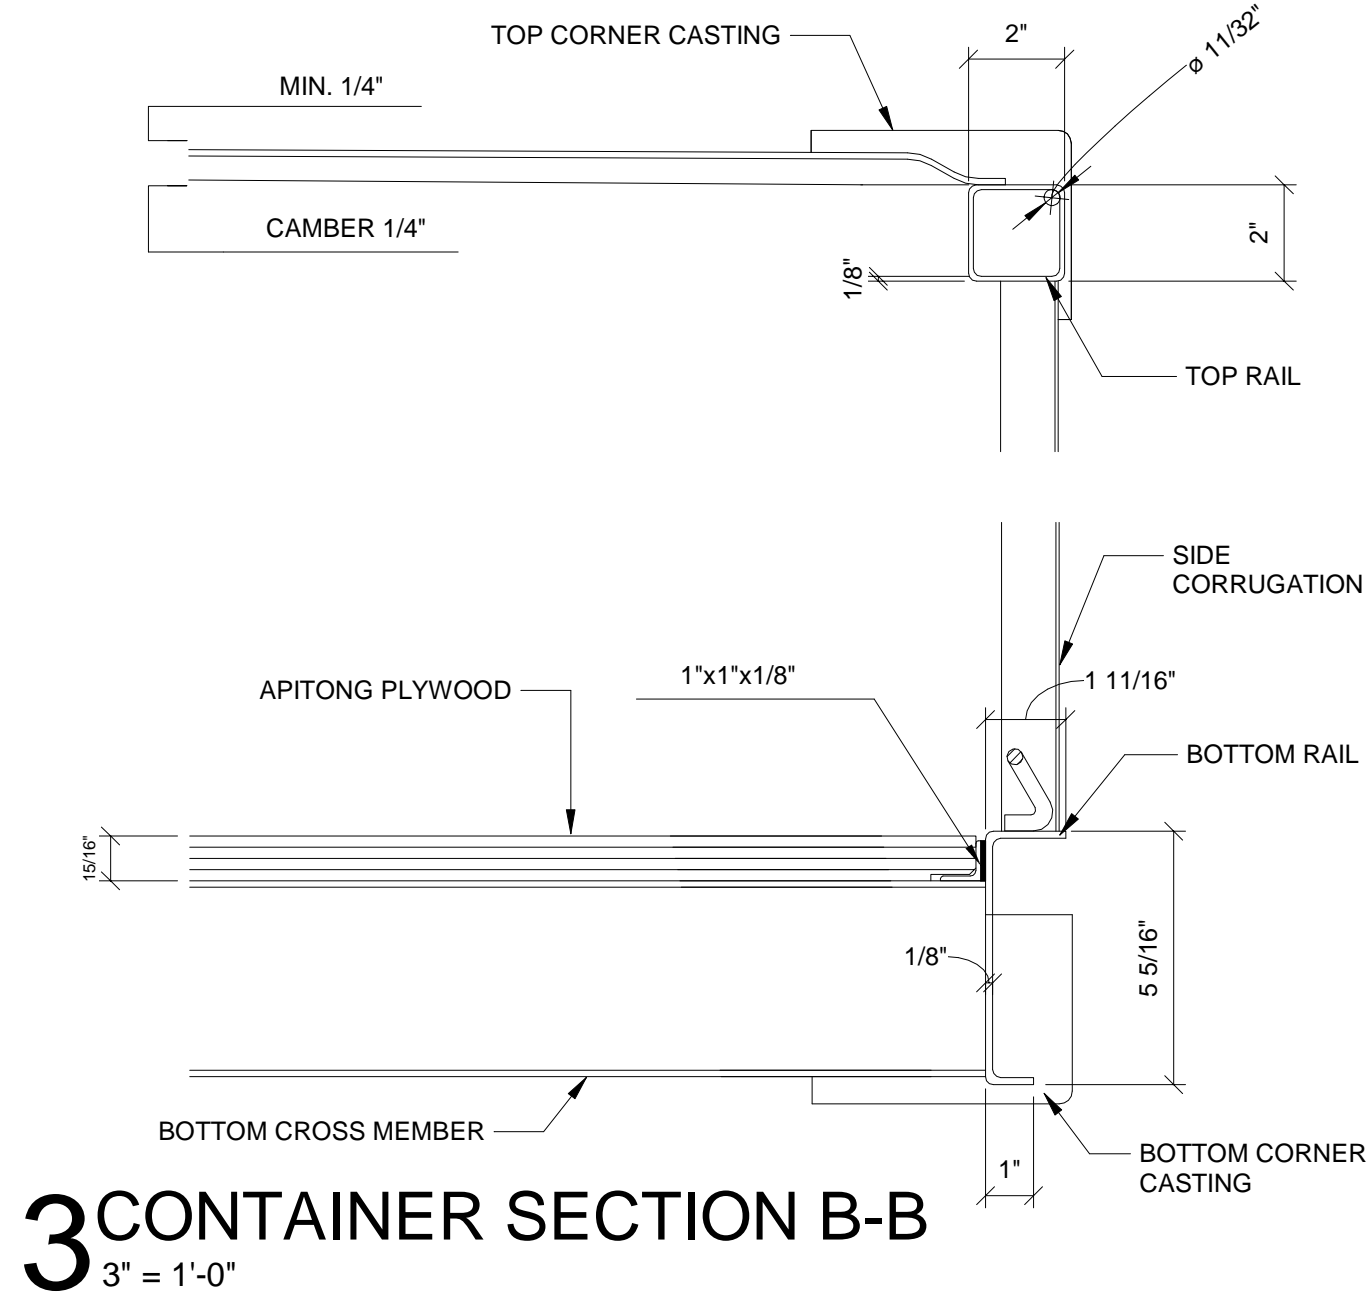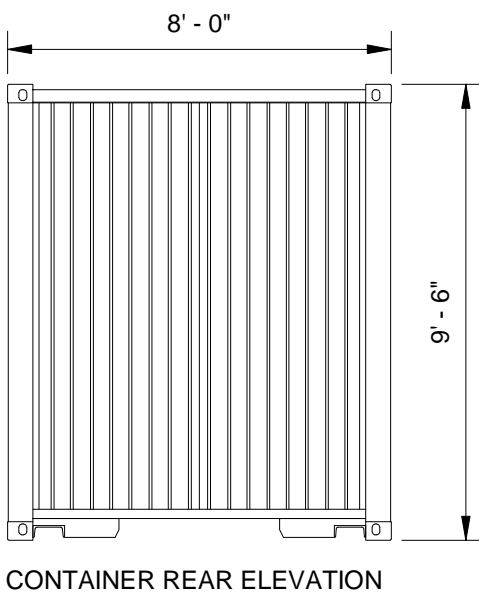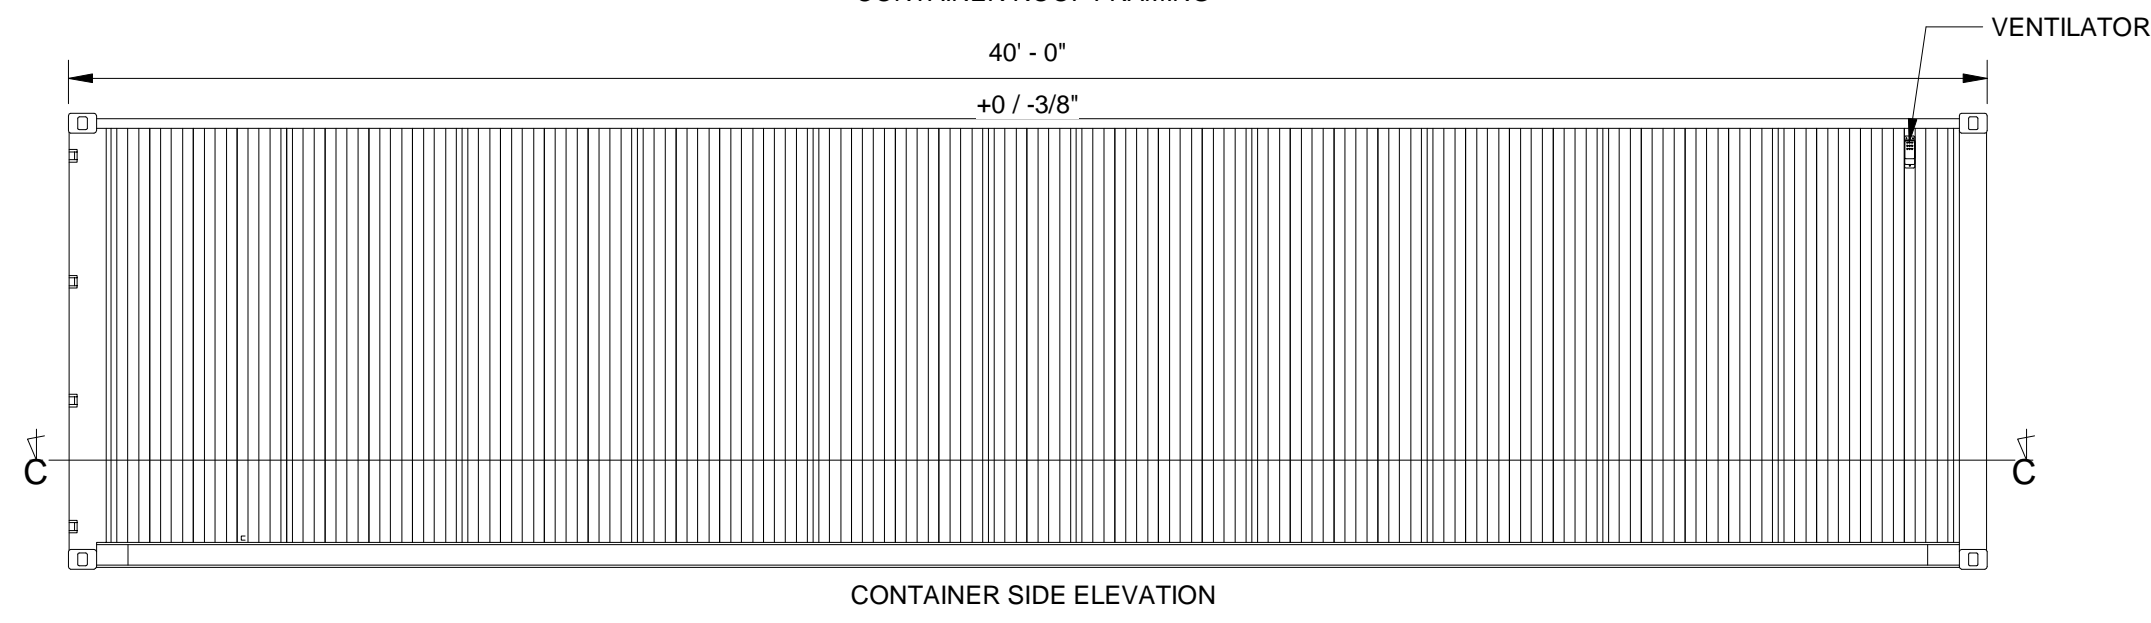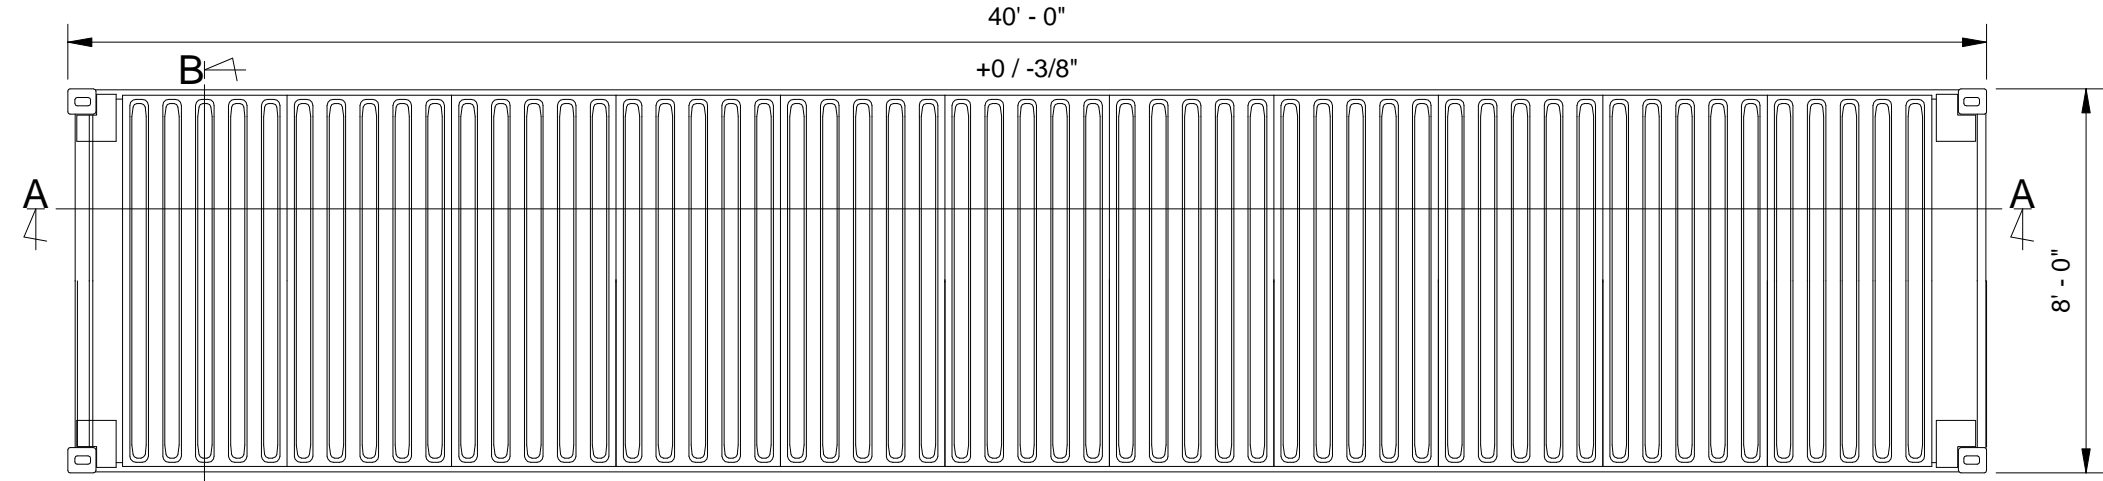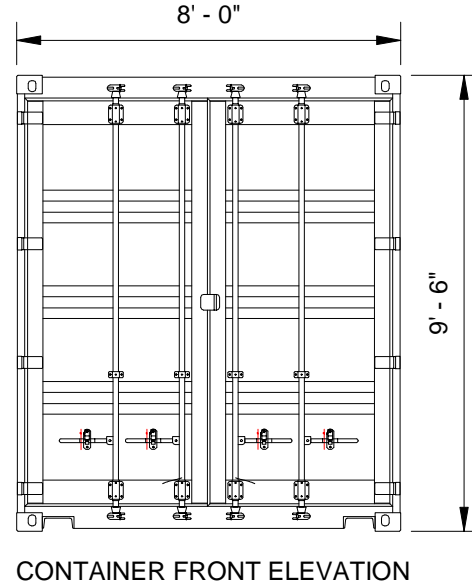

CONTAINER COFFEE SHOP  
79 SOUTH MAIN STREET  
PITTSBURGH, PA

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SHEET TITLE  
CONTAINER  
DETAILS

SHEET

S11  
ORIGINAL SHEET SIZE  
24" x 36"


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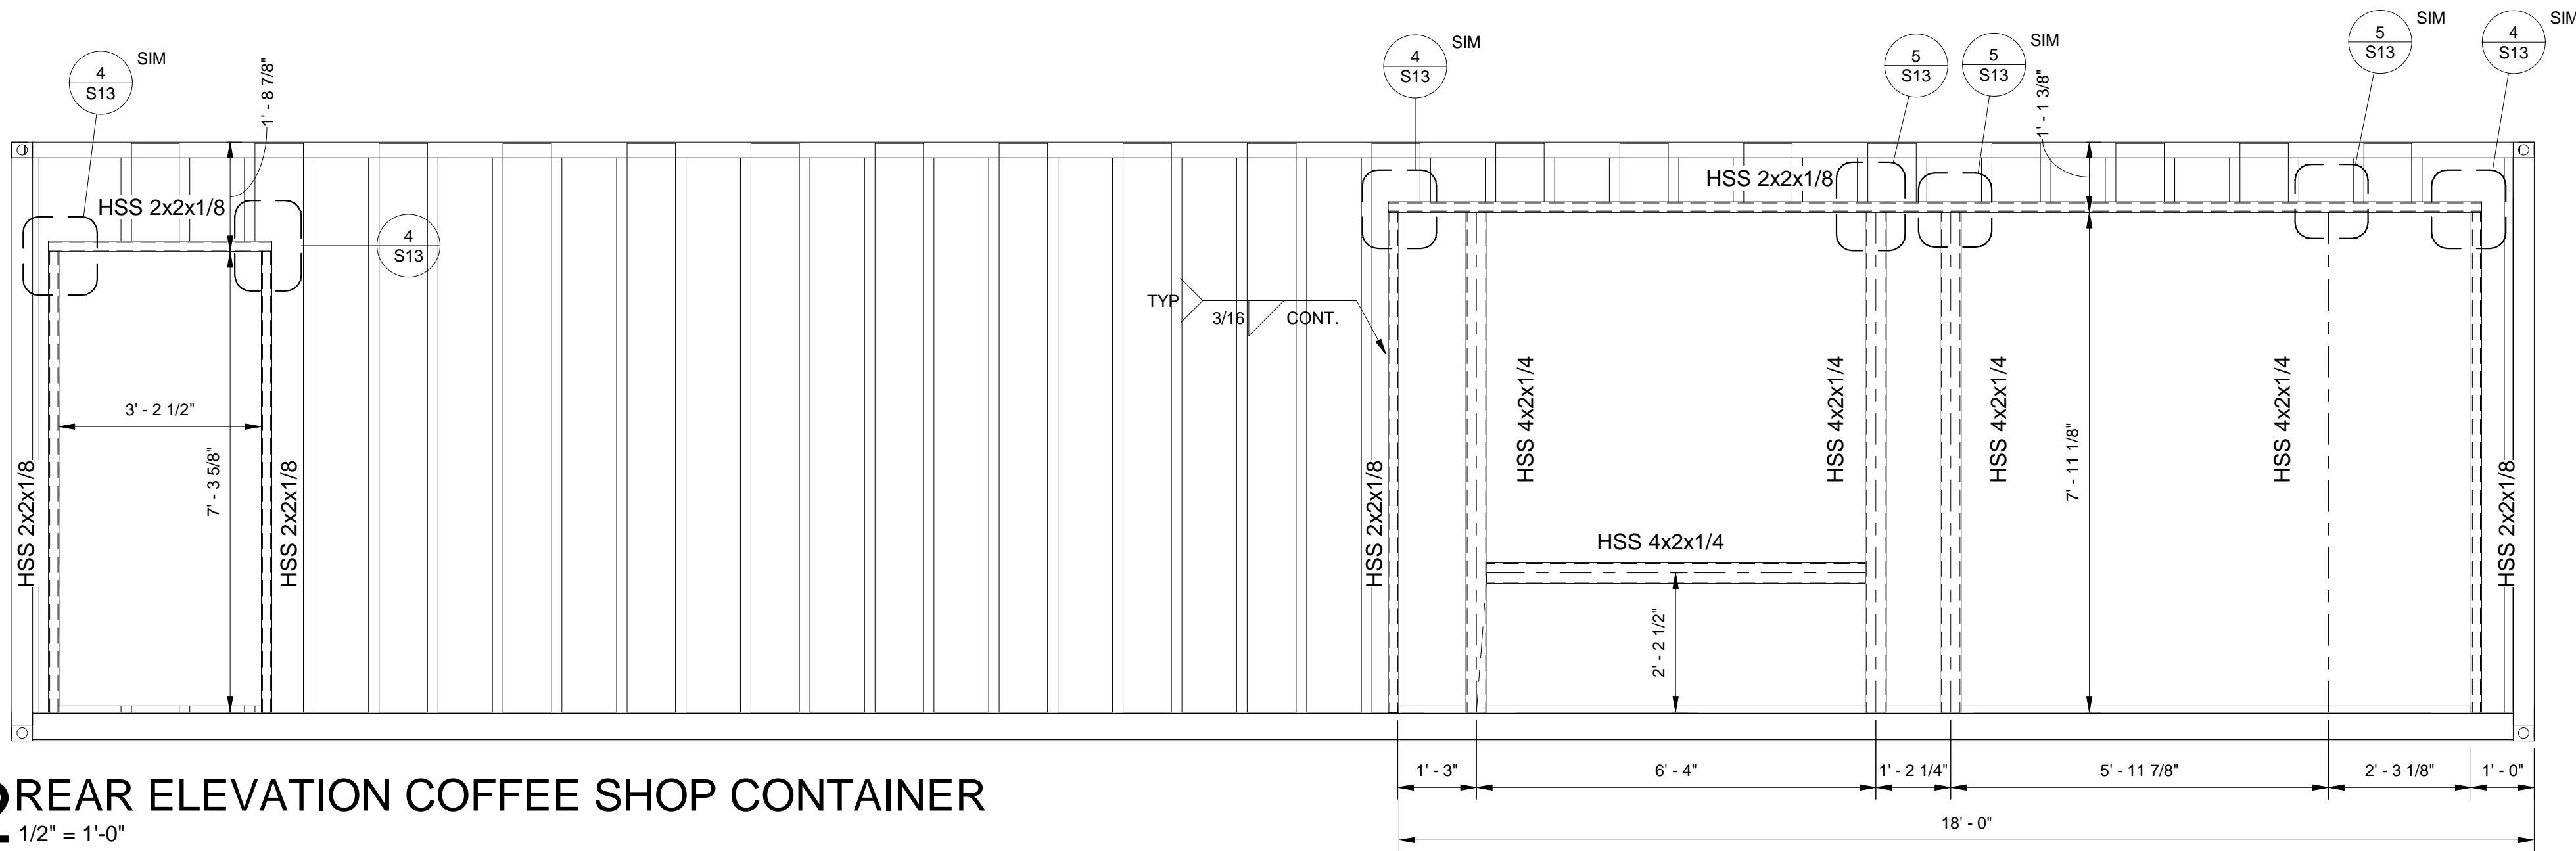
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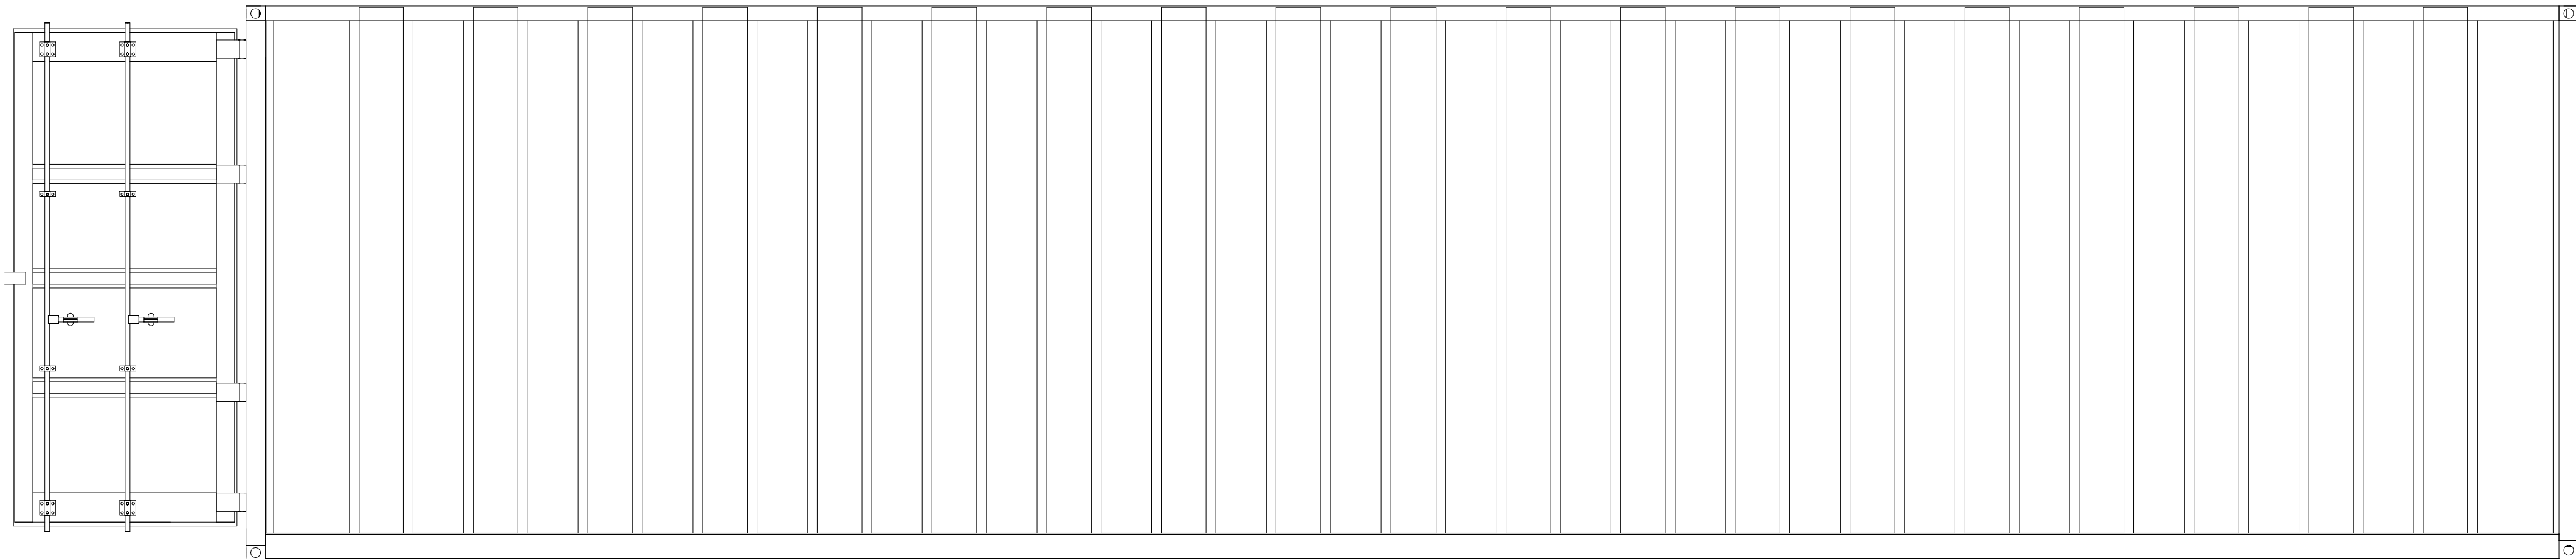




1 COFFEE SHOP CONTAINER FLOOR PLAN  
1/2" = 1'-0"



2 REAR ELEVATION COFFEE SHOP CONTAINER  
1/2" = 1'-0"

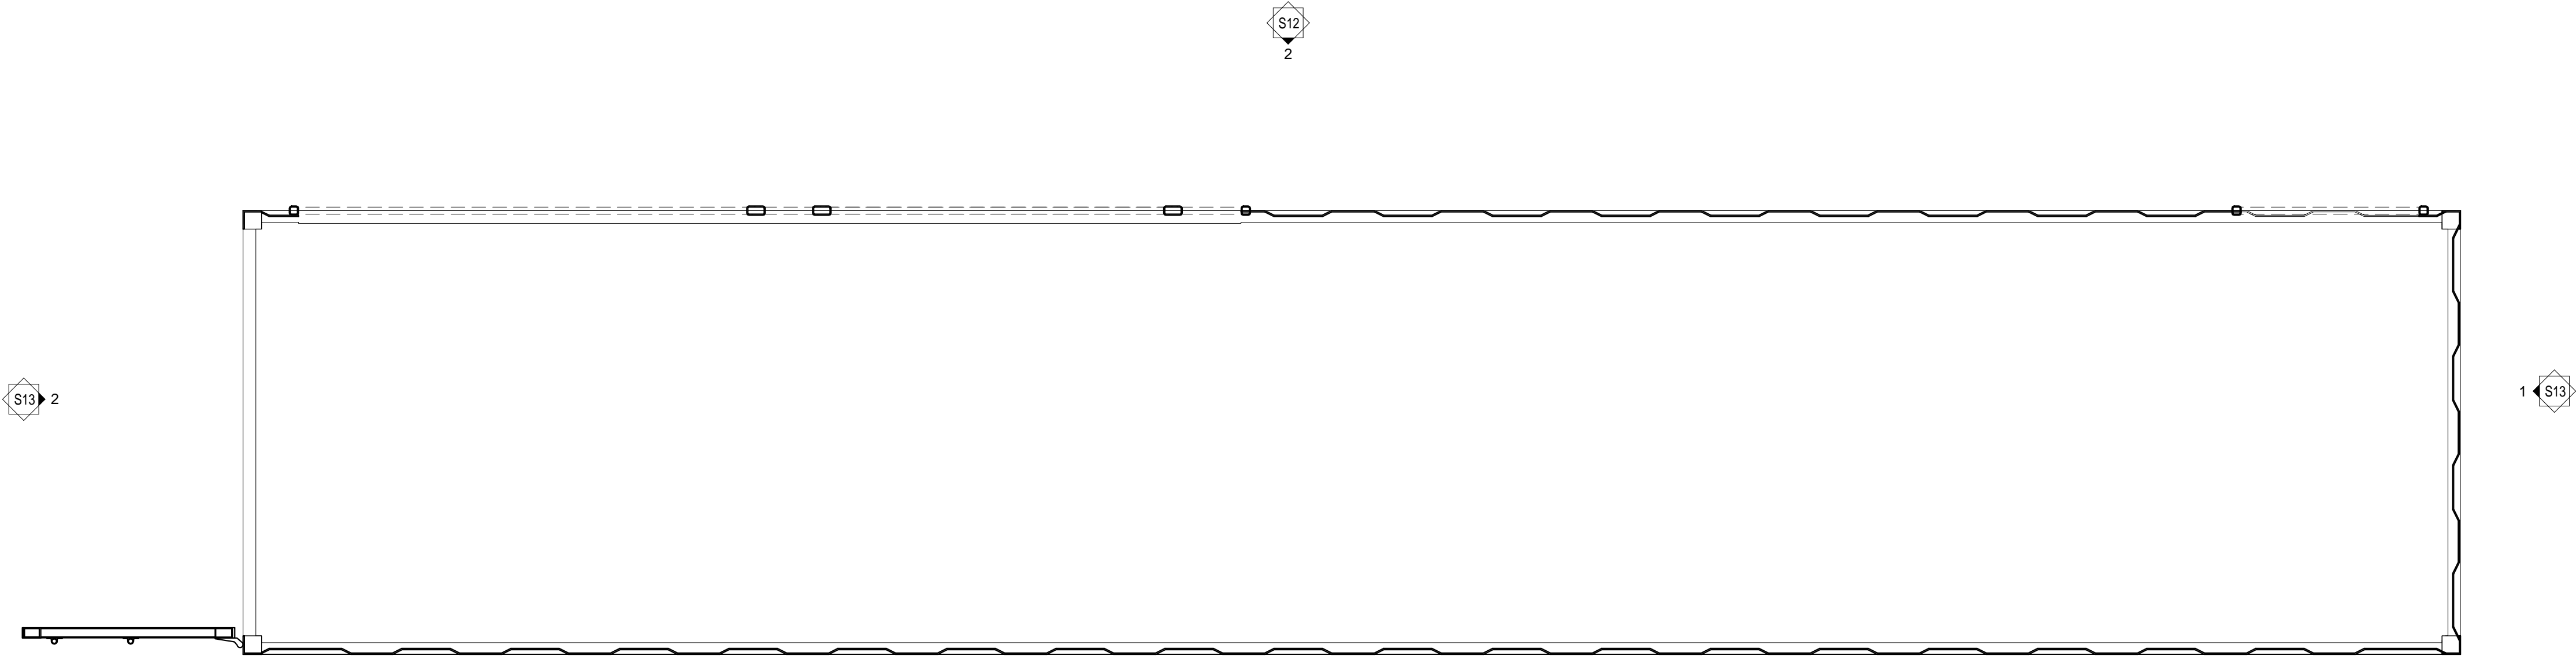

3 FRONT ELEVATION COFFEE SHOP CONTAINER  
1/2" = 1'-0"

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DRAWN gwr	CHECKED Checker


REVISED

SHEET  
COFFEE  
SHOP  
CONTAINER I


SHEET

S12  
ORIGINAL SHEET SIZE  
24" x 36"




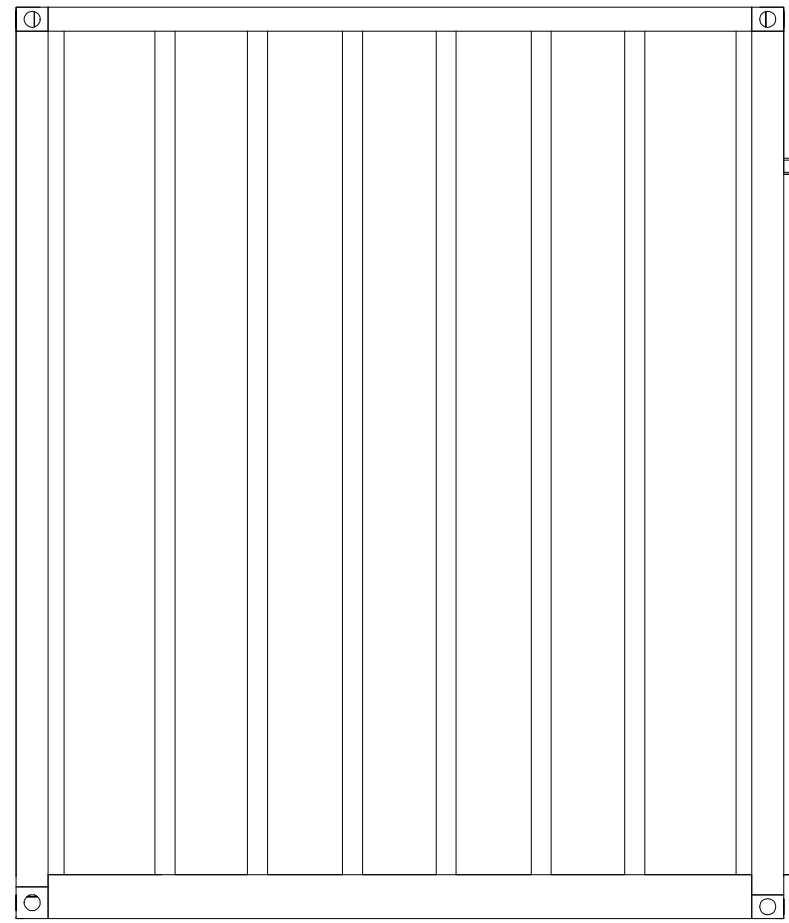


1 RIGHT ELEVATION COFFEE SHOP CONTAINER  
1/2" = 1'-0"

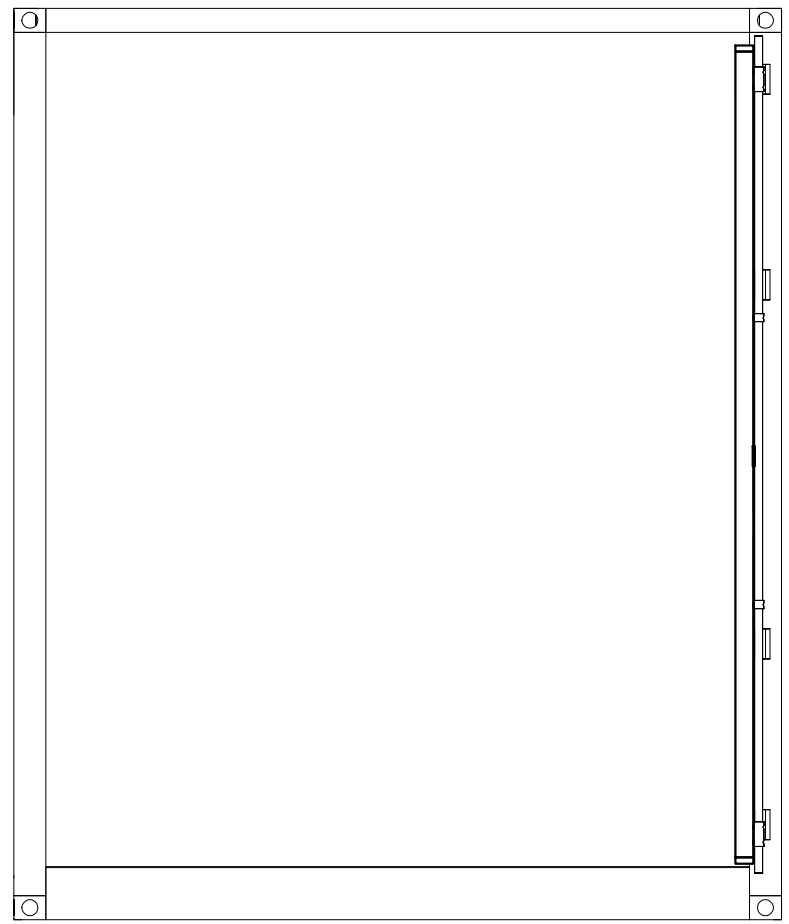


2 LEFT ELEVATION COFFEE SHOP CONTAINER  
1/2" = 1'-0"

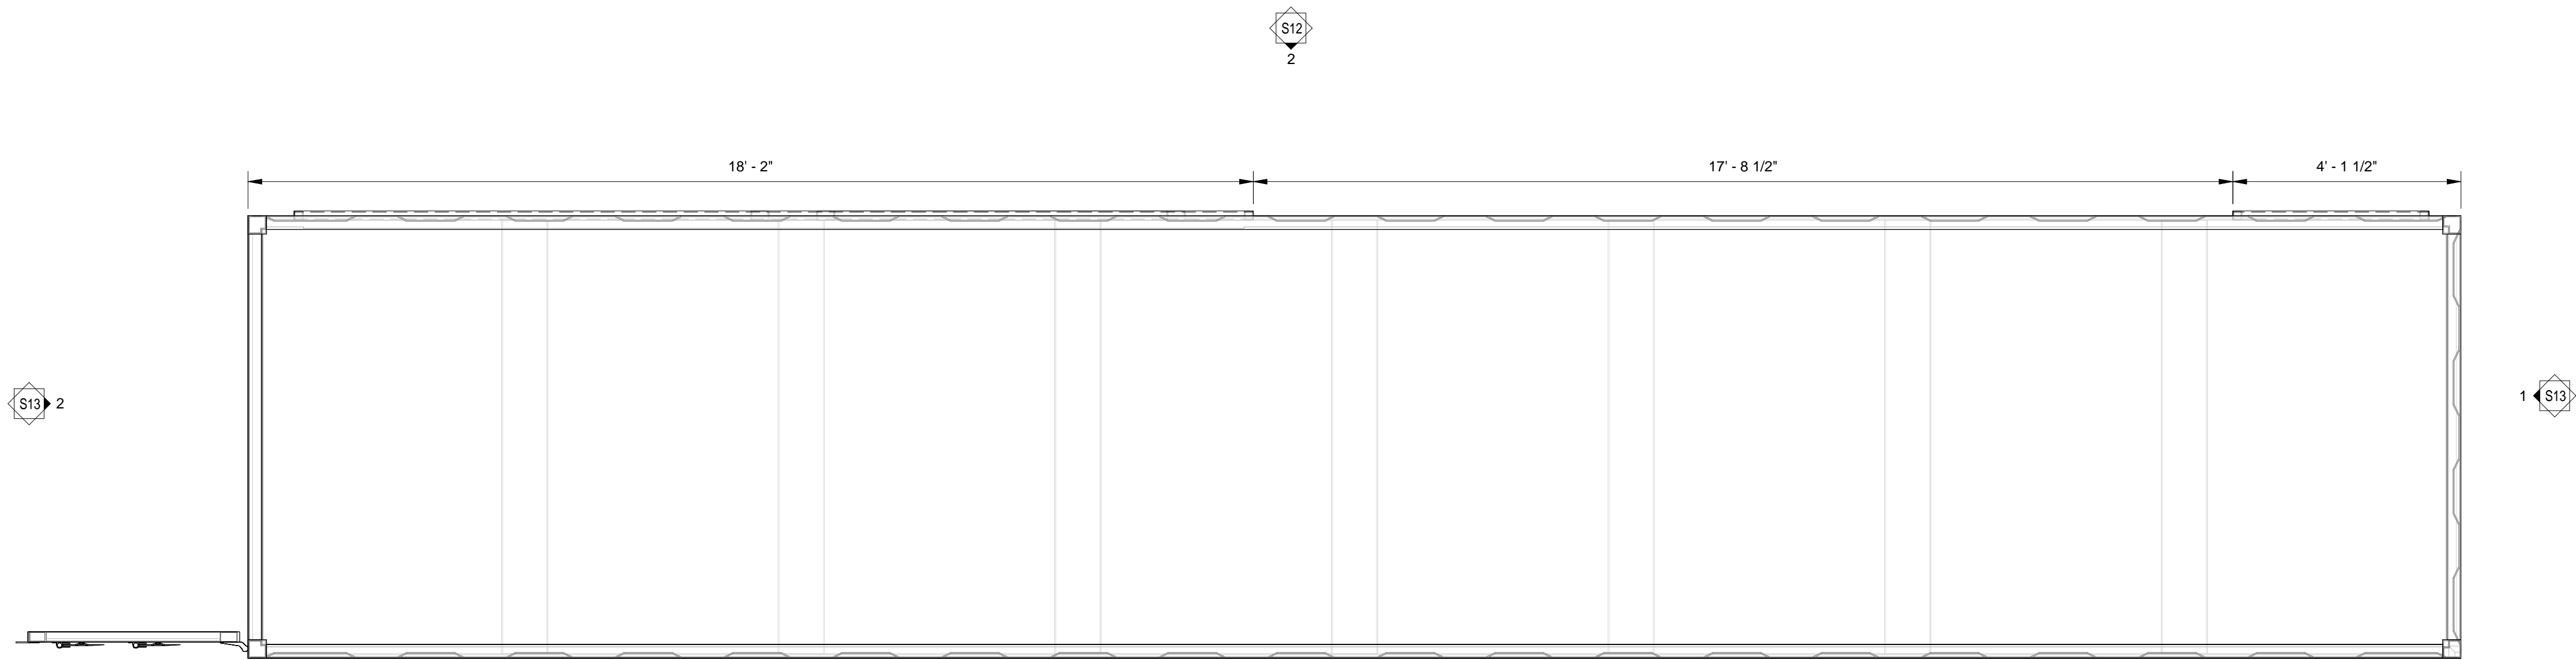

3 TOP VIEW COFFEE SHOP CONTAINER  
1/2" = 1'-0"

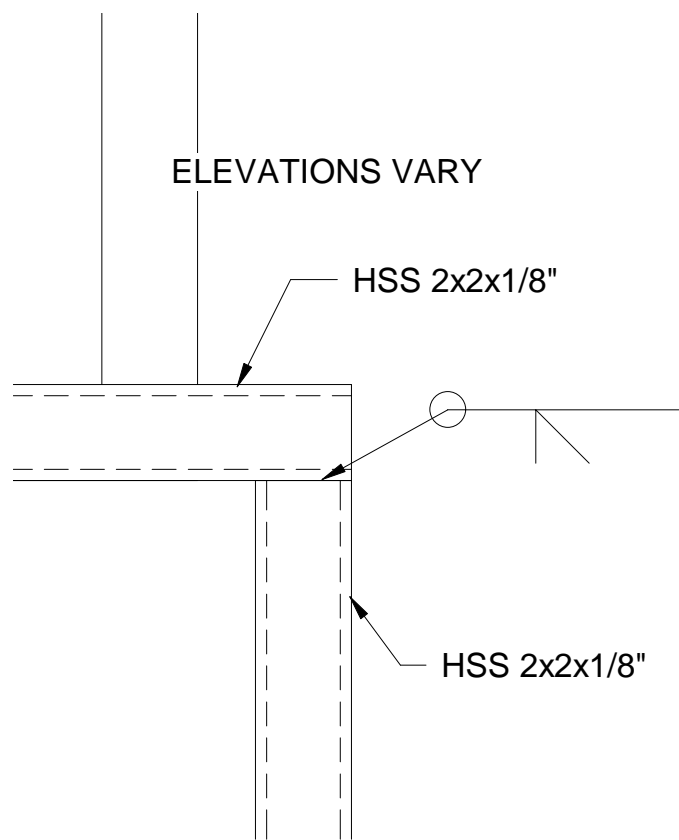

4 DOOR FRAME WELD  
3" = 1'-0"

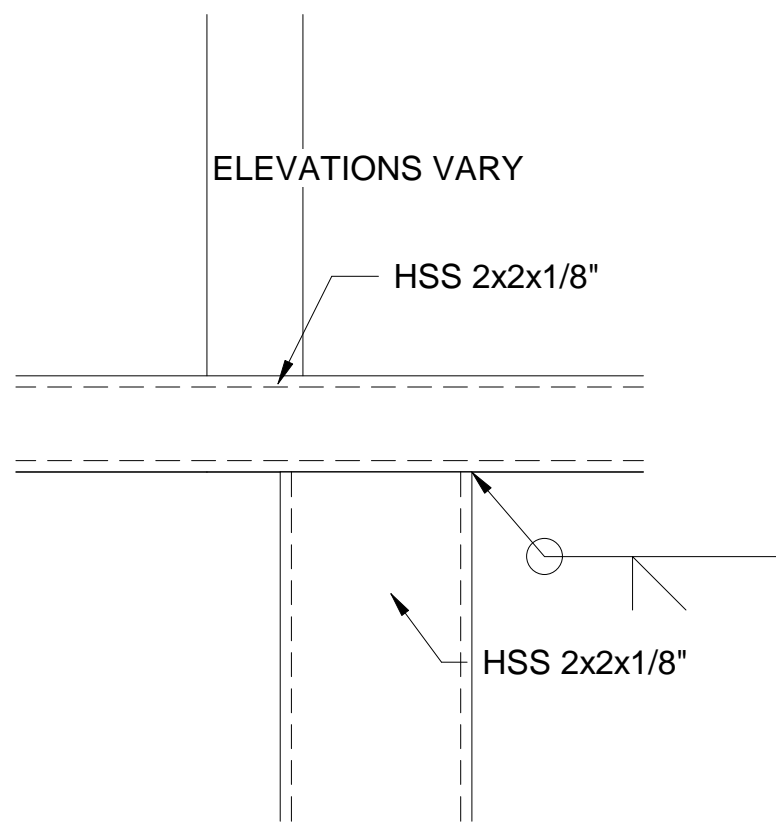

5 HSS 4x2x1/4 WELD  
3" = 1'-0"

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SHEET  
COFFEE  
SHOP  
CONTAINER II

SHEET

S13  
ORIGINAL SHEET SIZE  
24" x 36"





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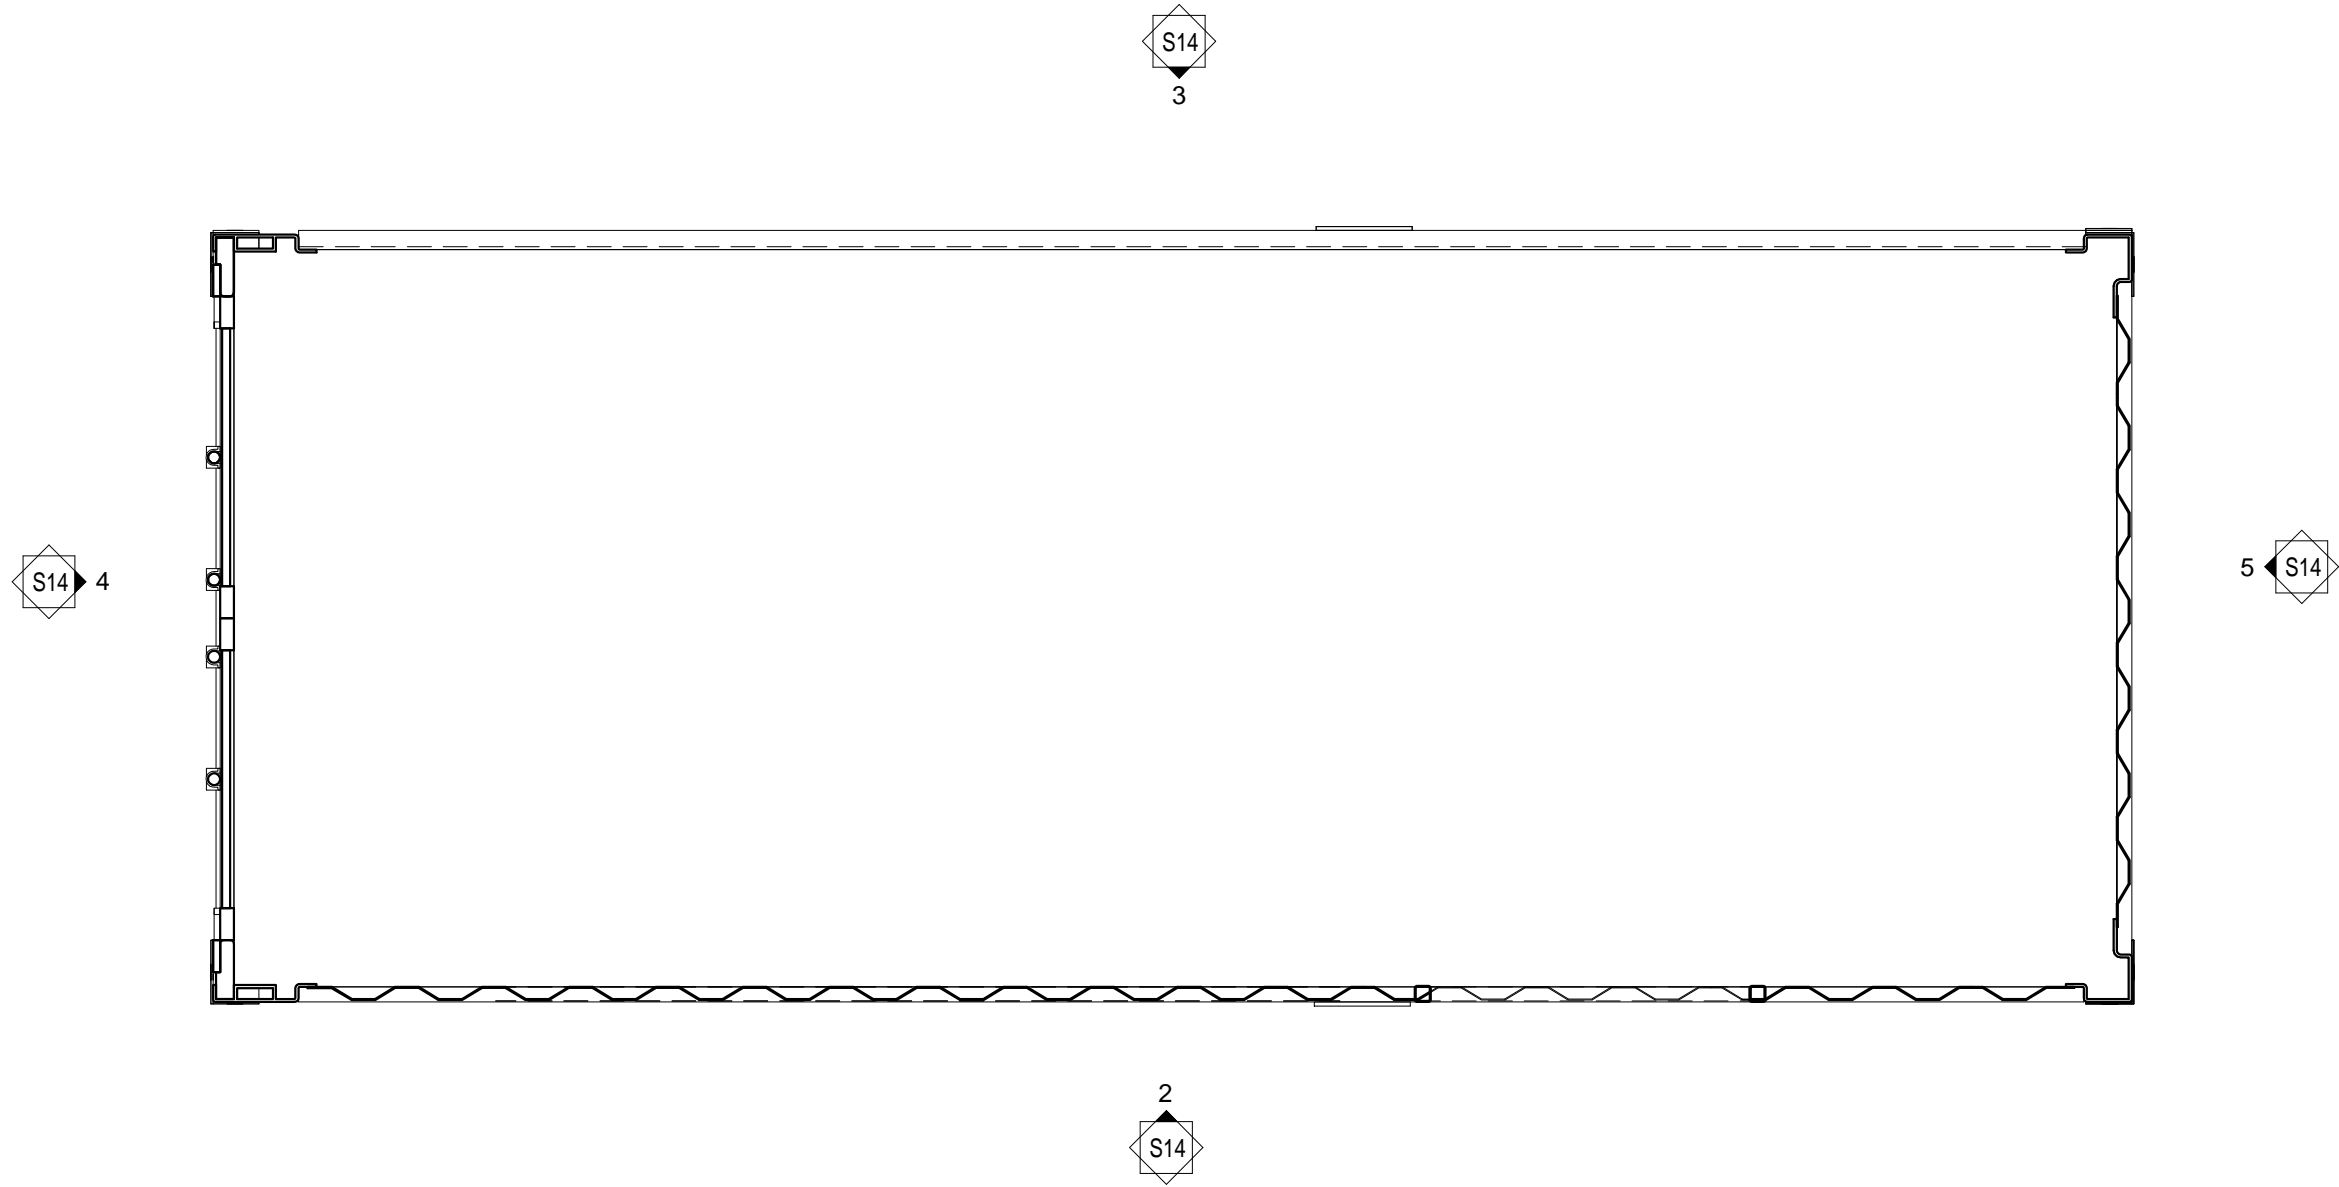
PROJECT 19176	DATE 5-29-2020
DRAWN gwr	CHECKED Checker

REVISED

SH: FRONT 20  
FOOT  
CONTAINER


SHEET

S14  
ORIGINAL SHEET SIZE  
24" x 36"




1 FRONT 20 FOOT CONTAINER FLOOR PLAN

1/2" = 1'-0"

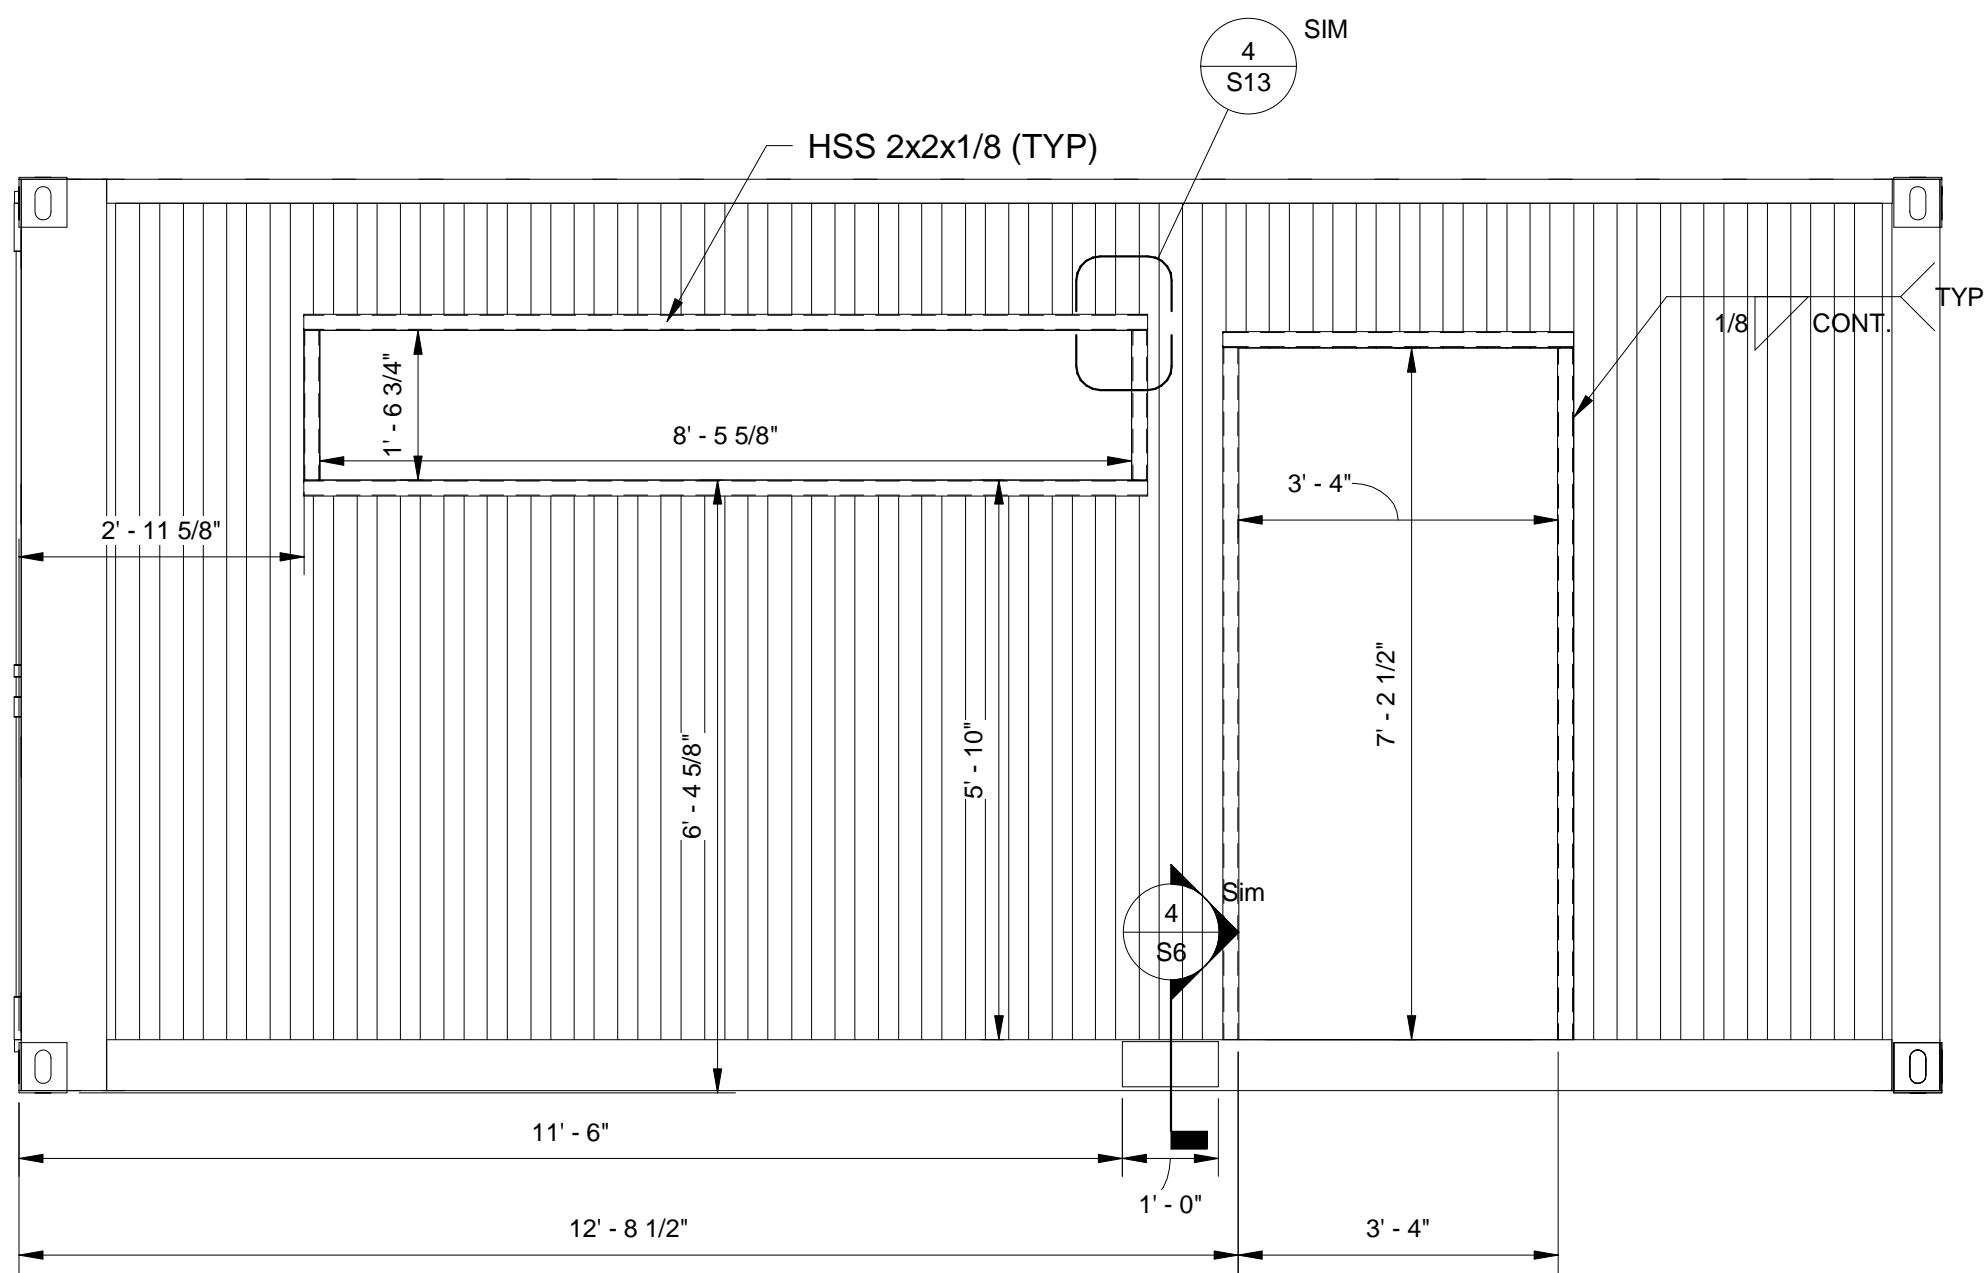


2 FRONT ELEVATION FRONT 20 FOOT CONTAINER

1/2" = 1'-0"

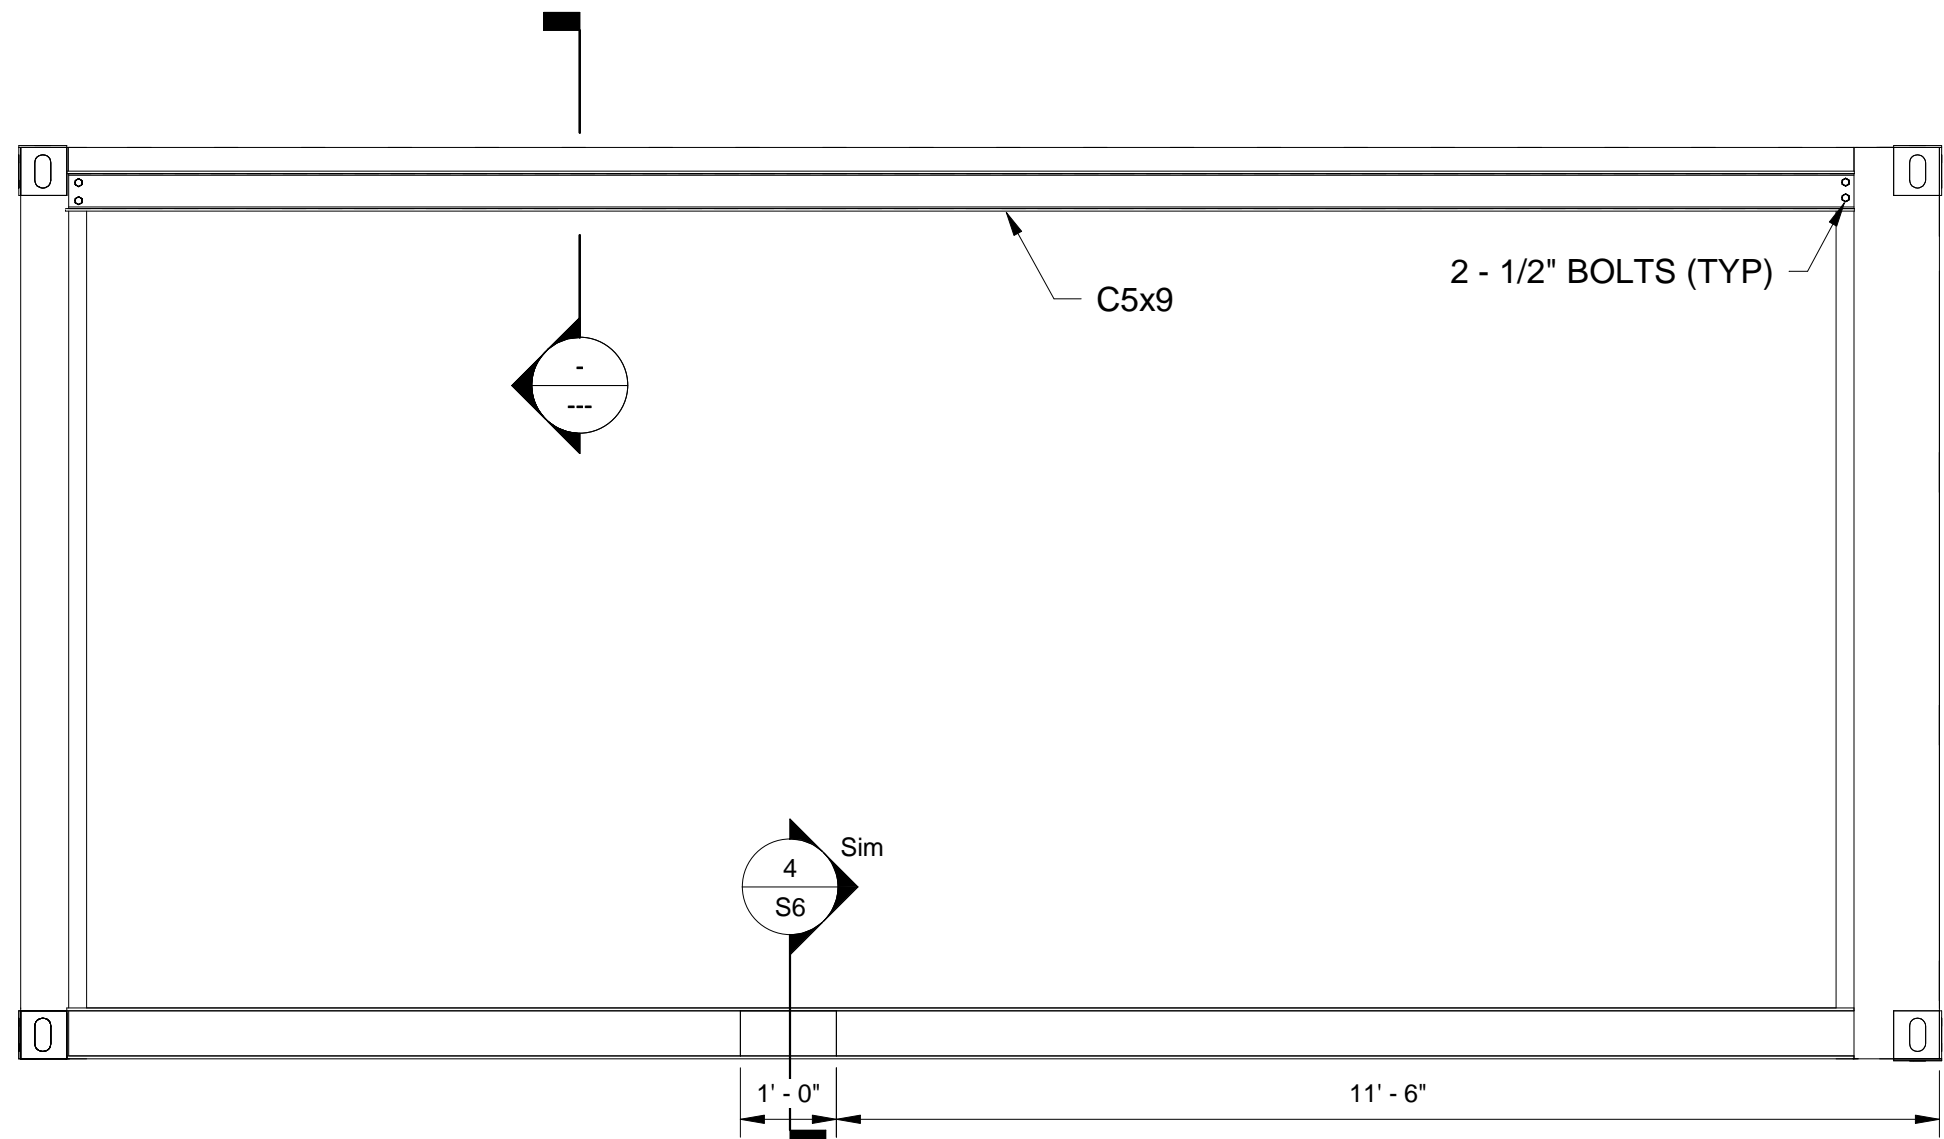


3 REAR ELEVATION FRONT 20 FOOT CONTAINER

1/2" = 1'-0"

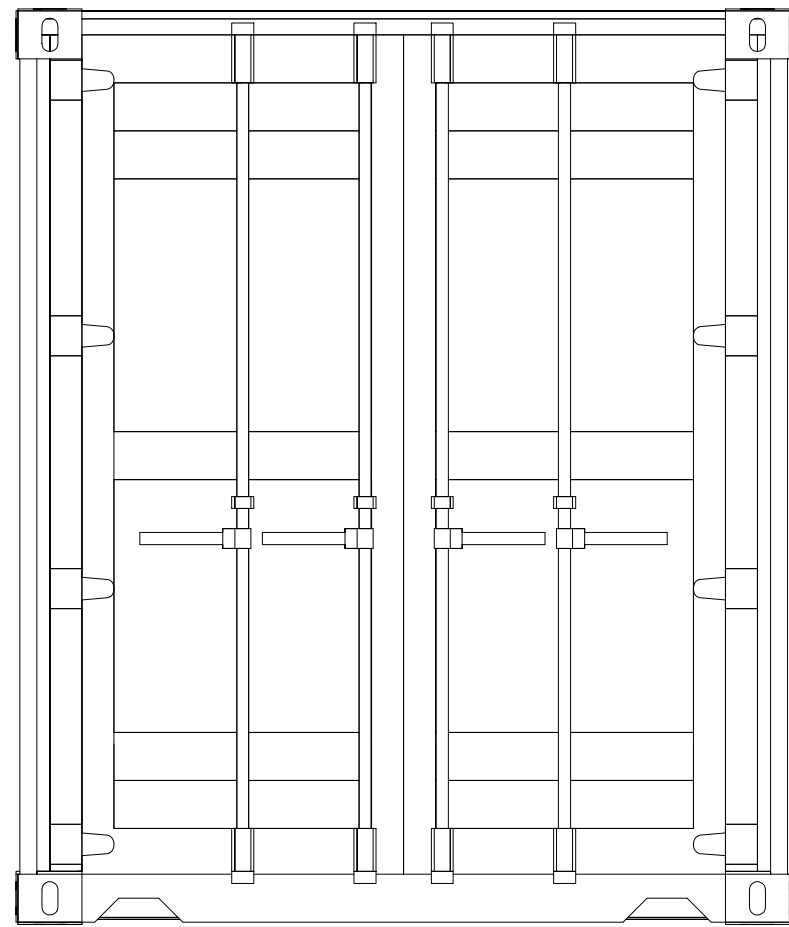


4 LEFT ELEVATION FRONT 20 FOOT CONTAINER

1/2" = 1'-0"

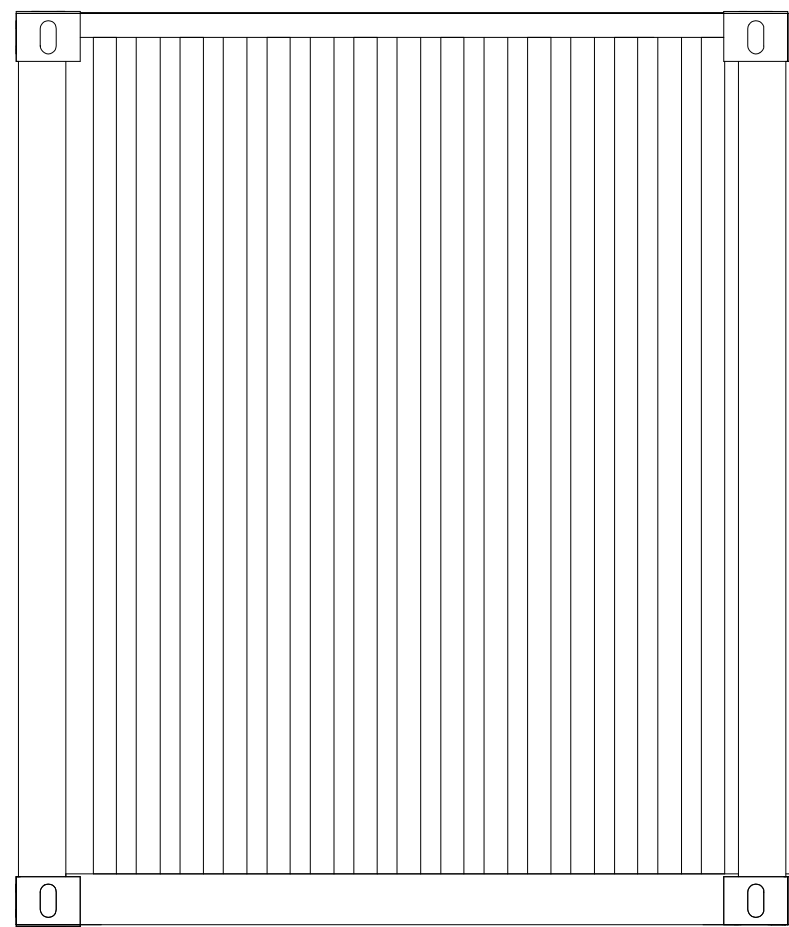

5 RIGHT ELEVATION FRONT 20 FOOT CONTAINER

1/2" = 1'-0"

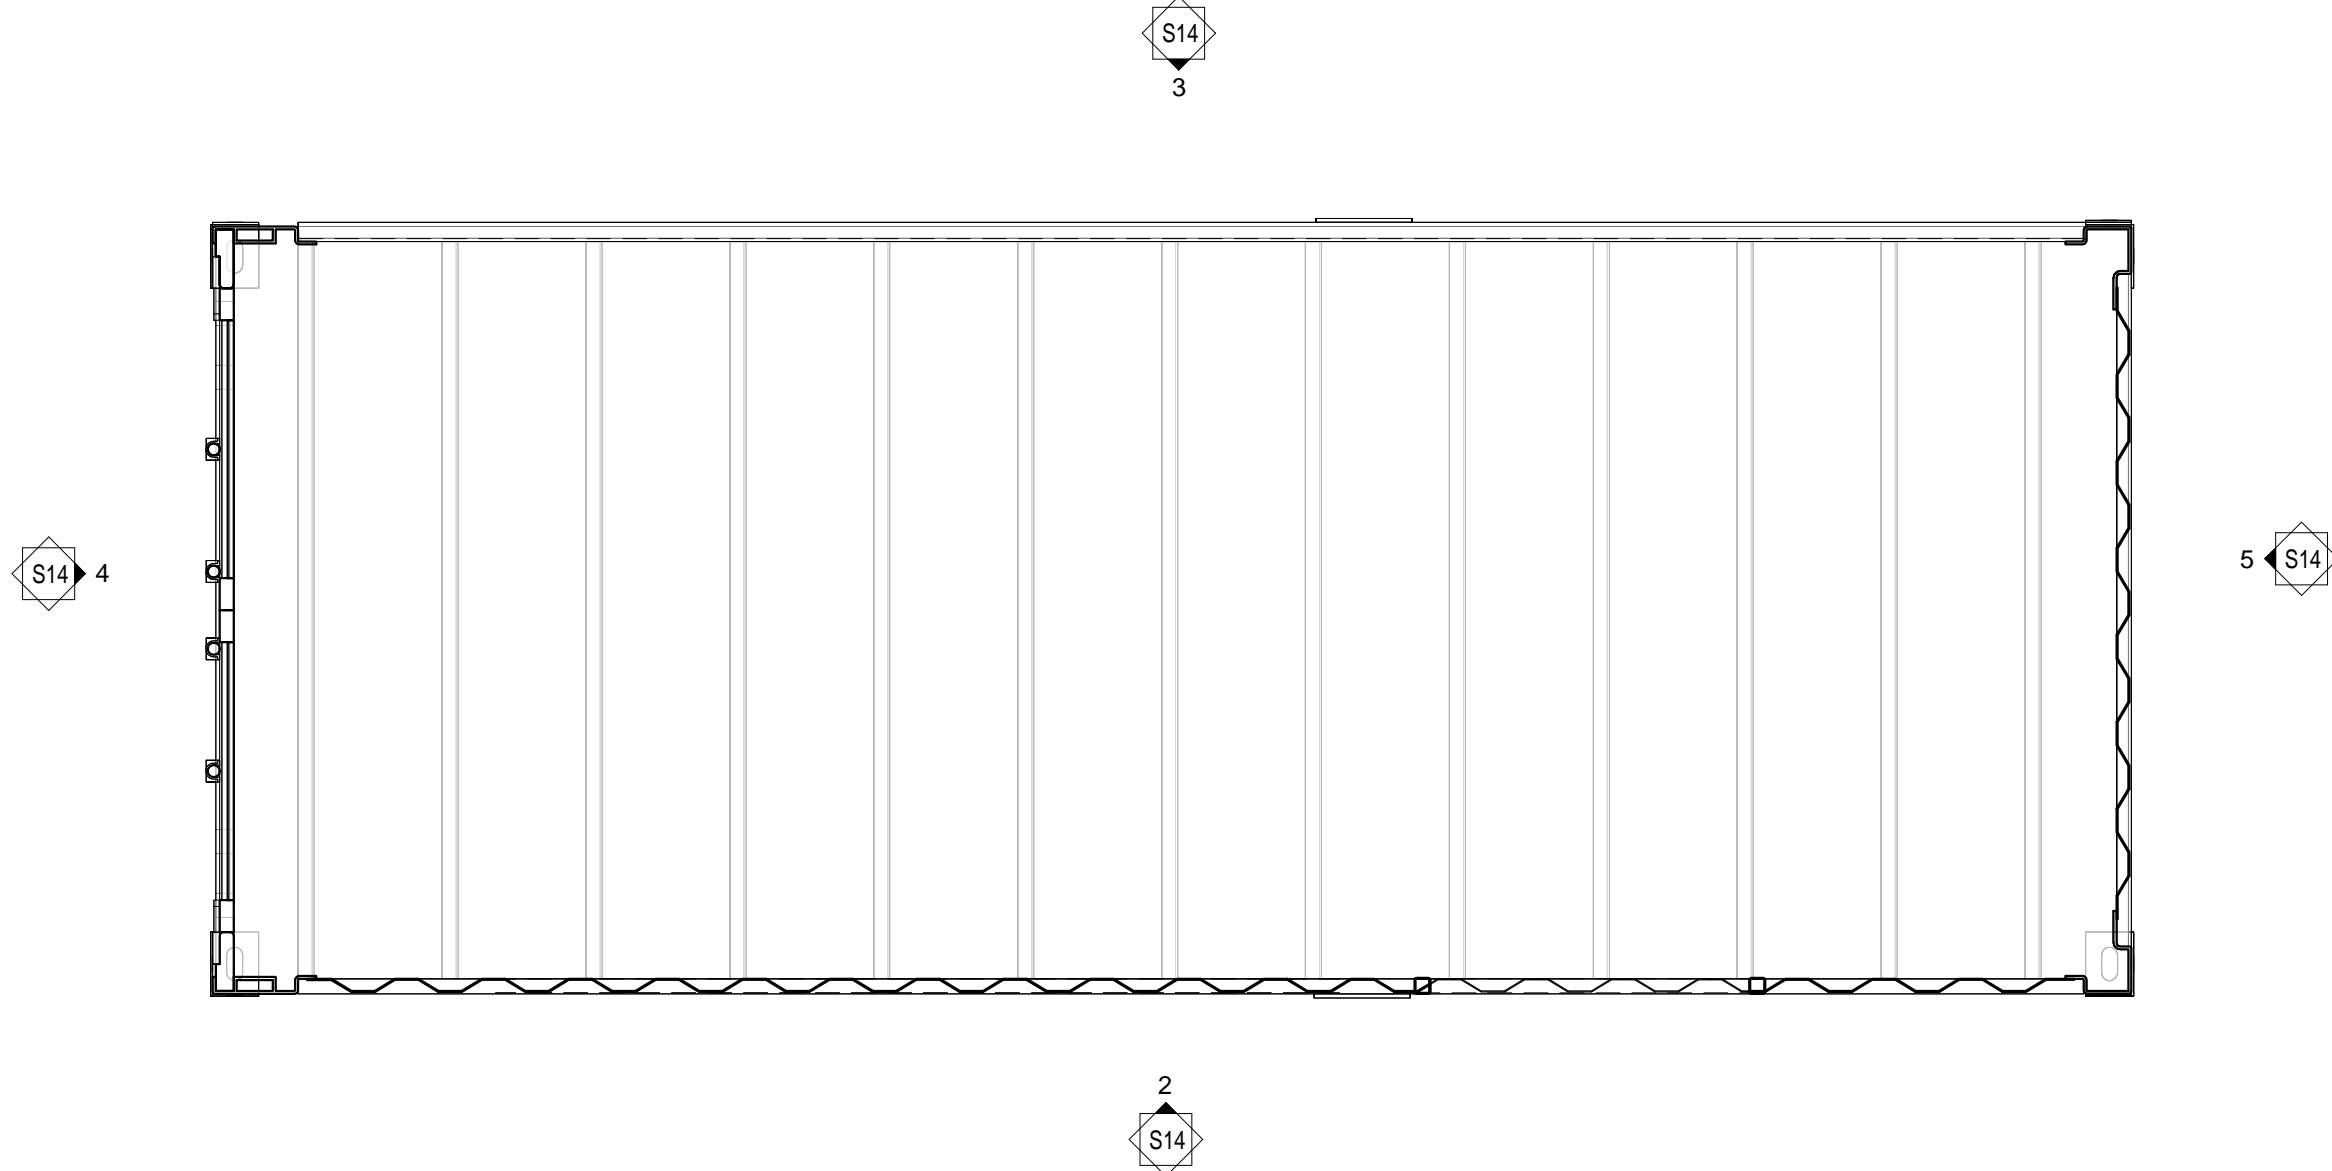

6 TOP VIEW FOOT FRONT 20 FOOT CONTAINER

1/2" = 1'-0"





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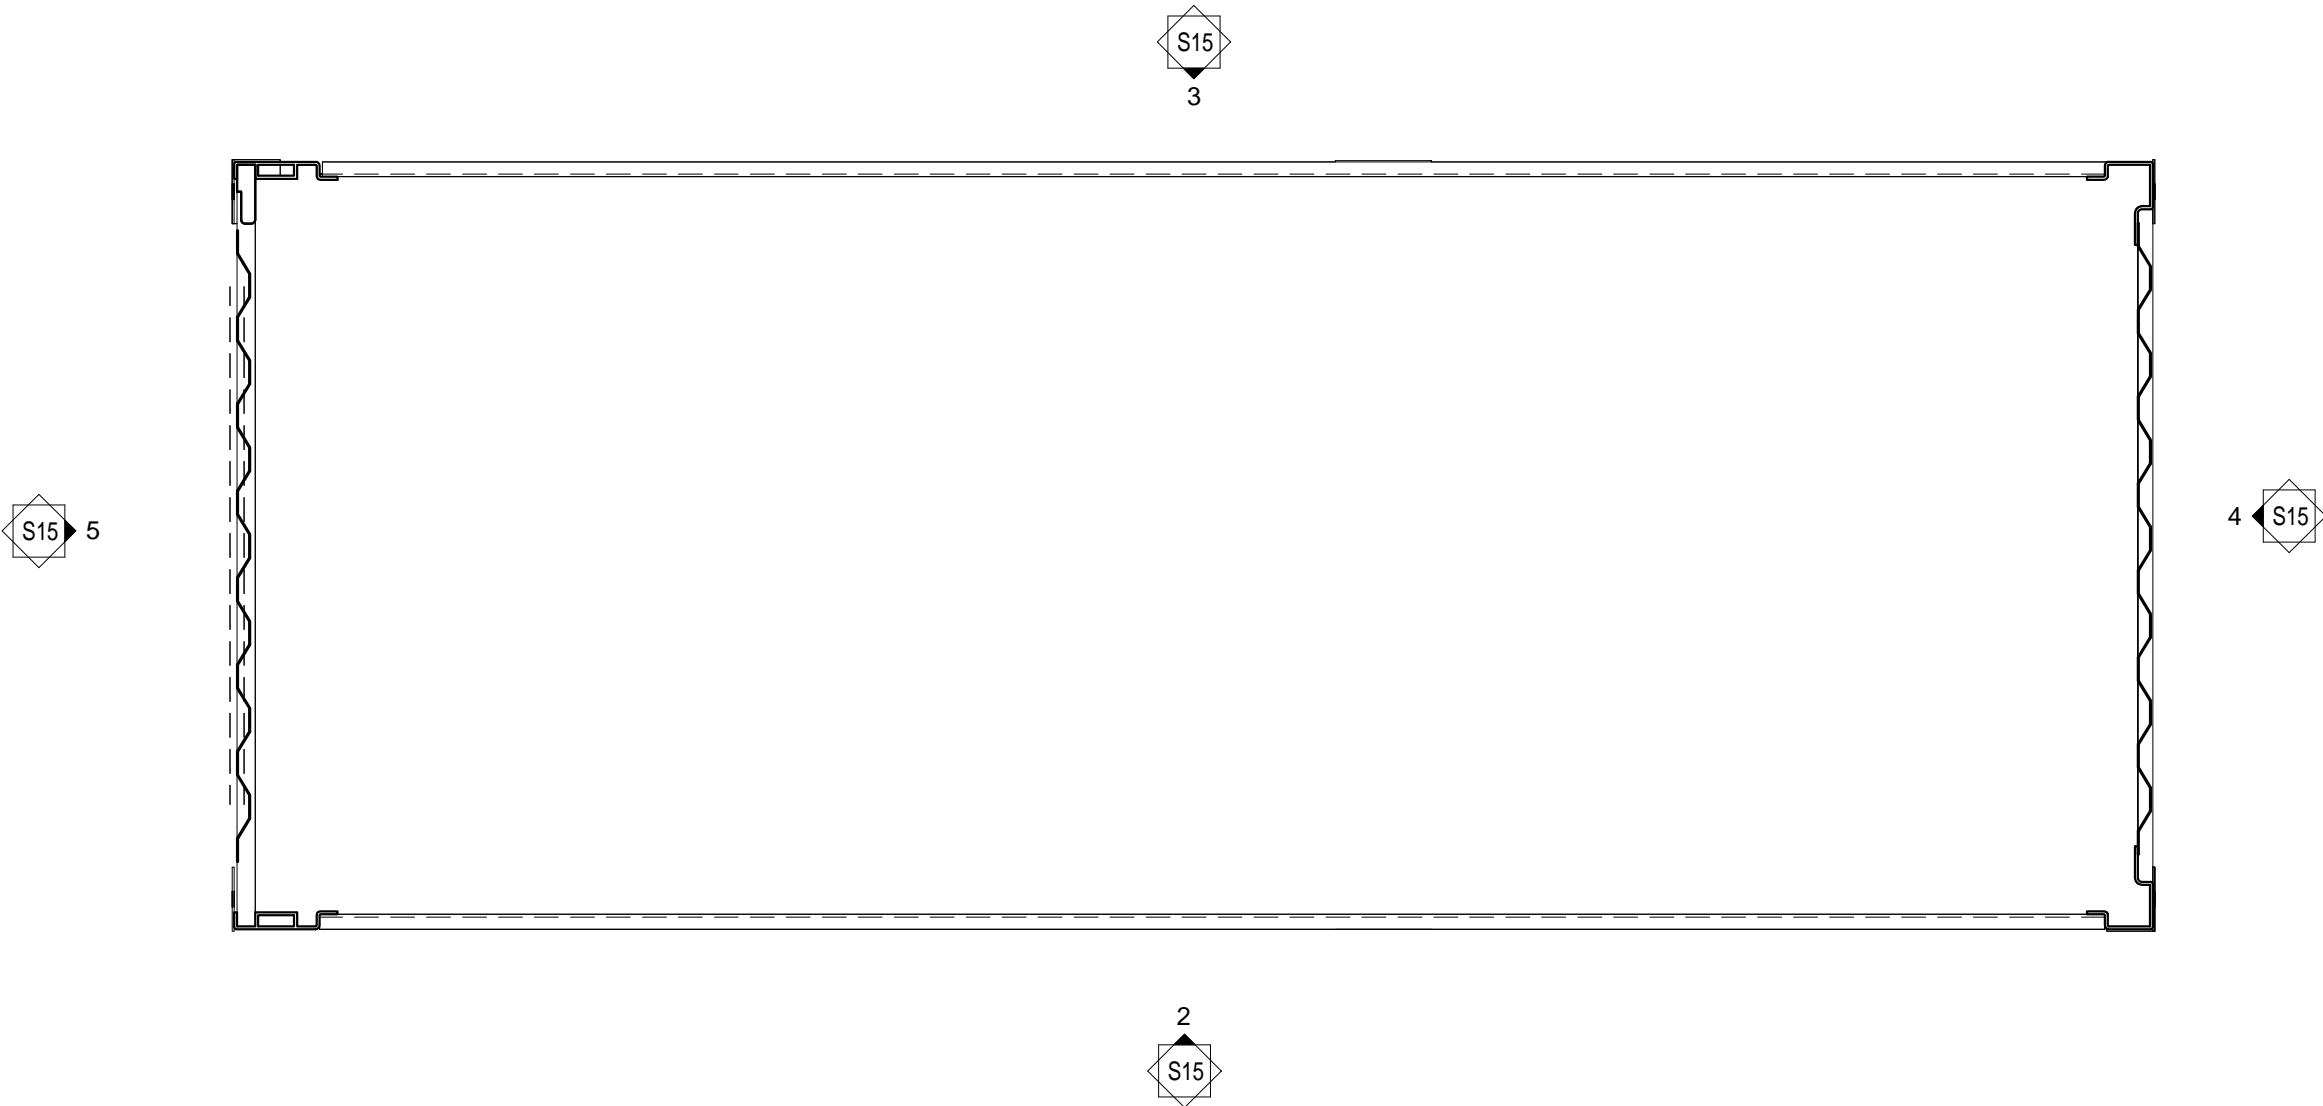
PROJECT 19176	DATE 5-29-2020
DRAWN gwr	CHECKED Checker

REVISED


MIDDLE 20  
FOOT  
CONTAINER

SHEET


S15  
ORIGINAL SHEET SIZE  
24" x 36"




1 MIDDLE 20 FOOT CONTAINER FLOOR PLAN  
1/2" = 1'-0"

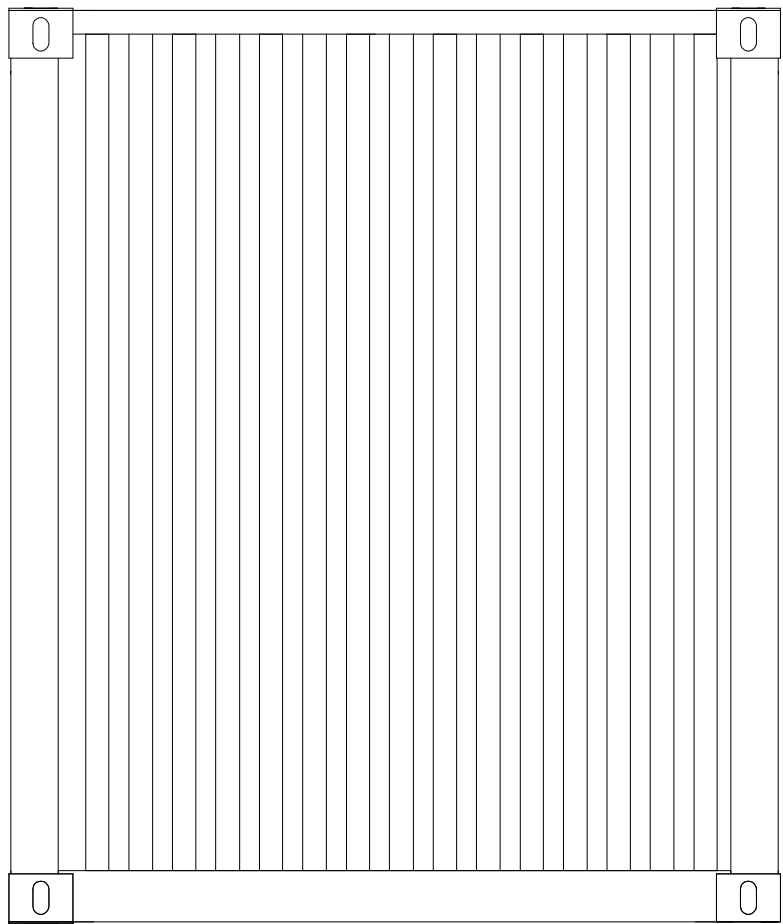


4 RIGHT ELEVATION MIDDLE 20 FOOT CONTAINER  
1/2" = 1'-0"

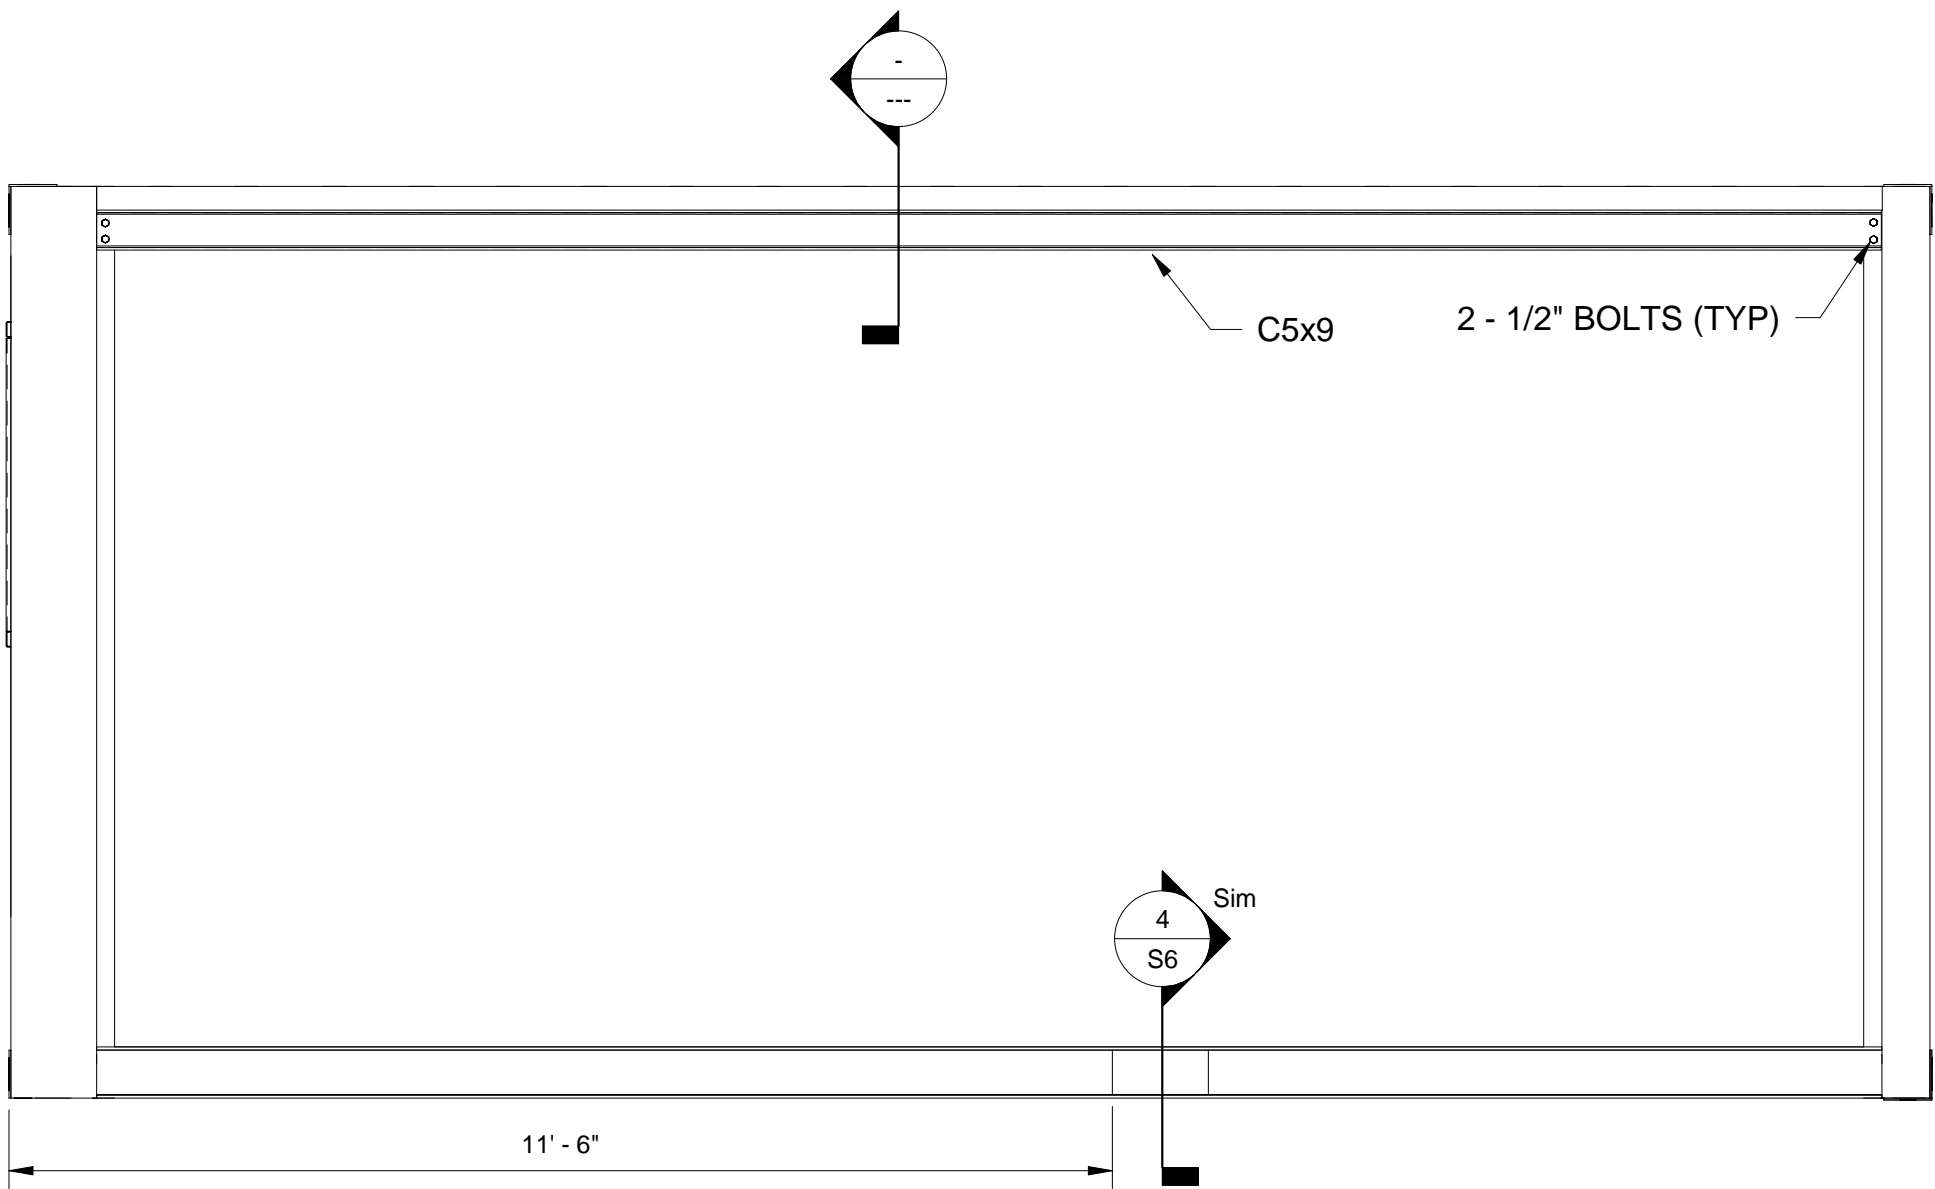


2 FRONT ELEVATION MIDDLE 20 FOOT CONTAINER  
1/2" = 1'-0"

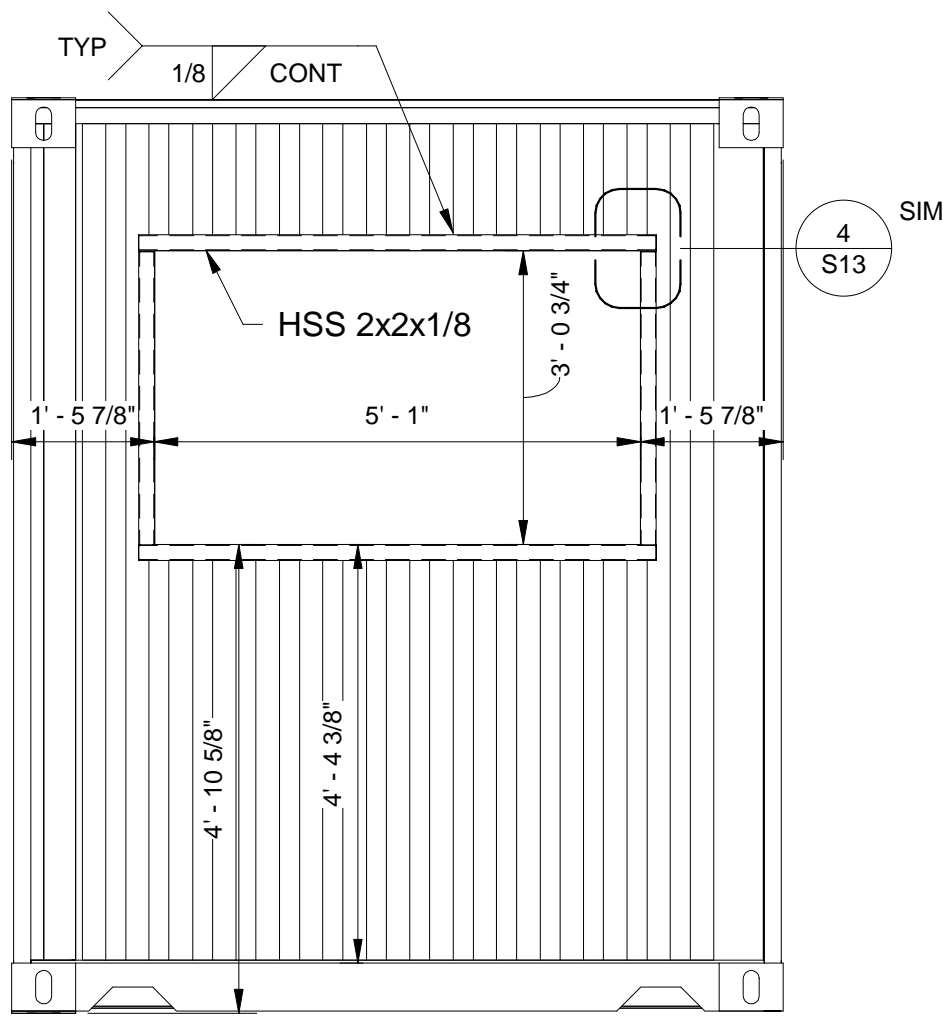

5 LEFT ELEVATION MIDDLE 20 FOOT CONTAINER  
1/2" = 1'-0"

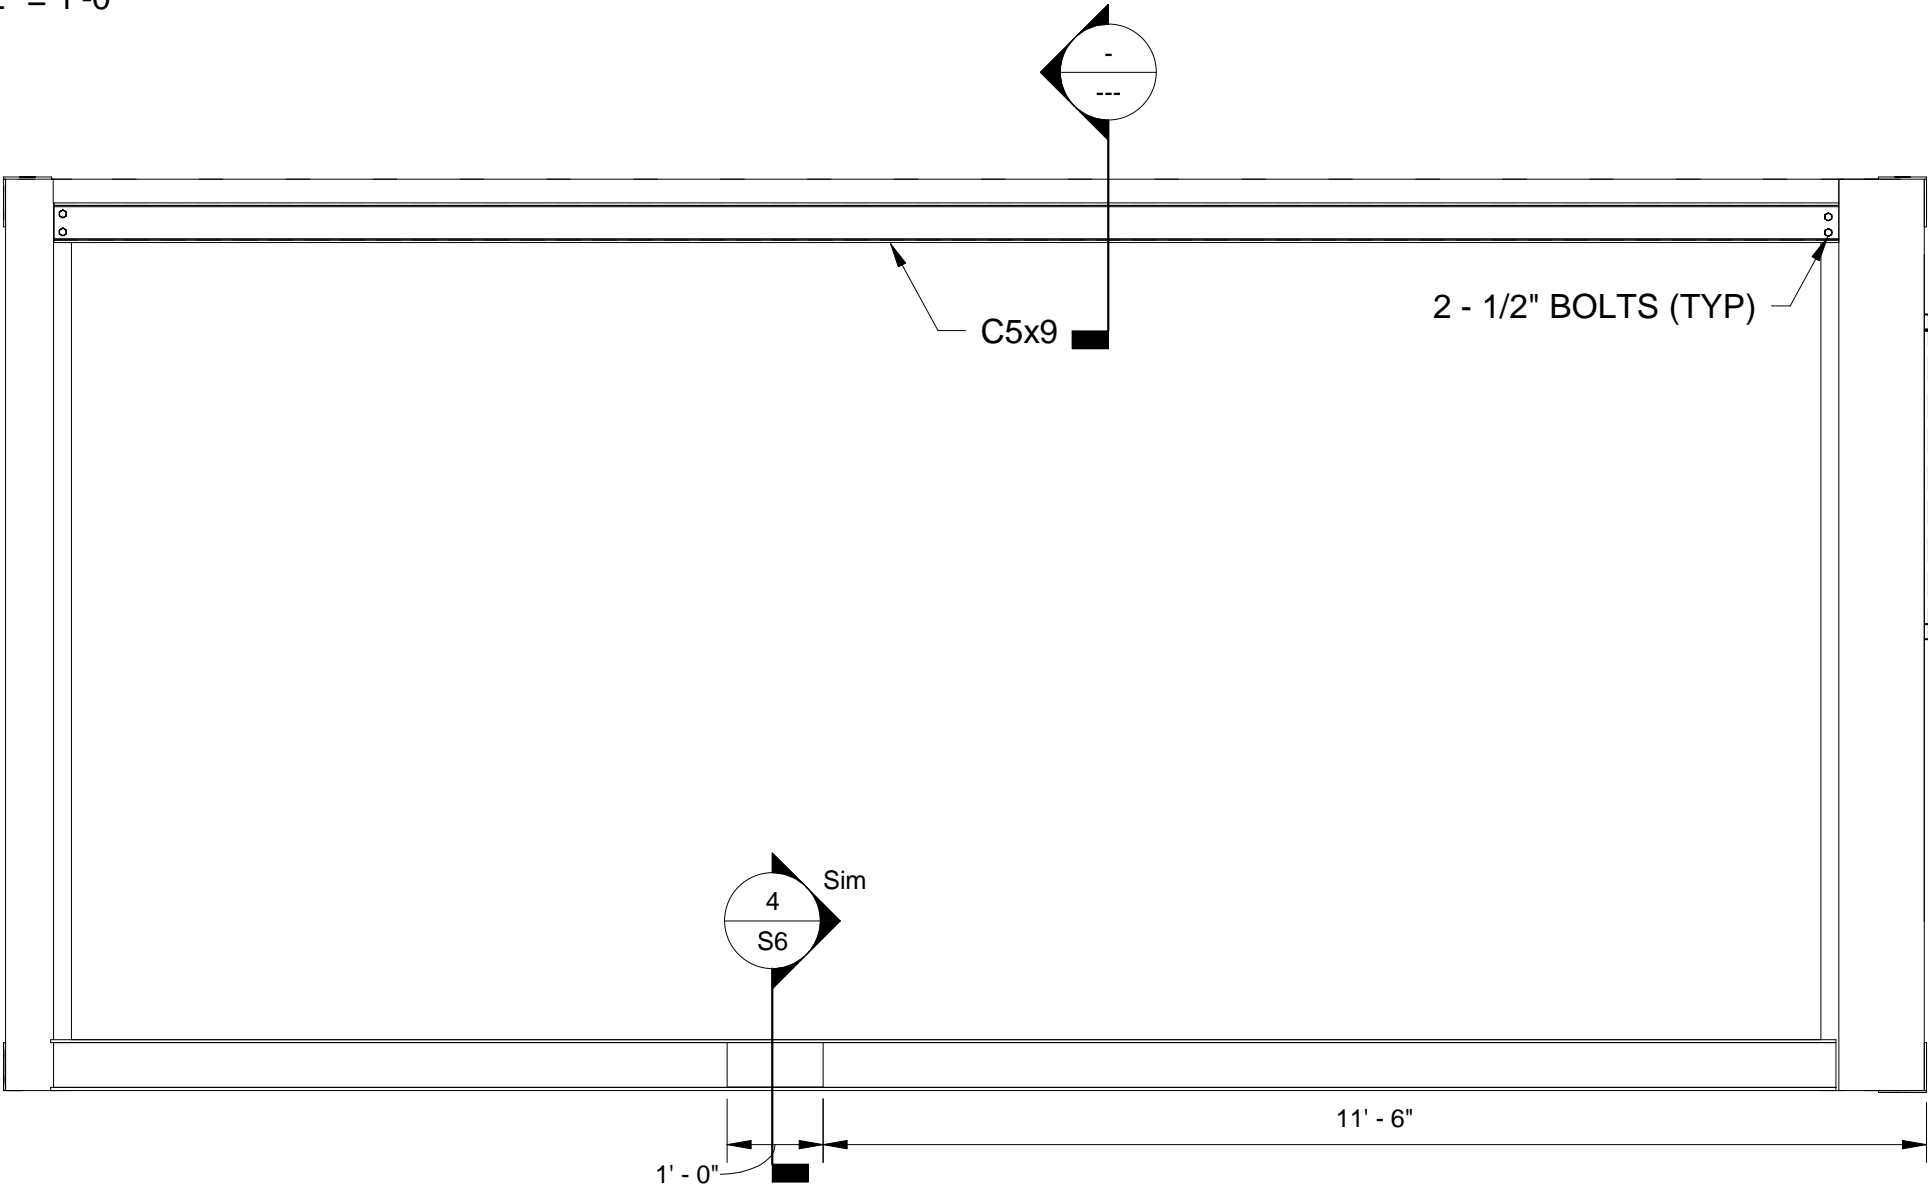

3 REAR ELEVATION MIDDLE 20 FOOT CONTAINER  
1/2" = 1'-0"

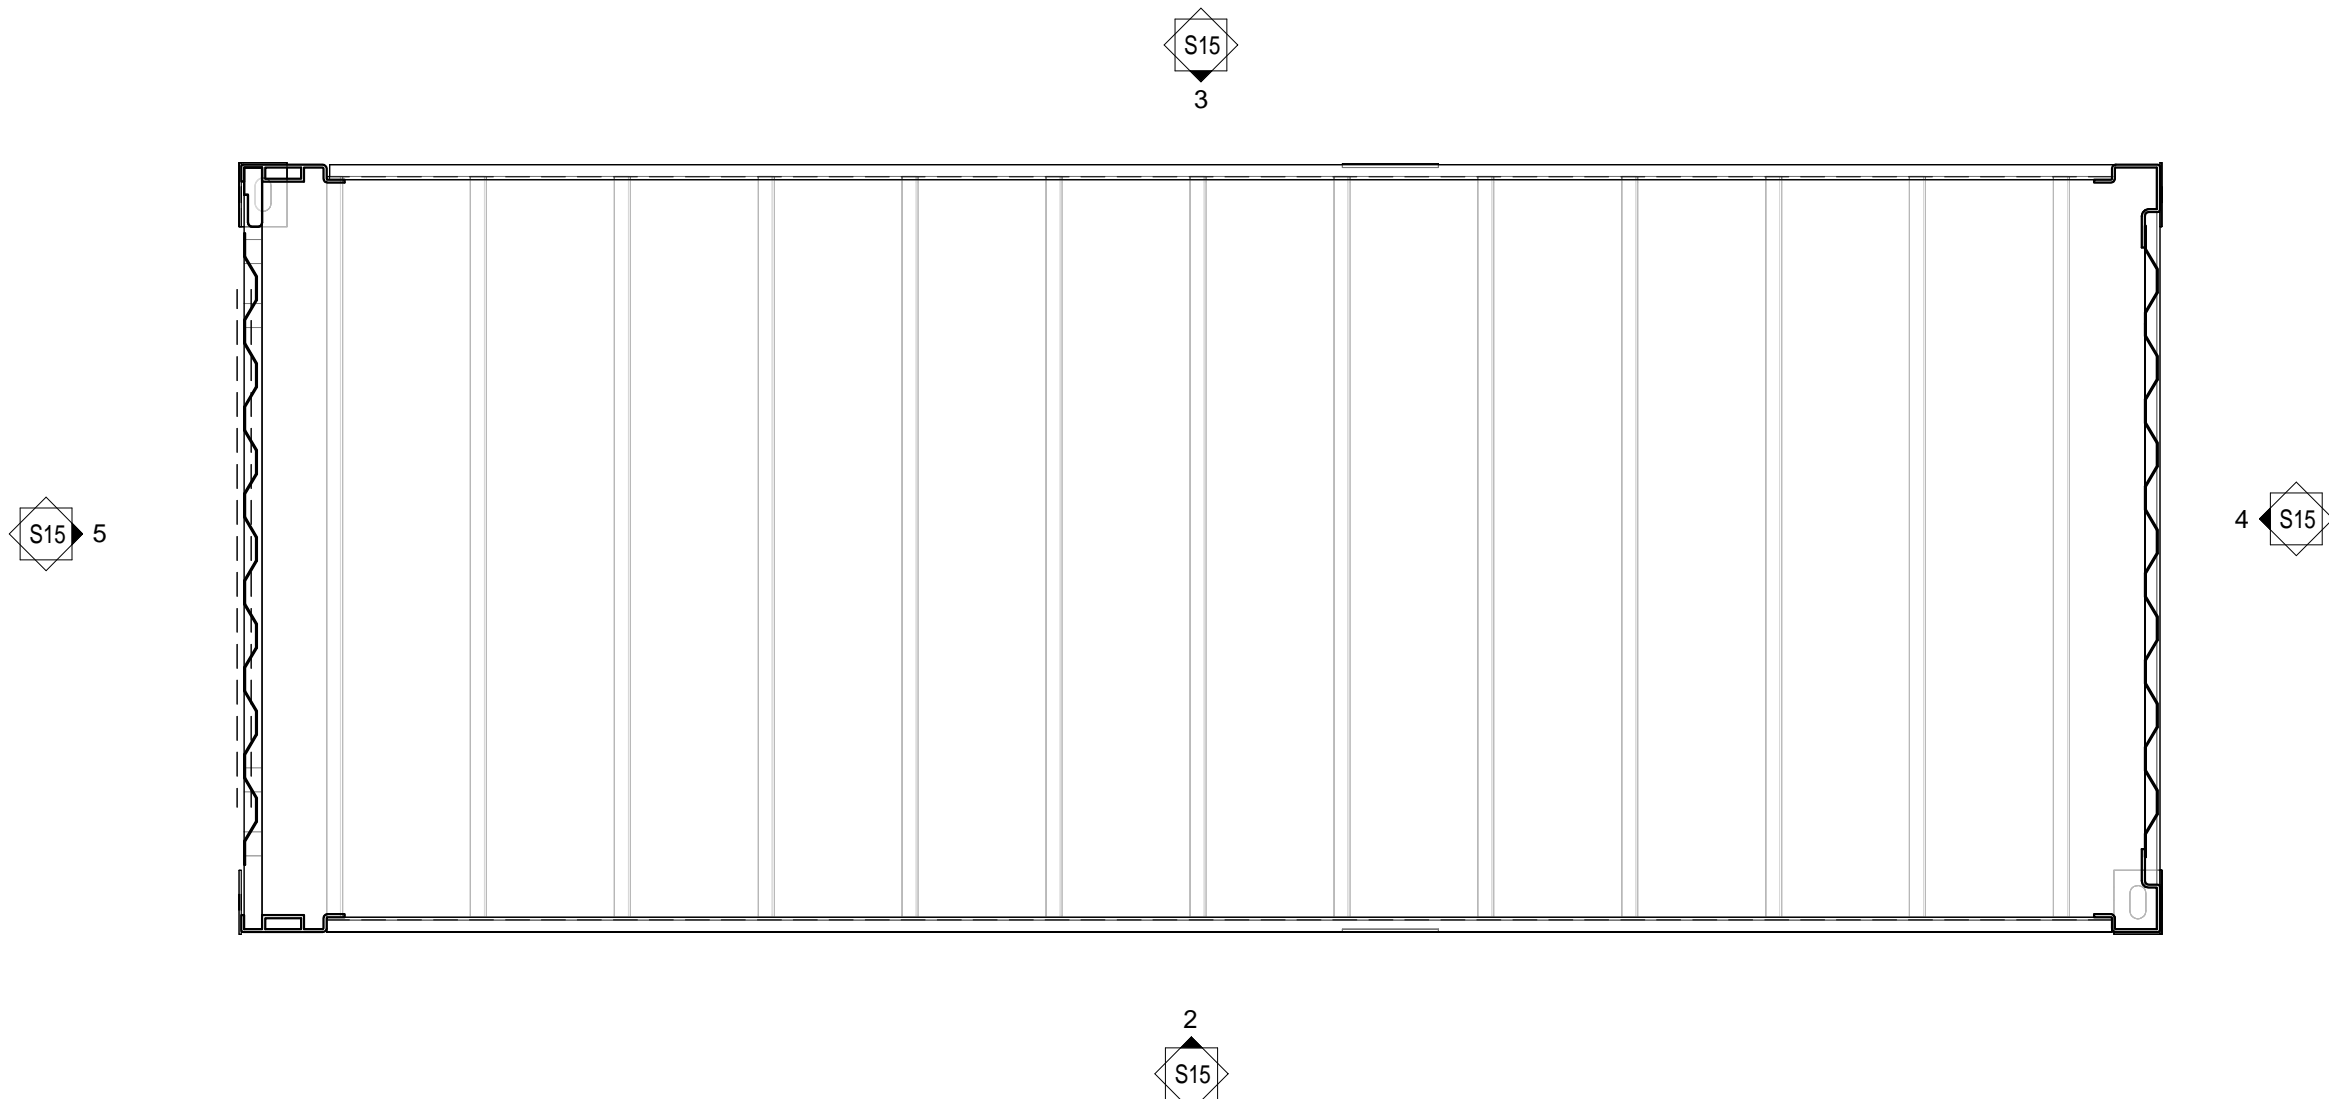

6 TOP VIEW MIDDLE 20 FOOT CONTAINER  
1/2" = 1'-0"





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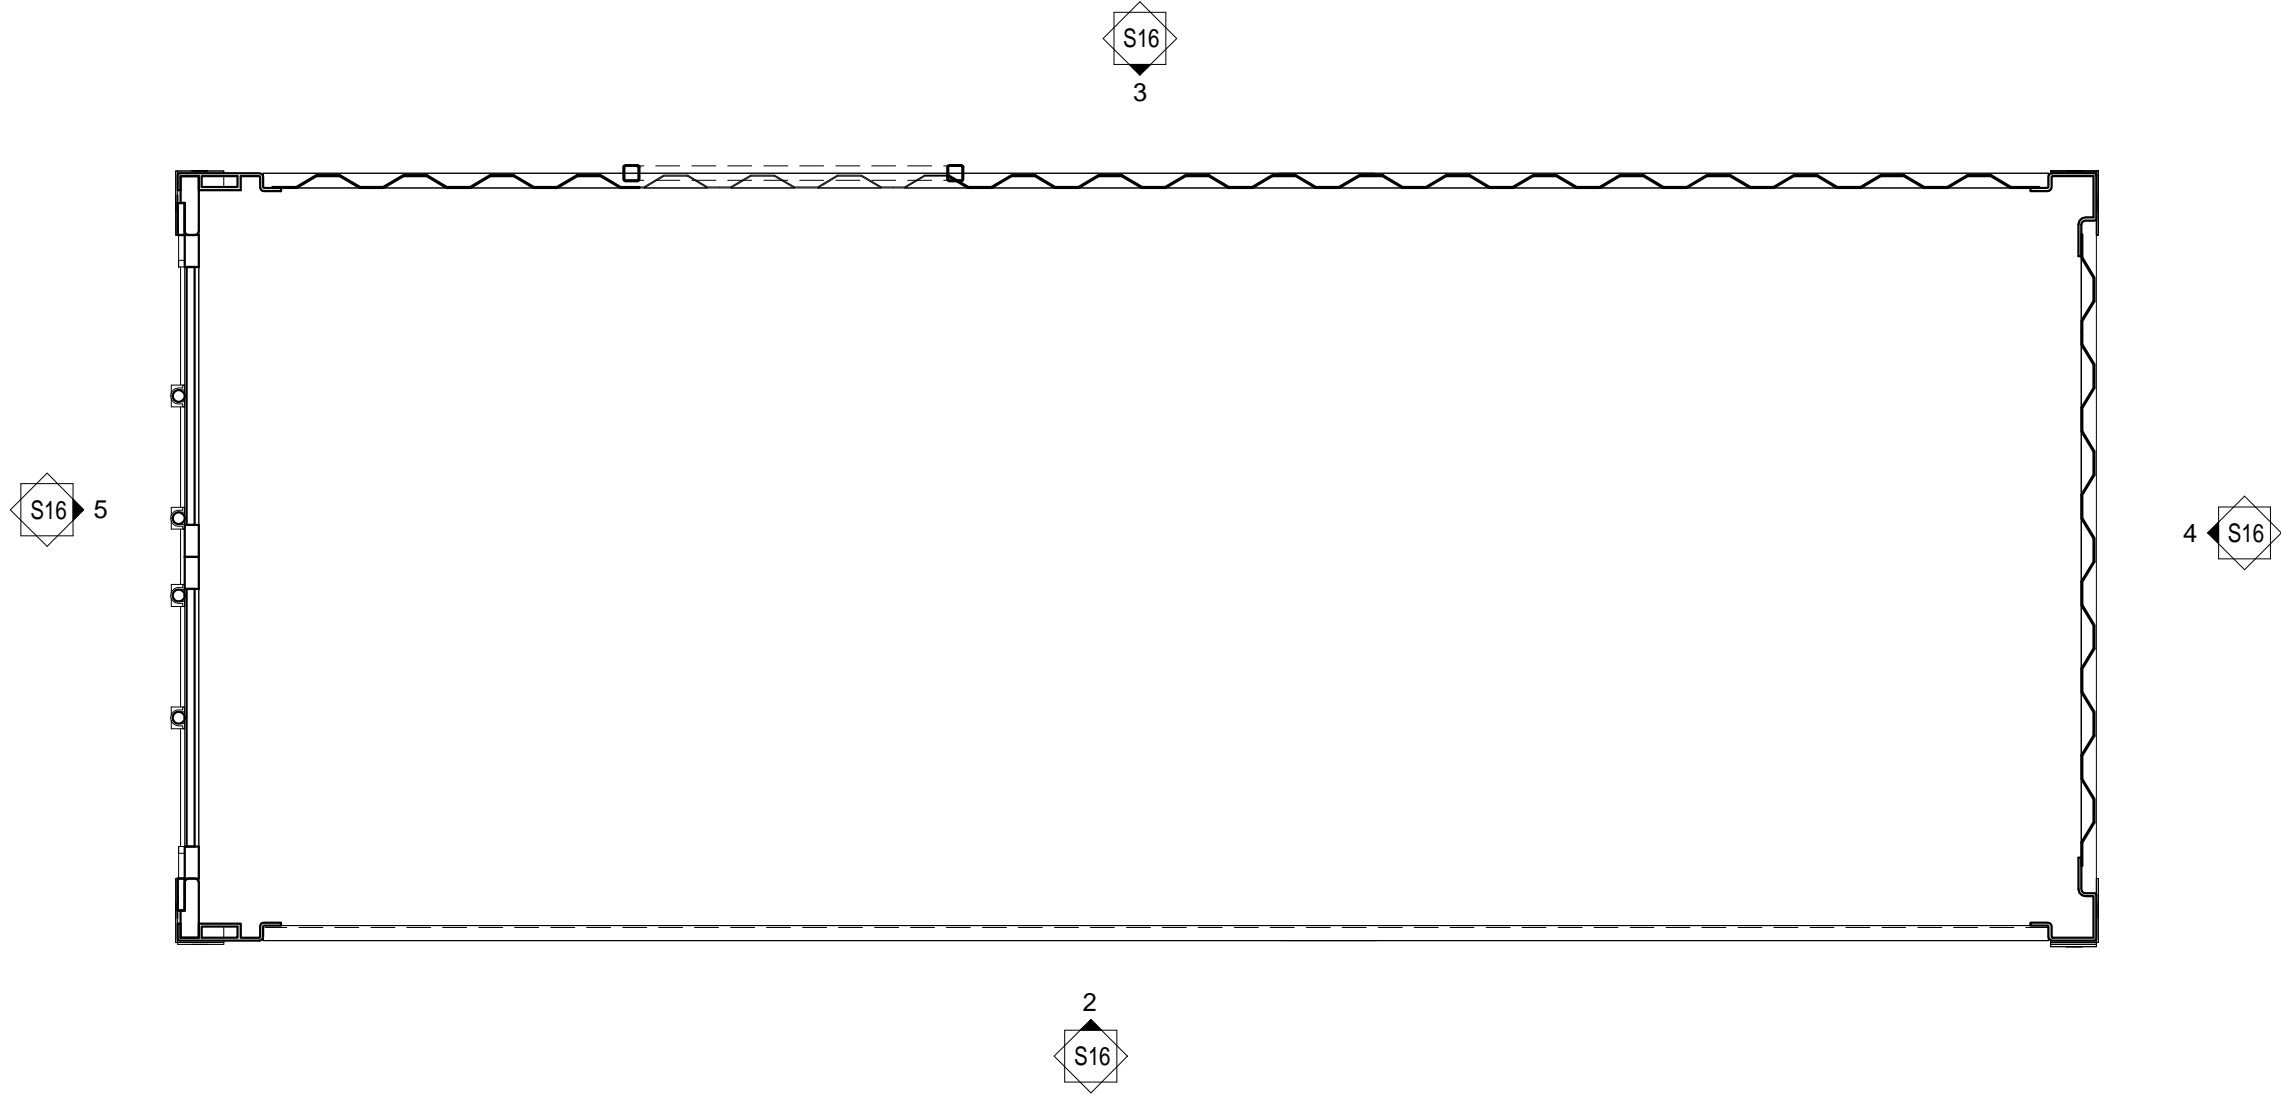
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PROJECT 19176	DATE 5-29-2020
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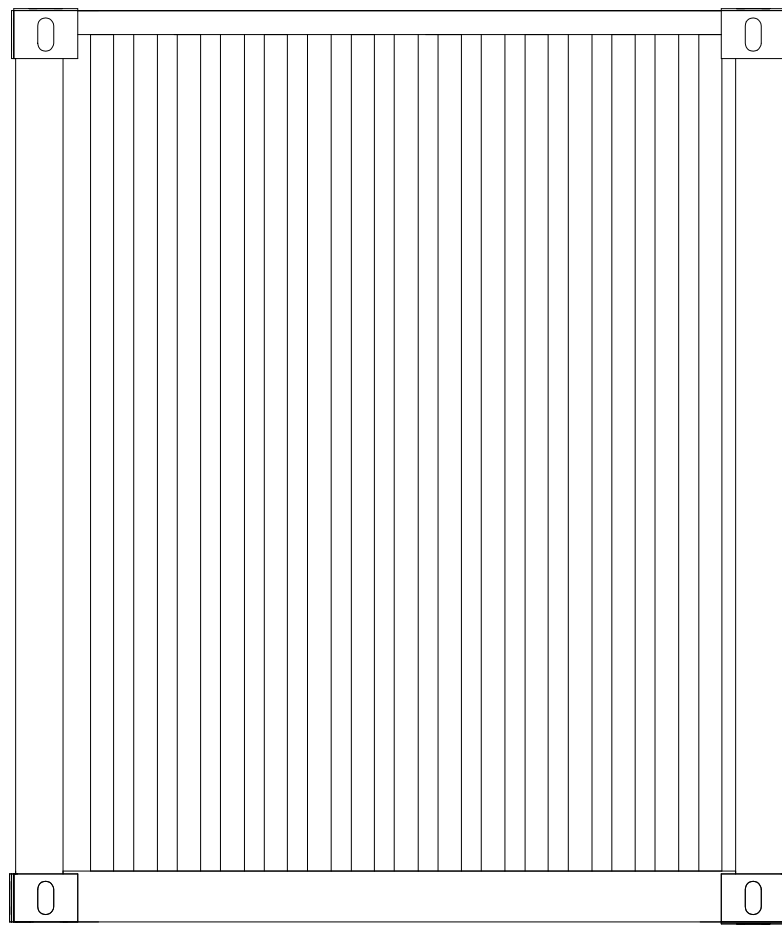
REVISED

SHE  
ALLEY 20  
FOOT  
CONTAINER


SHEET  
S16  
ORIGINAL SHEET SIZE  
24" x 36"




1 ALLEY 20 FOOT CONTAINER FLOOR PLAN  
1/2" = 1'-0"




4 RIGHT ELEVATION ALLEY 20 FOOT CONTAINER  
1/2" = 1'-0"

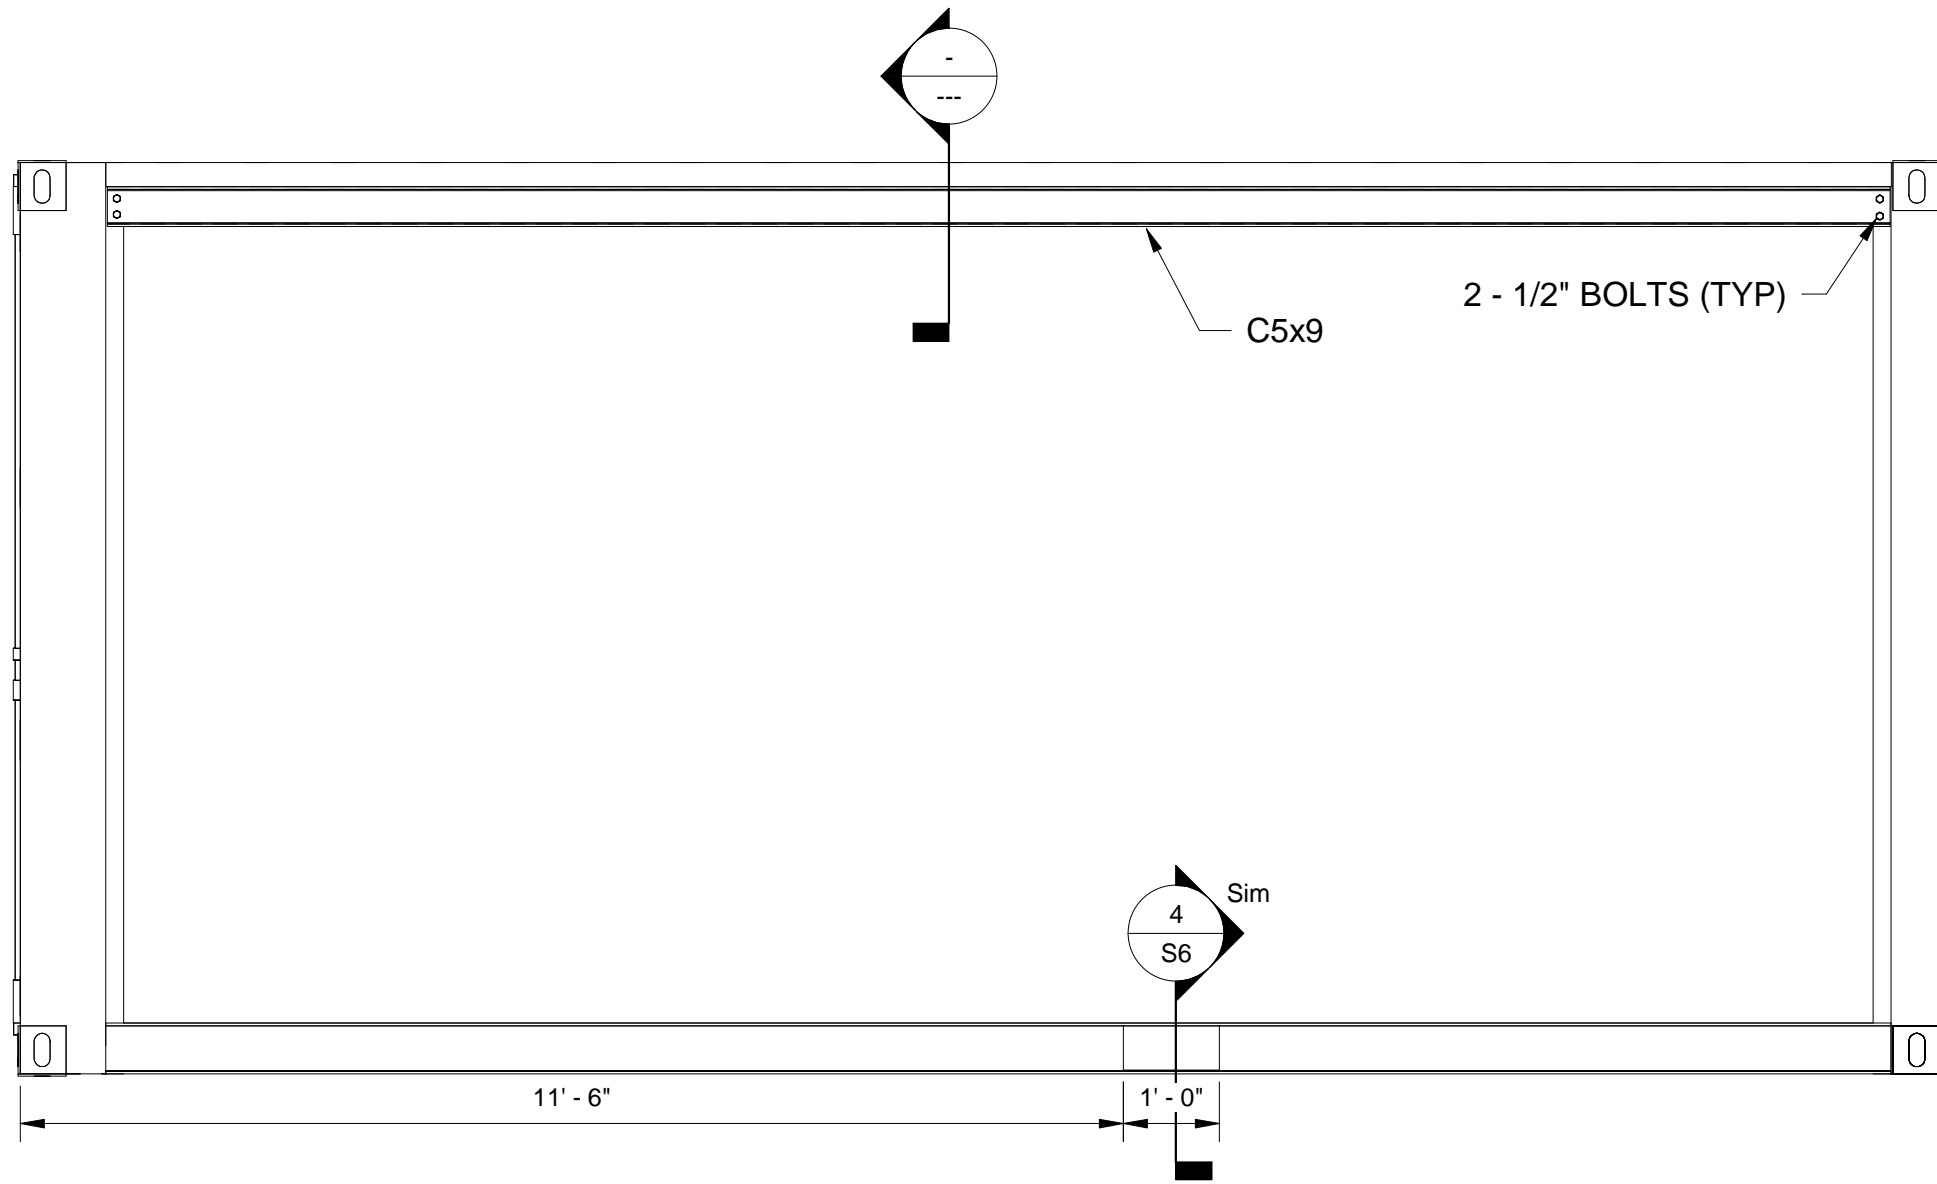


2 FRONT ELEVATION ALLEY 20 FOOT CONTAINER  
1/2" = 1'-0"

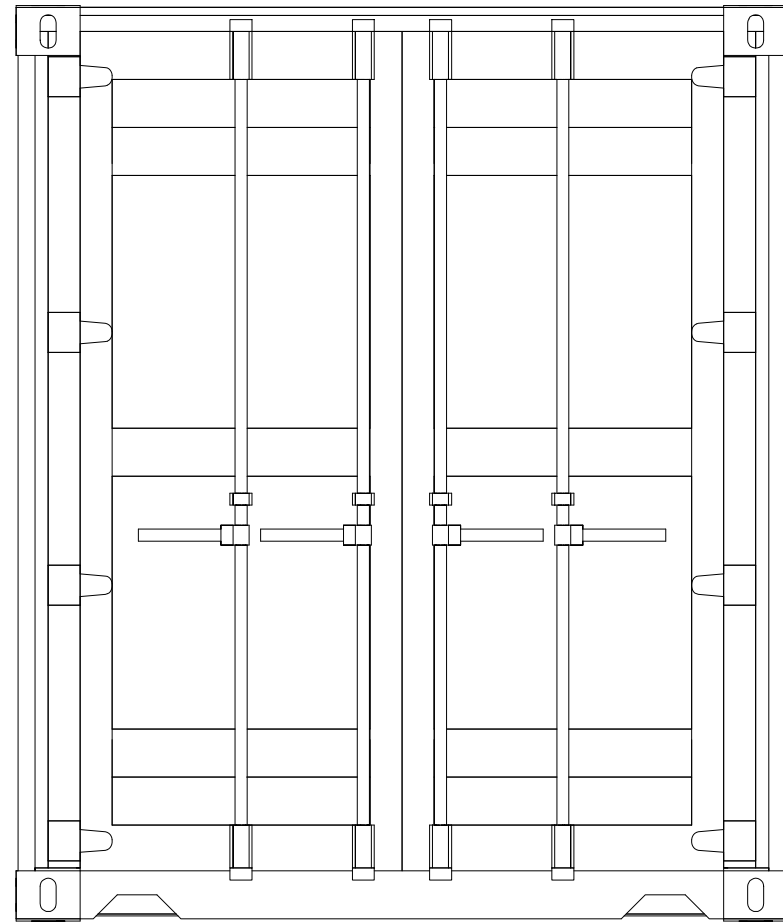

5 LEFT ELEVATION ALLEY 20 FOOT CONTAINER  
1/2" = 1'-0"

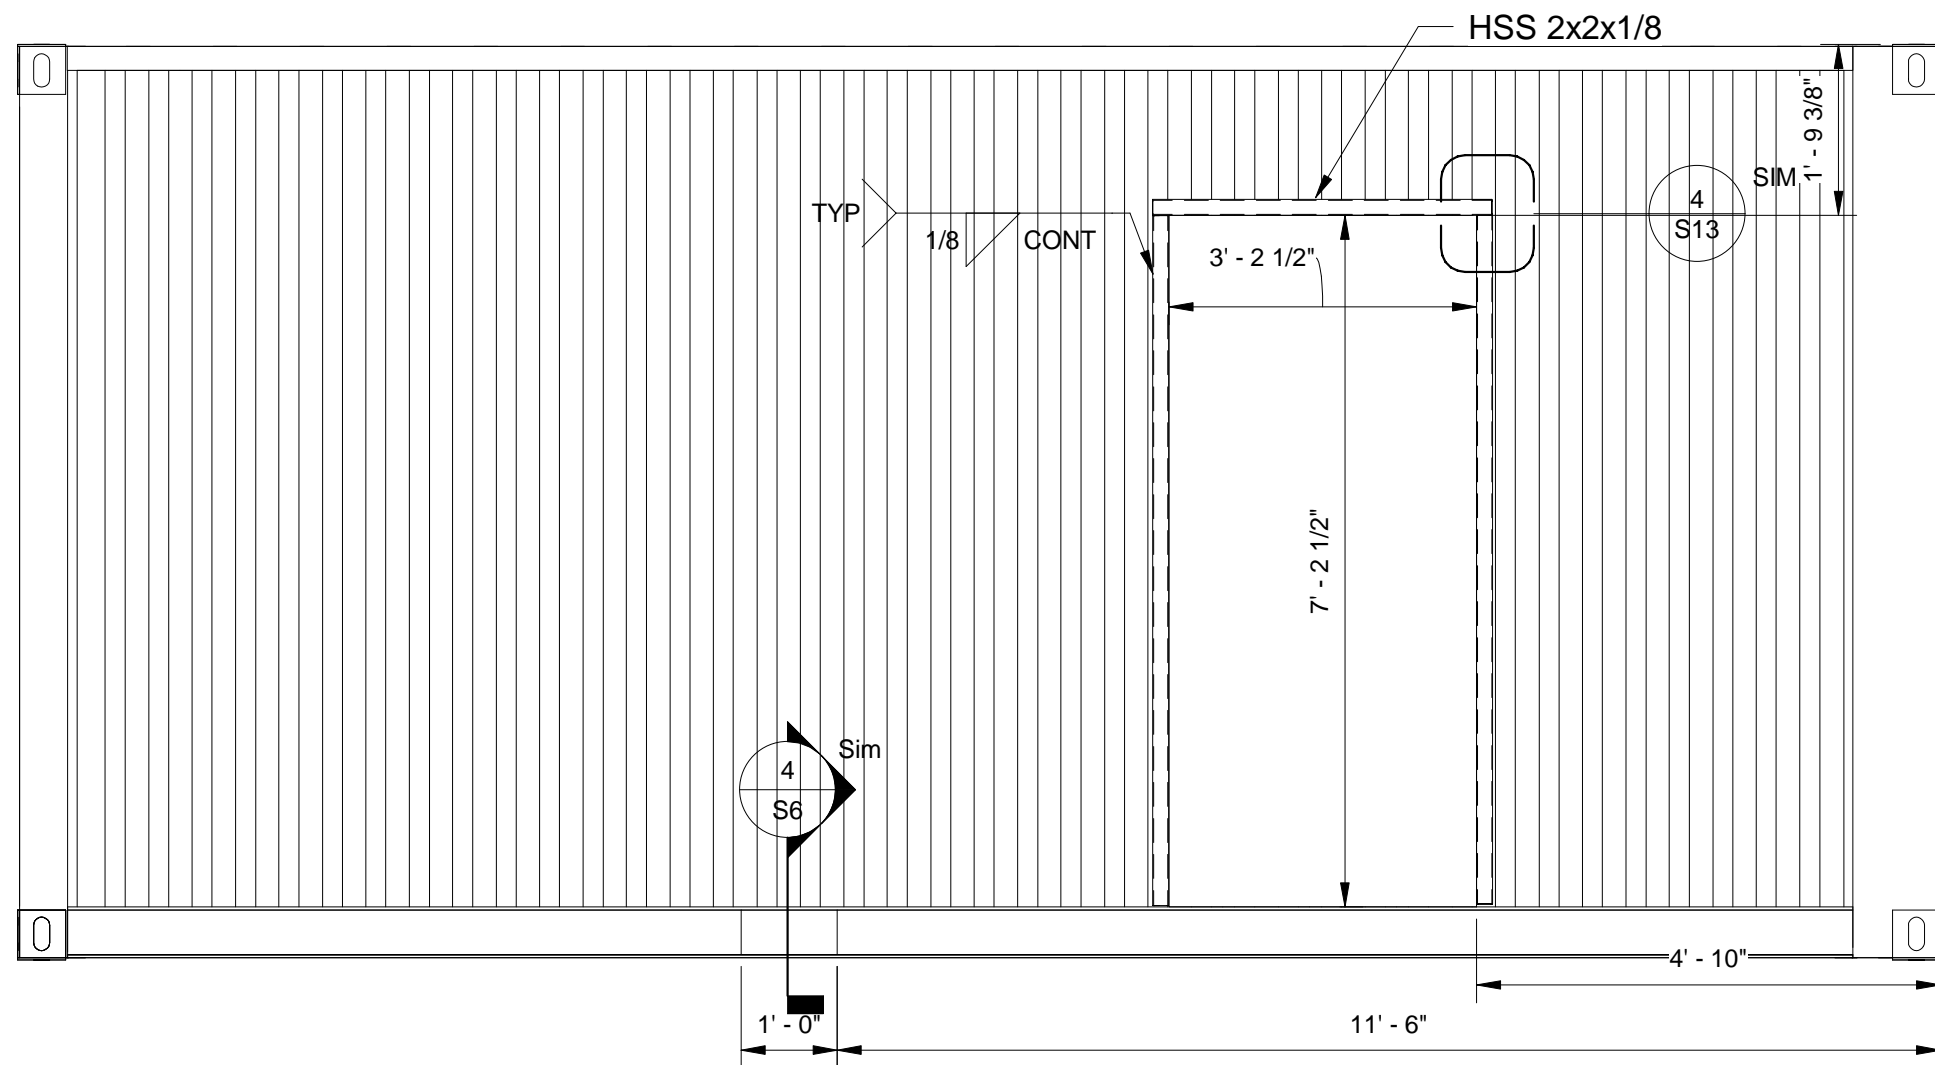

3 REAR ELEVATION ALLEY 20 FOOT CONTAINER  
1/2" = 1'-0"

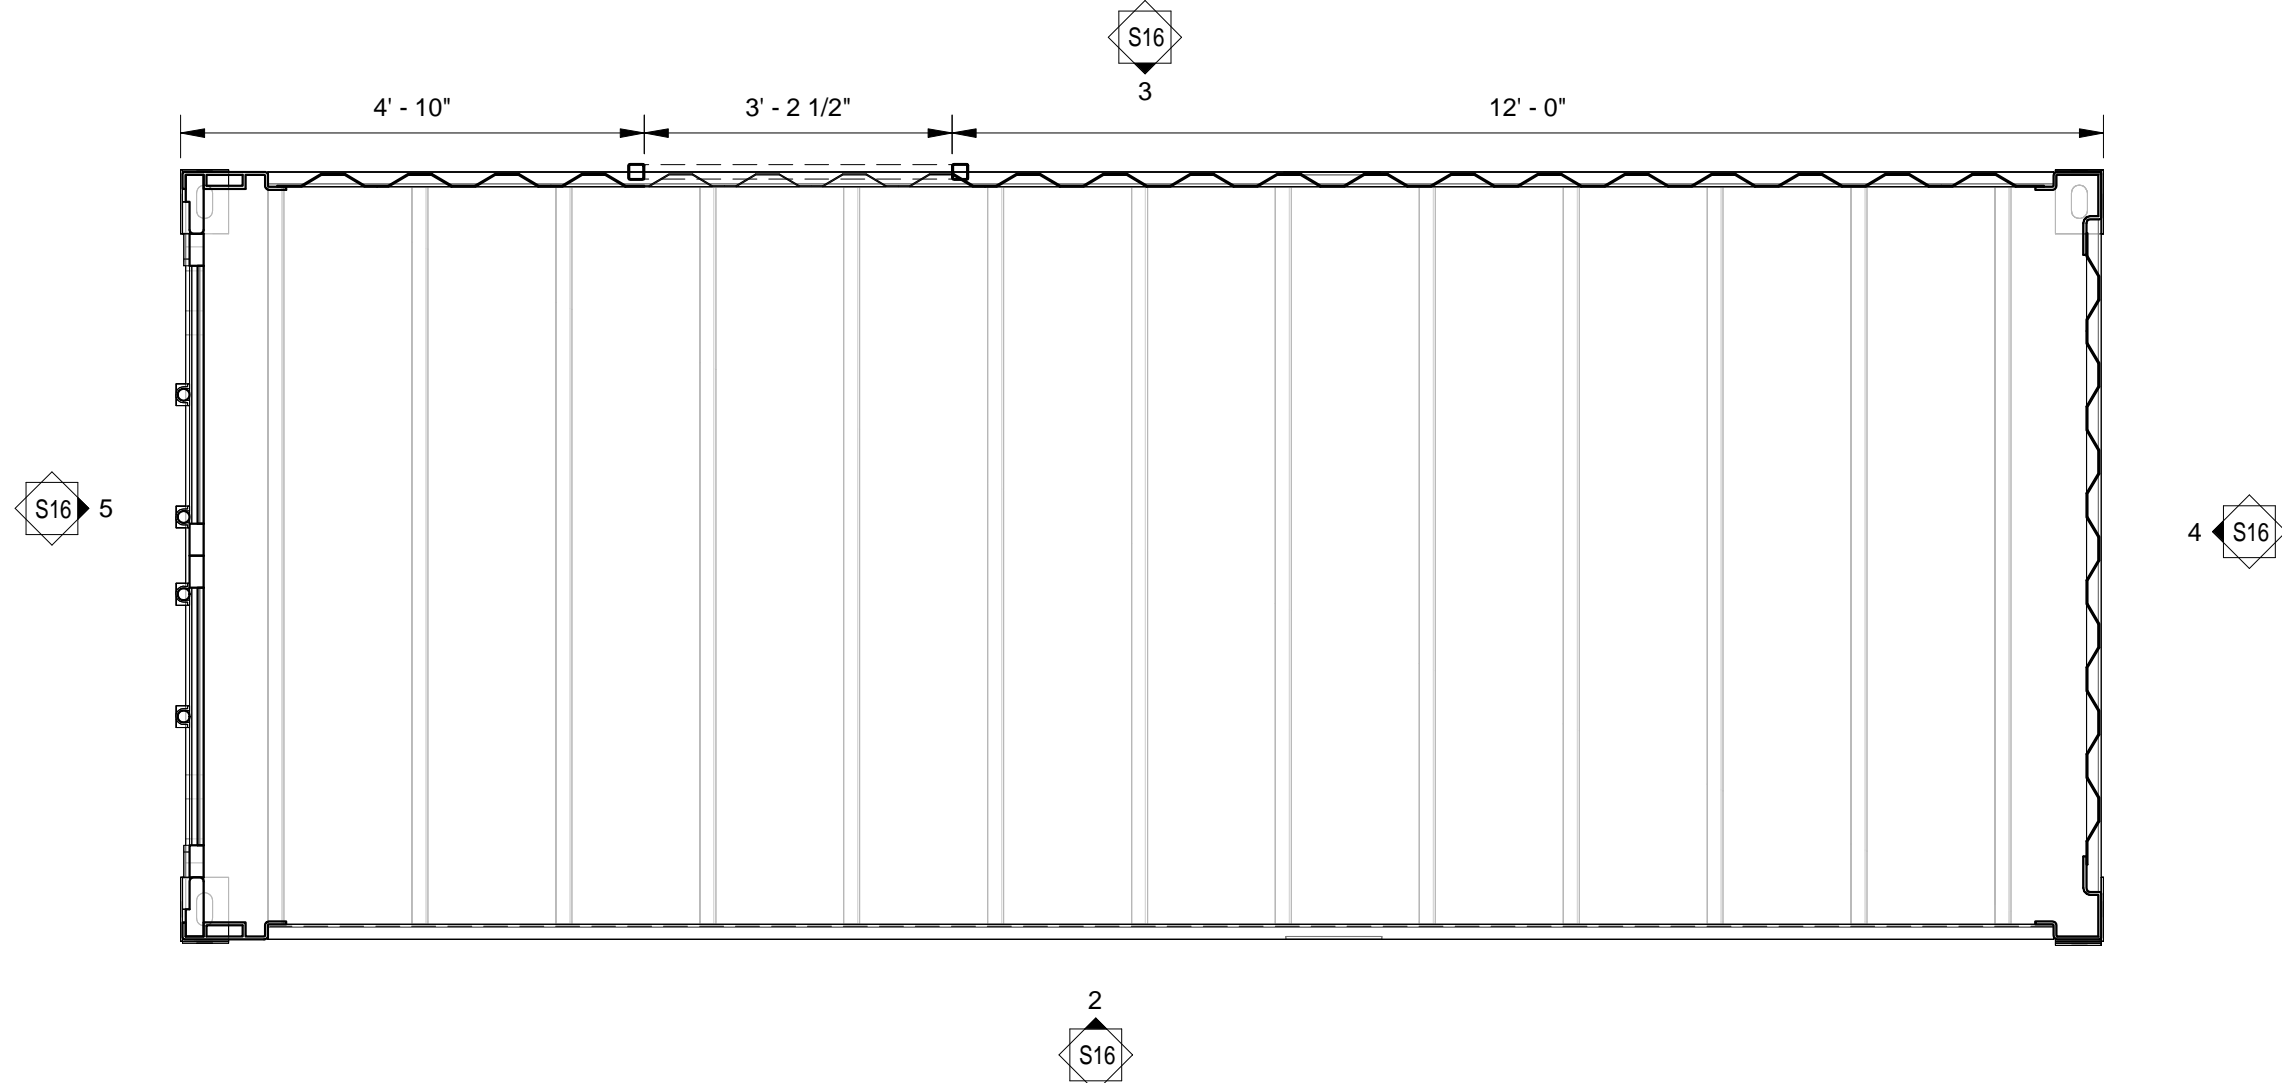


6 TOP VIEW ALLEY 20 FOOT CONTAINER  
1/2" = 1'-0"



# 1 WALL TYPES

1"= 1'-0"


W01

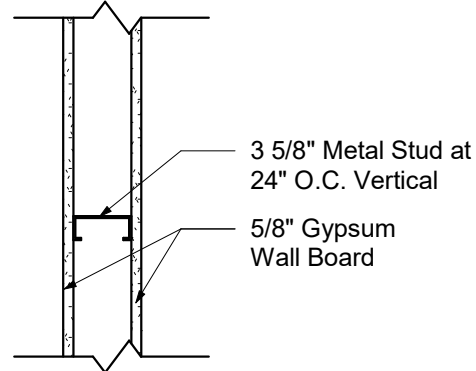

PLAN

NOTES:  
1. COMMON PARTITION


W02

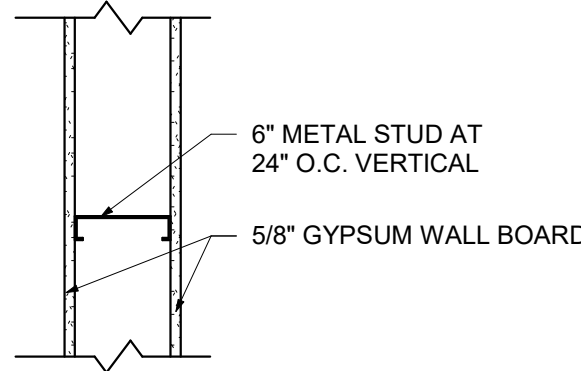

PLAN

NOTES:  
1. PLUMBING WALL


W03

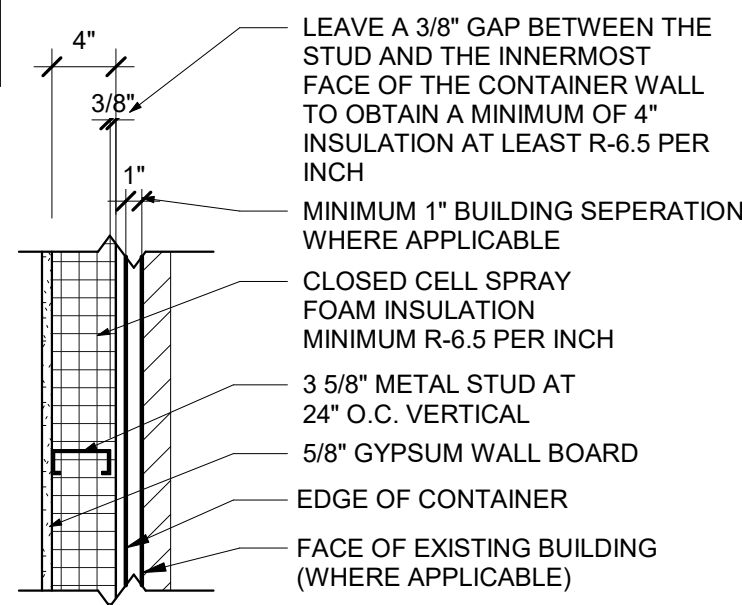

PLAN


NOTES:  
1. INTERIOR FURRING WALL.

W04

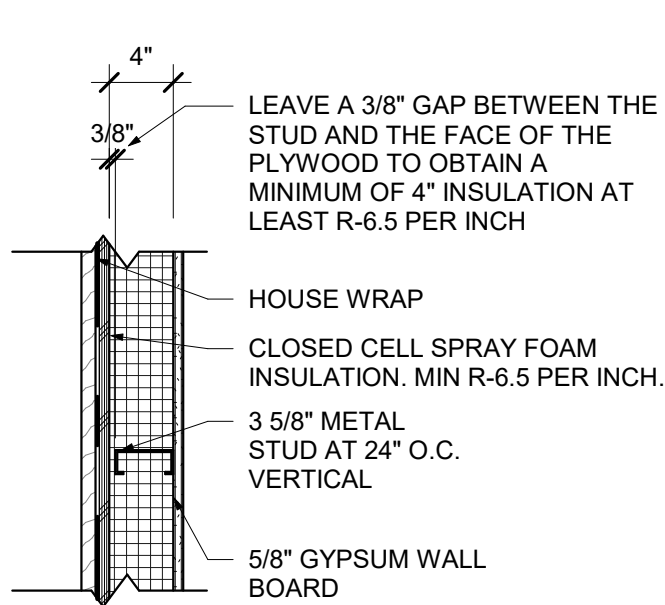

PLAN

NOTES:  
1. WOOD WALL AT COUNTER

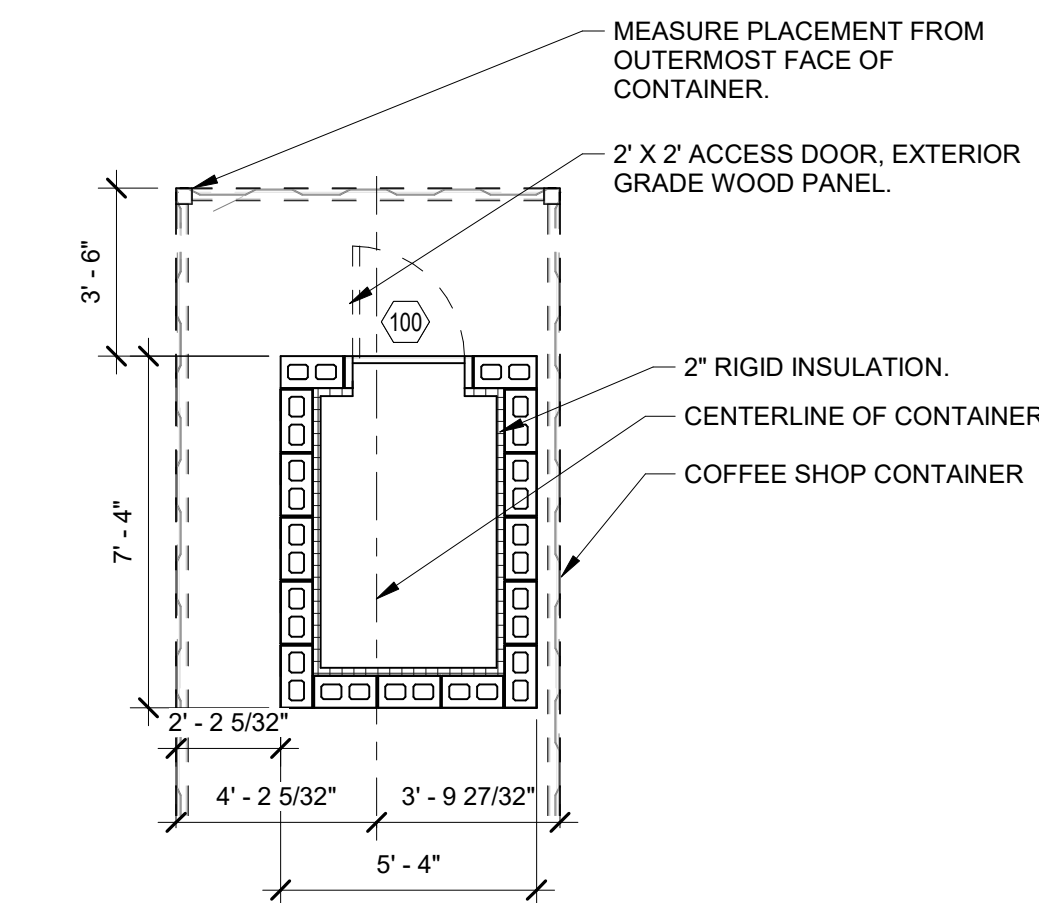

## 3 PLUMBING CHASE PLAN

1/4" = 1'-0"


### LEGEND:

### GENERAL NOTES:

- FINISH FLOOR ELEVATION (100.00) IS FOR REFERENCE ONLY. SEE SEPARATE BOUND CIVIL SET FOR ACTUAL FLOOR ELEVATION.
- ALL WALL DIMENSIONS ARE TO FACE OF STUD AND/OR NOMINAL FACE OF MASONRY.
- PROVIDE BLOCKING WHERE REQUIRED FOR FIXTURE INSTALLATION. COORDINATE WITH FIXTURE INSTALLER FOR MOUNTING HEIGHTS.
- BRACE WALLS THAT DO NOT EXTEND TO STRUCTURE WITH 3 5/8" METAL STUD DIAGONAL BRACE AT 48" O.C., ANCHOR TO BOTTOM FLUTE OF ROOF DECKING AND AT TOP TRACK OF PARTITION WALL. BRACES TO BE CONCEALED WHENEVER POSSIBLE.
- PROVIDE 5/8" GYP. BD. AT EXISTING EXTERIOR STUD FRAMED WALLS. FINISH.
- THE HINGE SIDE OF ALL DOOR FRAMES SHALL BE MOUNTED 4" FROM ADJACENT PERPENDICULAR WALL UNLESS NOTED OTHERWISE.
- RE: I-SERIES FOR FURNITURE PLANS.
- CONTRACTOR SHALL PROVIDE BLOCKING OR BACKING FOR ALL WALL MOUNTED AND RECESSED ACCESSORIES AND EQUIPMENT. ASSURE THAT ALL REQUIRED BACKING IS INSTALLED IN WALLS PRIOR TO INSTALLING DRYWALL. THIS INCLUDES BACKING FOR WALL-MOUNTED DOORSTOPS.
- THE HINGE SIDE OF ALL DOOR FRAMES SHALL BE MOUNTED 4" MIN. FROM ADJACENT PERPENDICULAR WALL U.N.O.
- SINKS AND FITTING SHOWN WITHIN MILLWORK ARE INDICATED ON PLUMBING PLANS.
- CONTRACTOR SHALL FIELD MEASURE ALL AREAS TO RECEIVE MILLWORK PRIOR TO FABRICATION OF MILLWORK.
- VERIFY ALL PLUMBING FIXTURES WITH PLUMBING DRAWINGS.

### SHEET NOTES:

- FURNITURE BY FUTURE RESIDENT
- WELD DOOR OPEN
- REMOVE CONTAINER DOOR

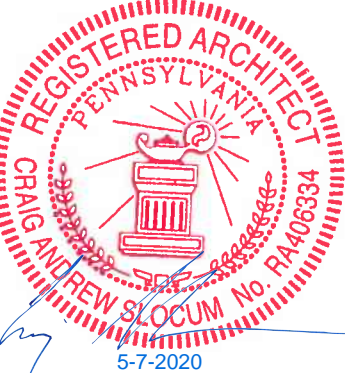

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### AGENCY SET

PROJECT	DATE
19176	05-07-2020
DRAWN	CHECKED
LMV	JSG / CAS

REVISED


SHEET TITLE

PLANS

SHEET


**A21**

ORIGINAL SHEET SIZE  
24" x 36"

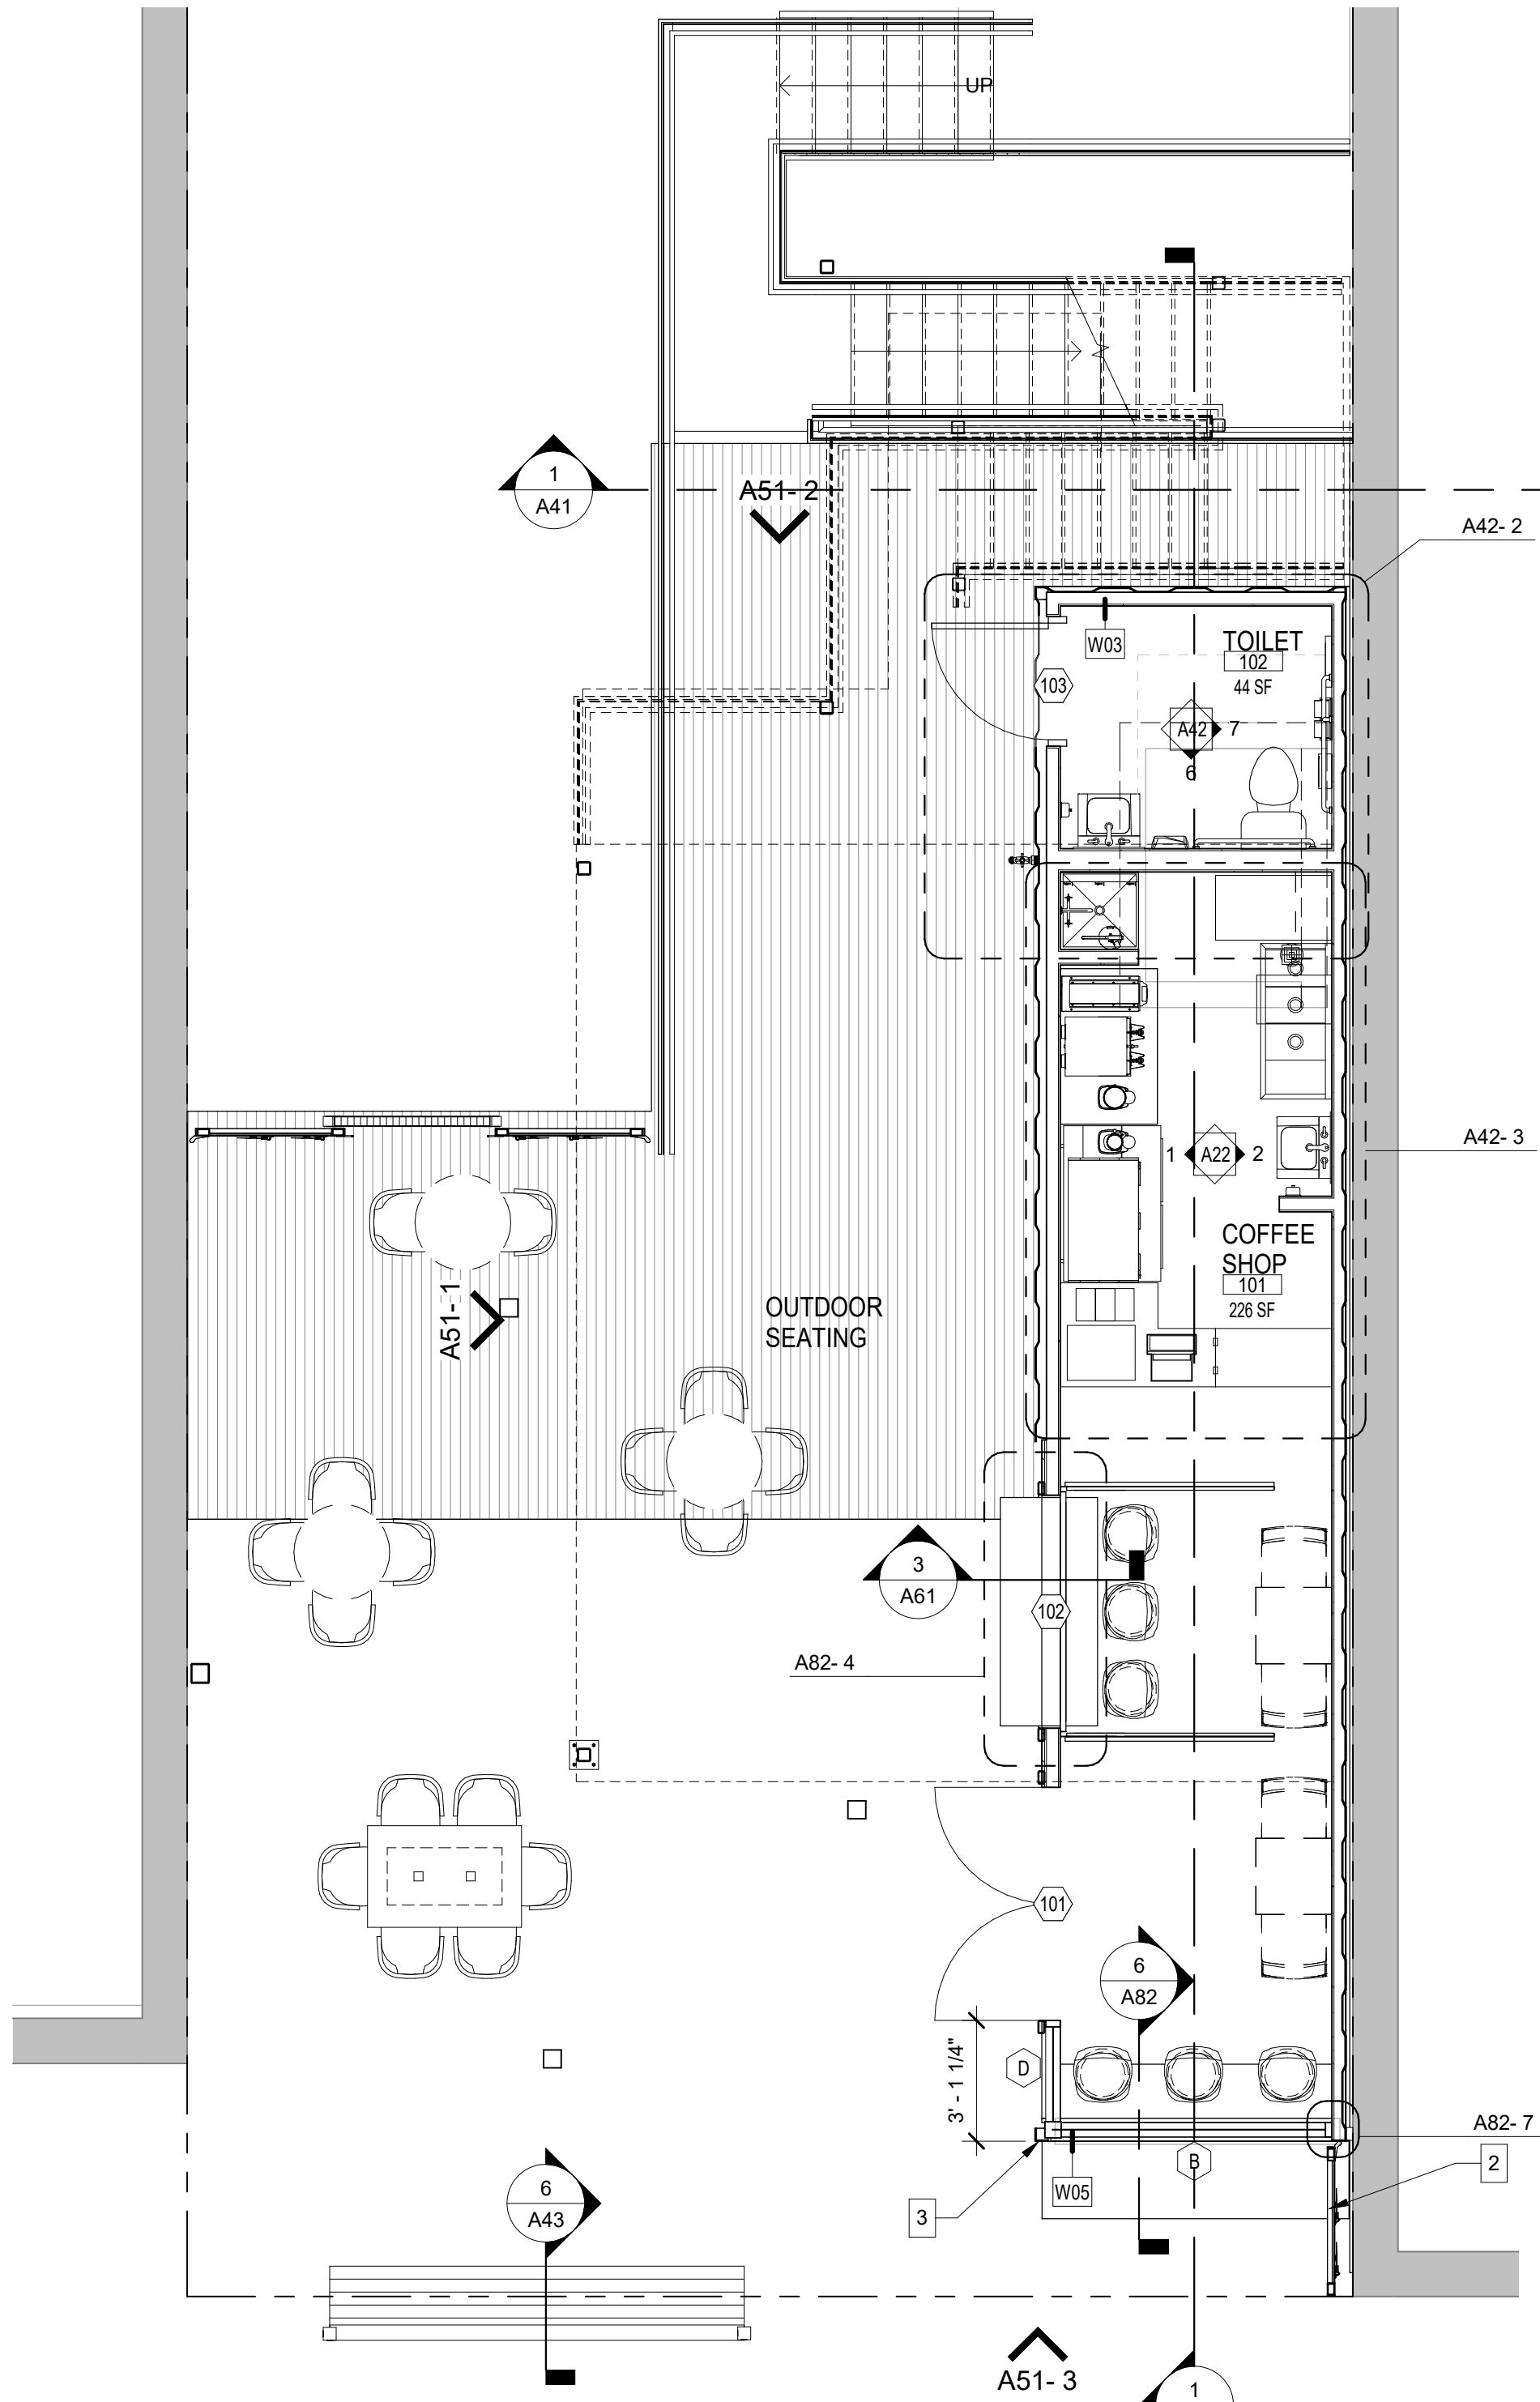

## 2 FLOOR PLAN - LEVEL 1


1/4" = 1'-0"

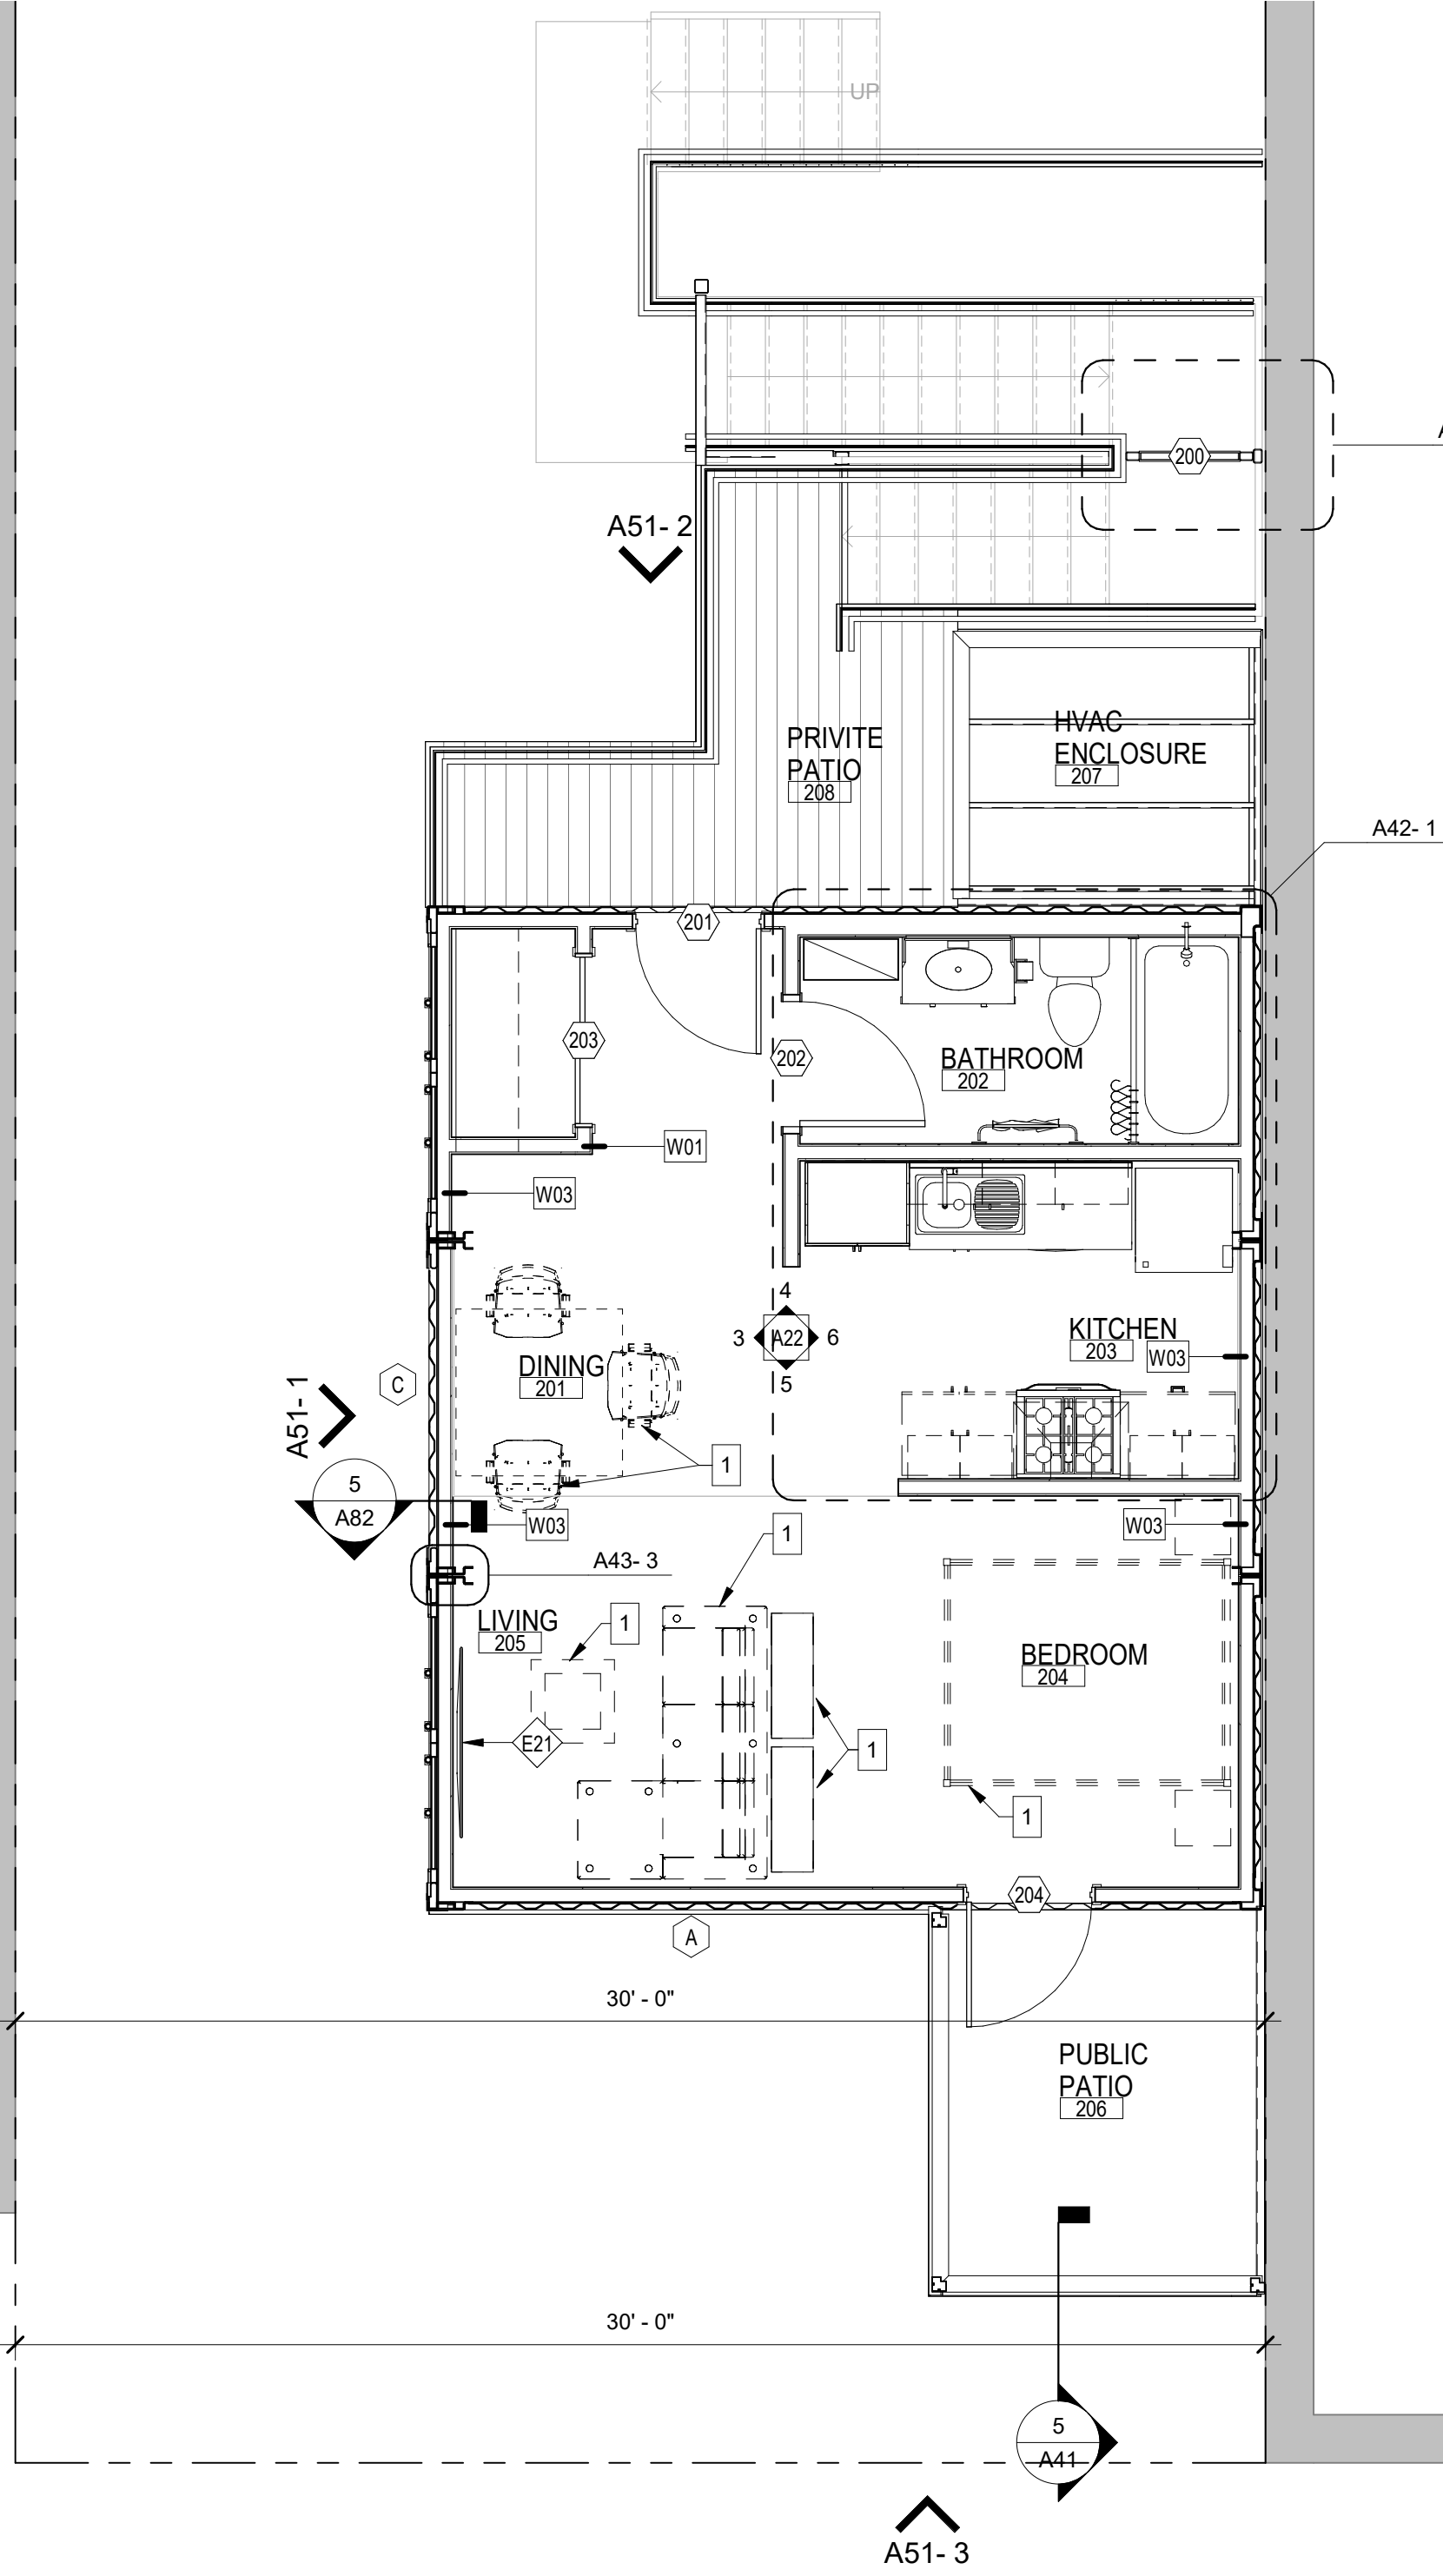


## 1 FLOOR PLAN - LEVEL 2

1/4" = 1'-0"




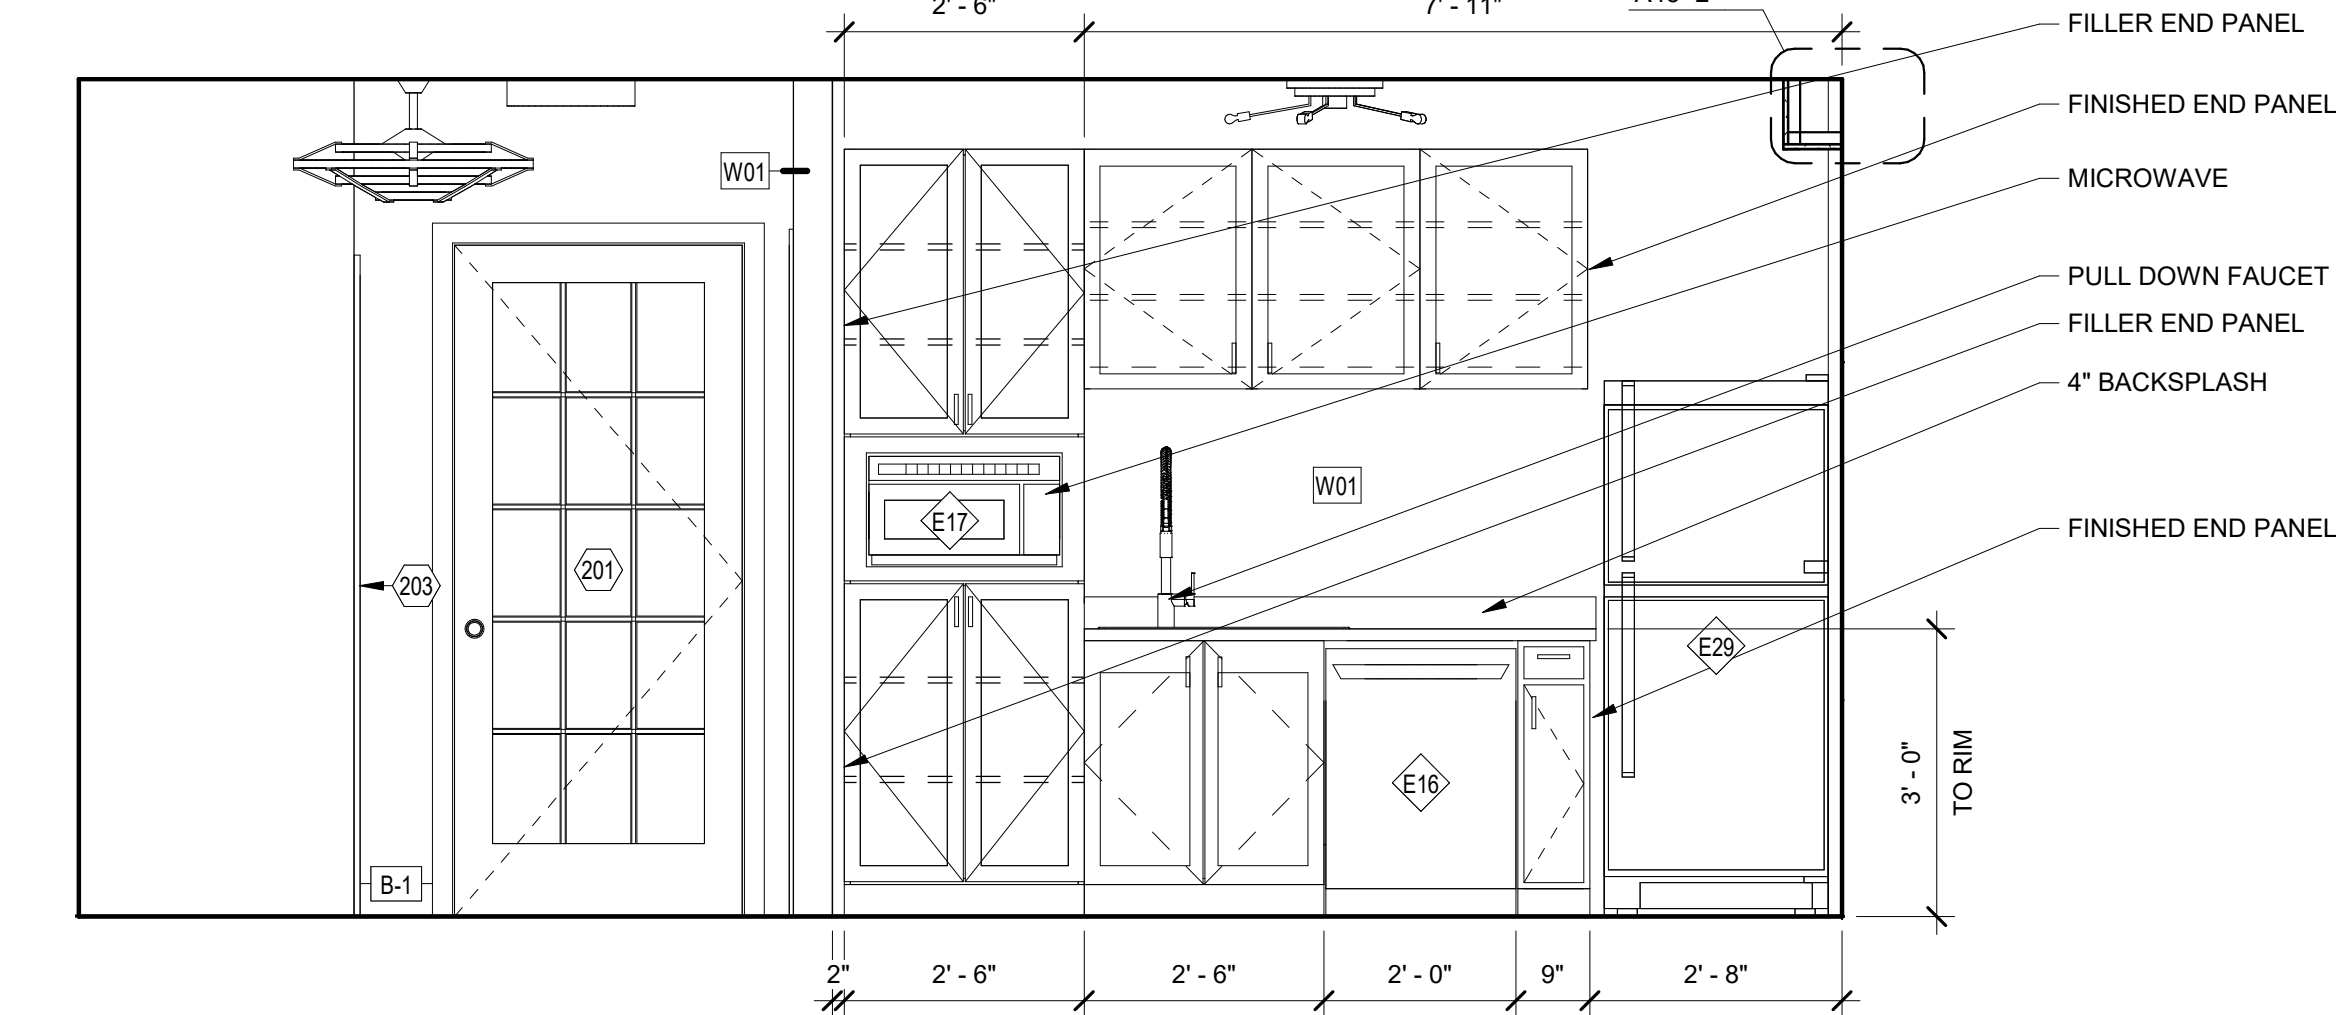


4 KITCHEN ELEVATION  
1/2" = 1'-0"

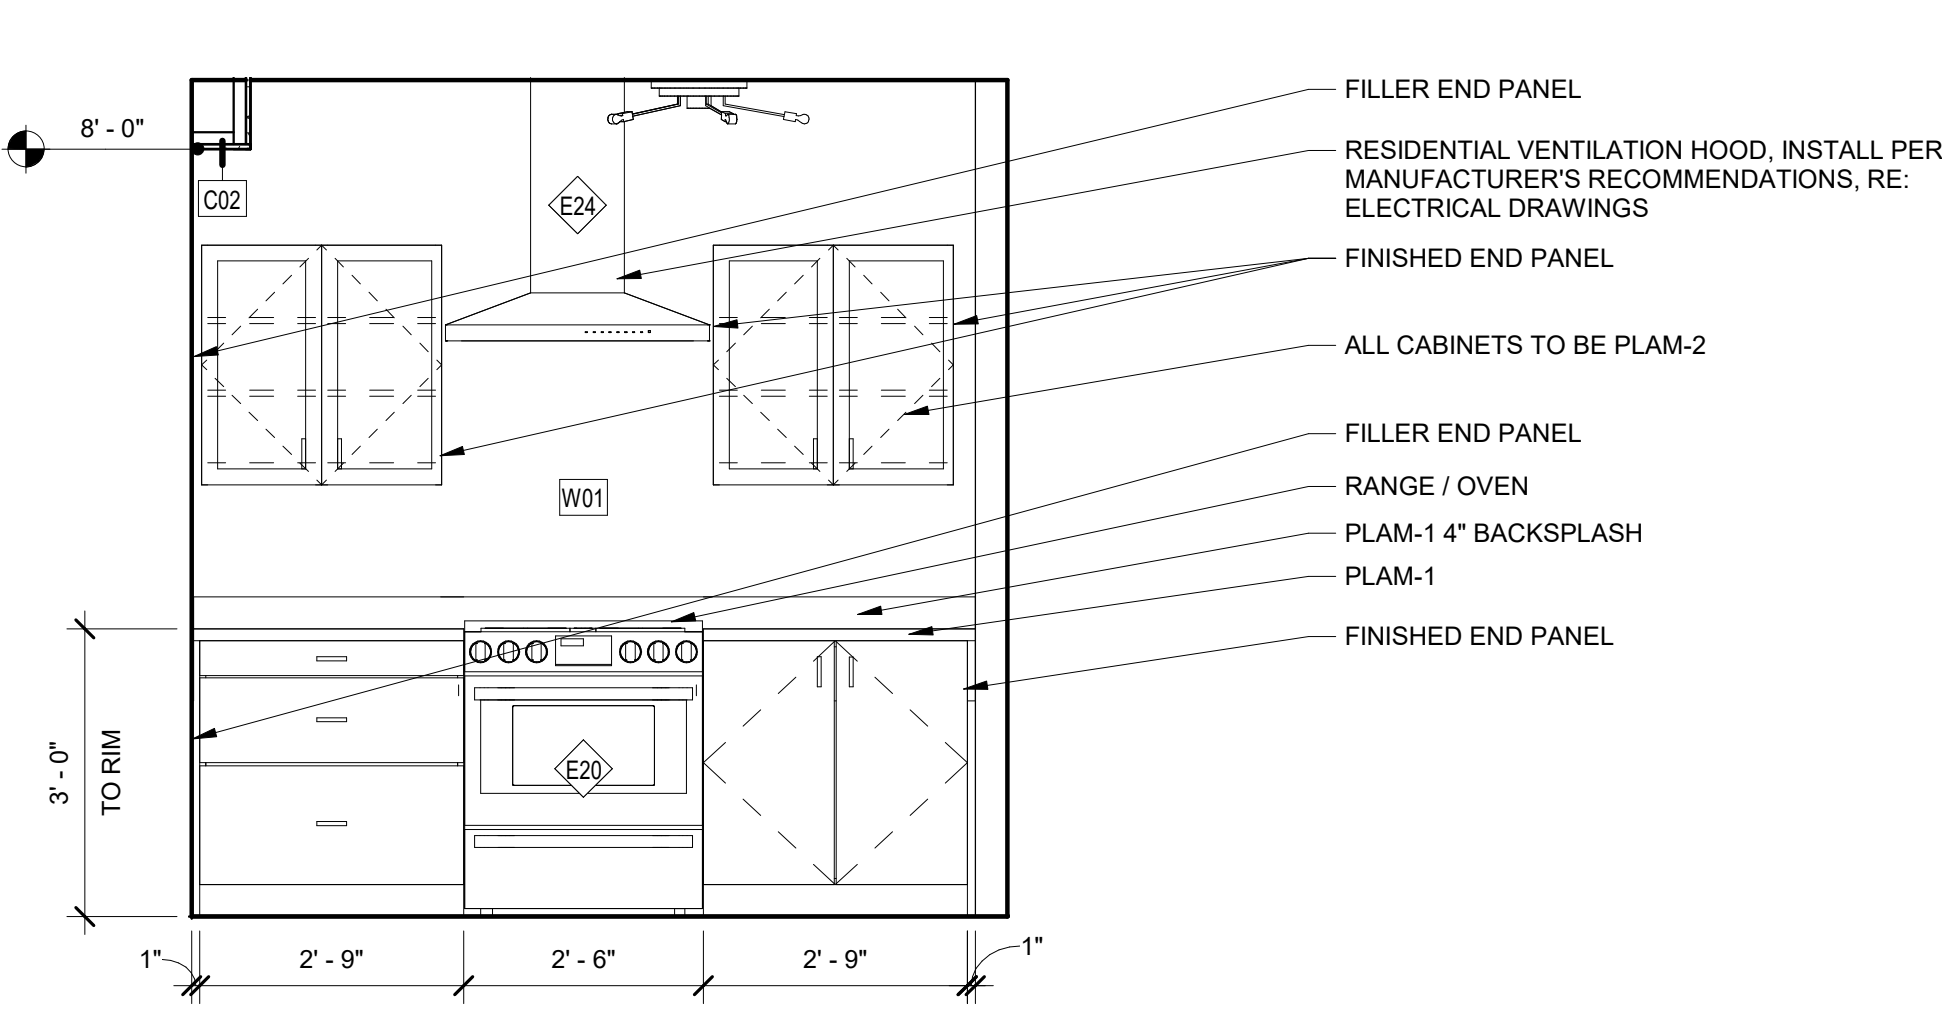


5 KITCHEN ELEVATION 2  
1/2" = 1'-0"

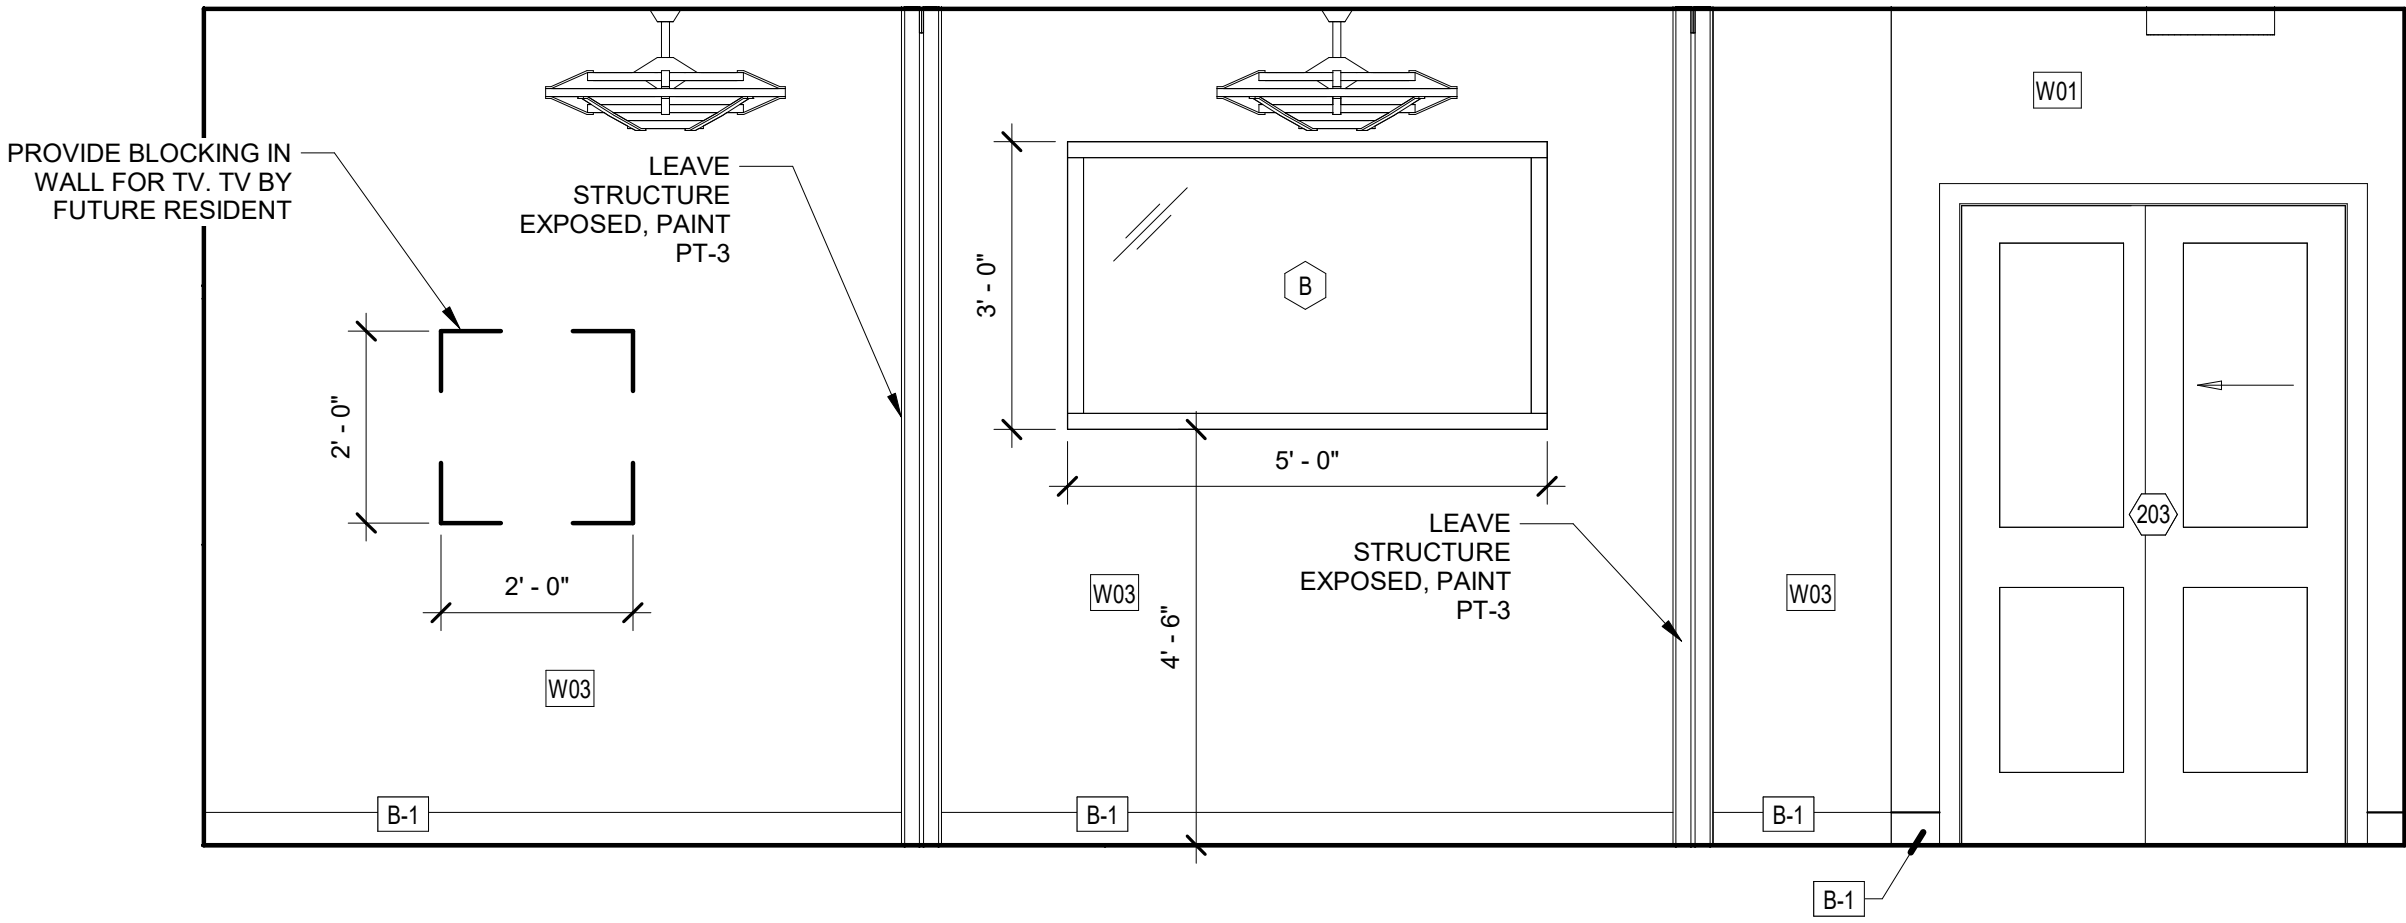


3 APARTMENT DINNING ELEVATION  
1/2" = 1'-0"

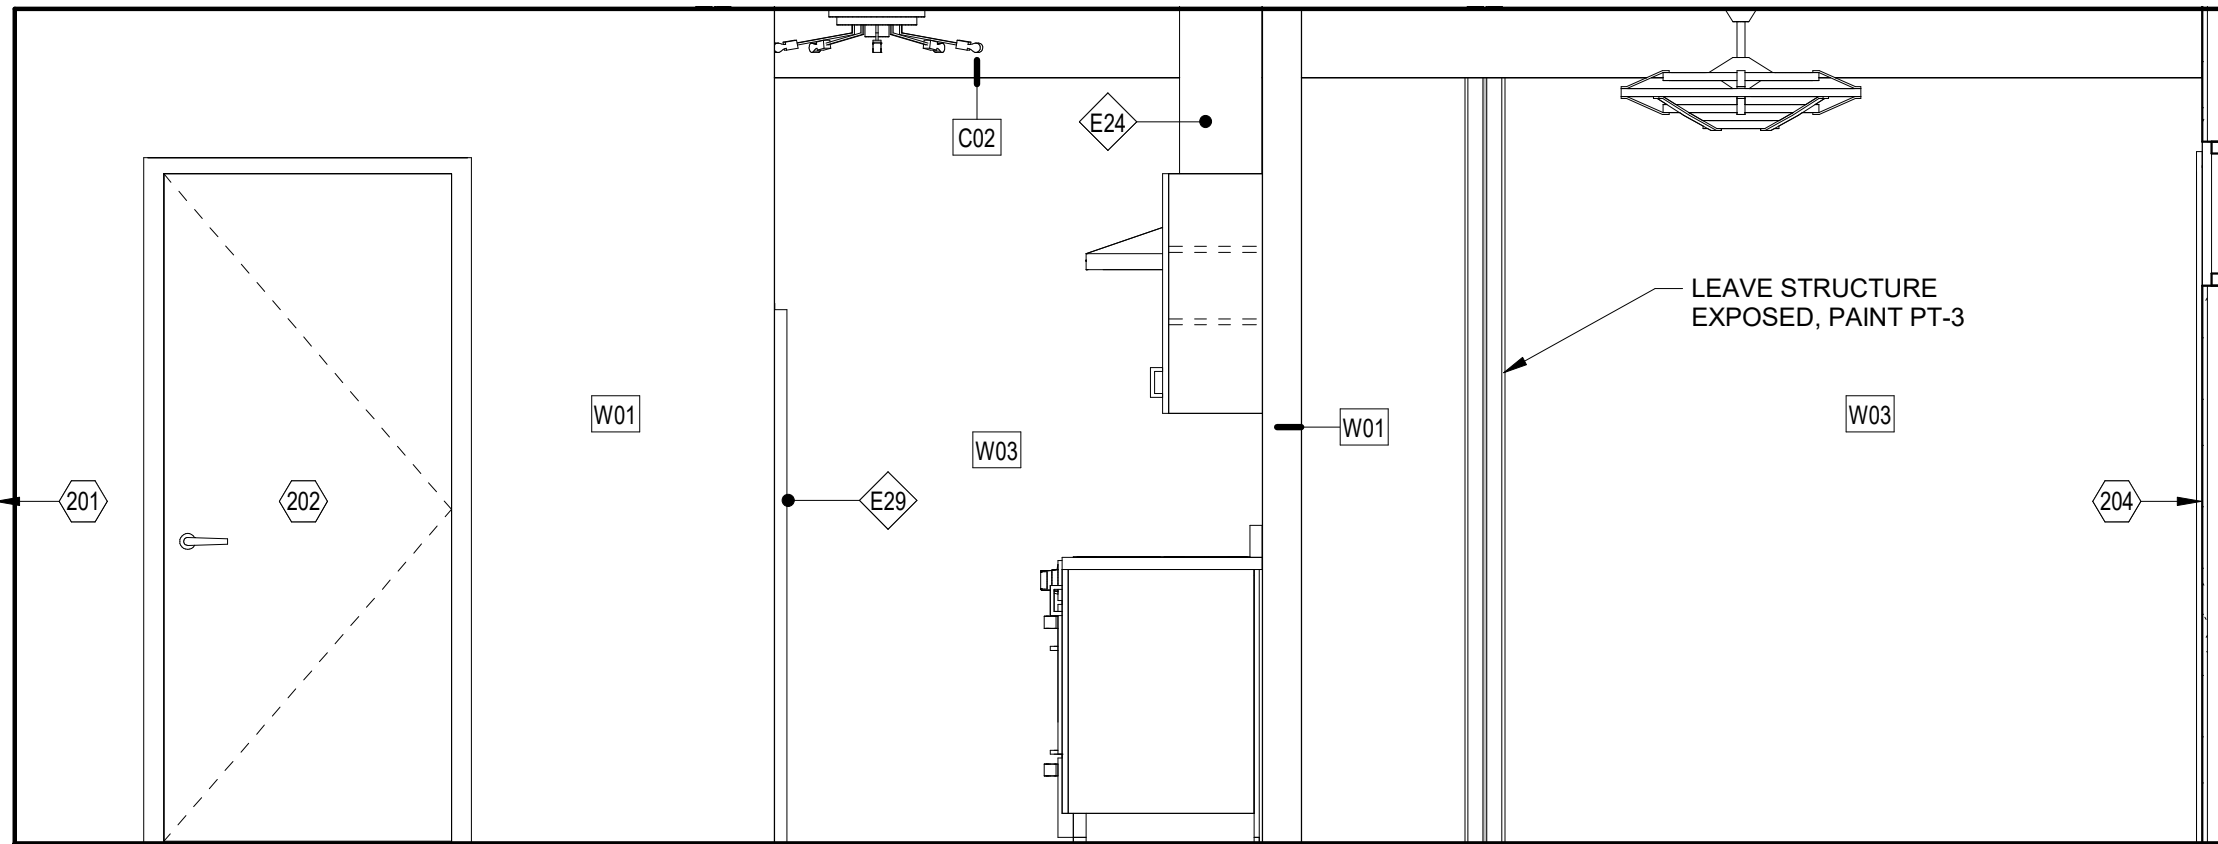

6 APARTMENT BATH / KITCHEN / BEDROOM ELEVATION  
1/2" = 1'-0"

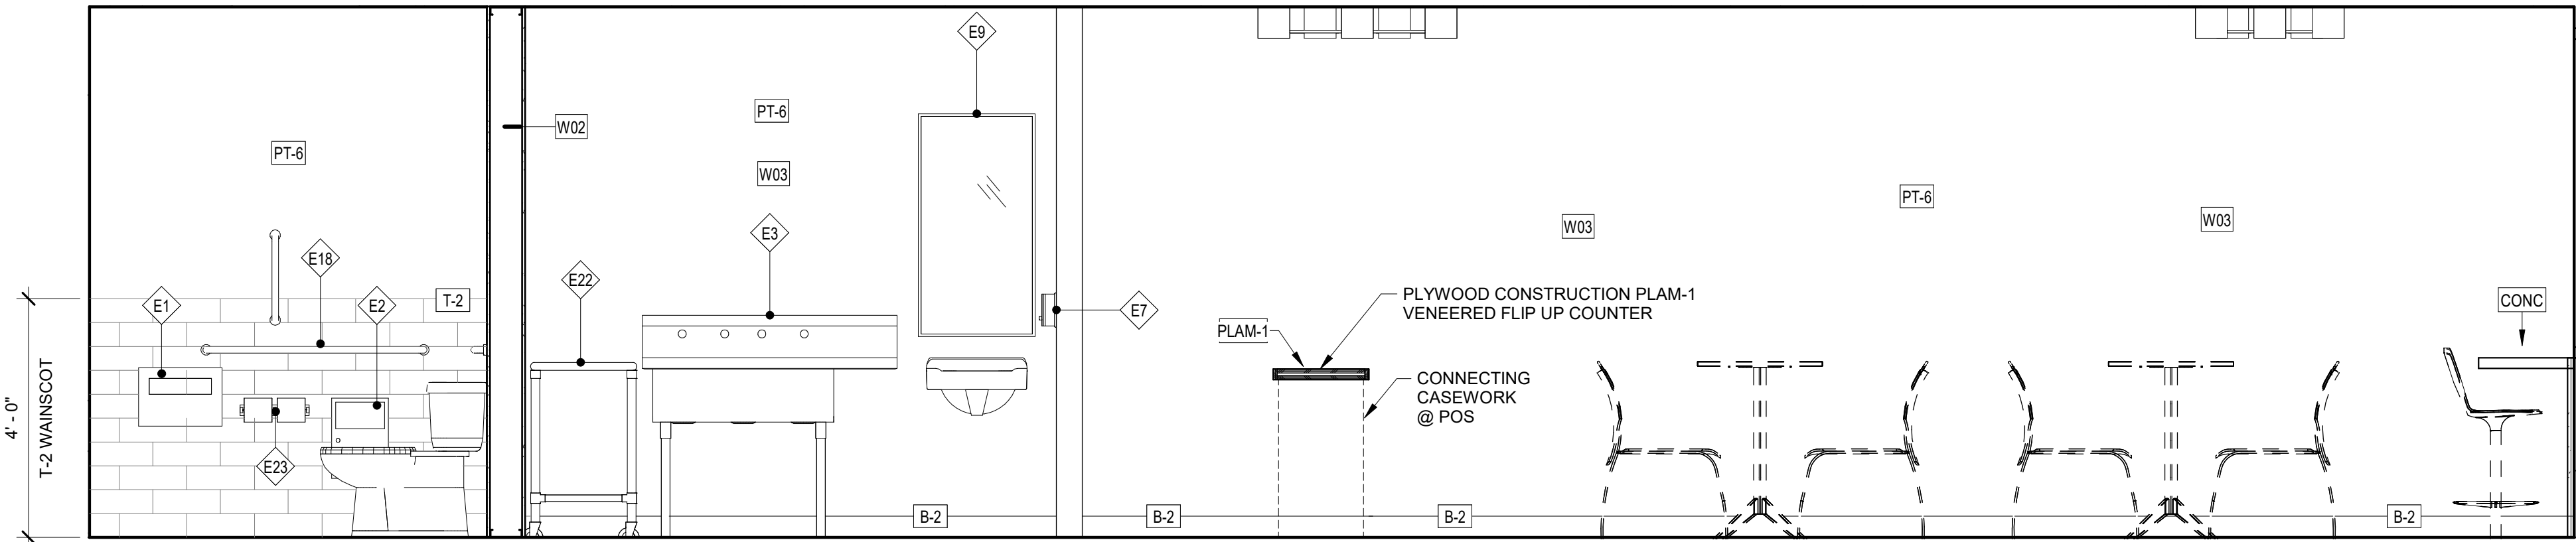


2 COFFE SHOP ELEVATION  
1/2" = 1'-0"

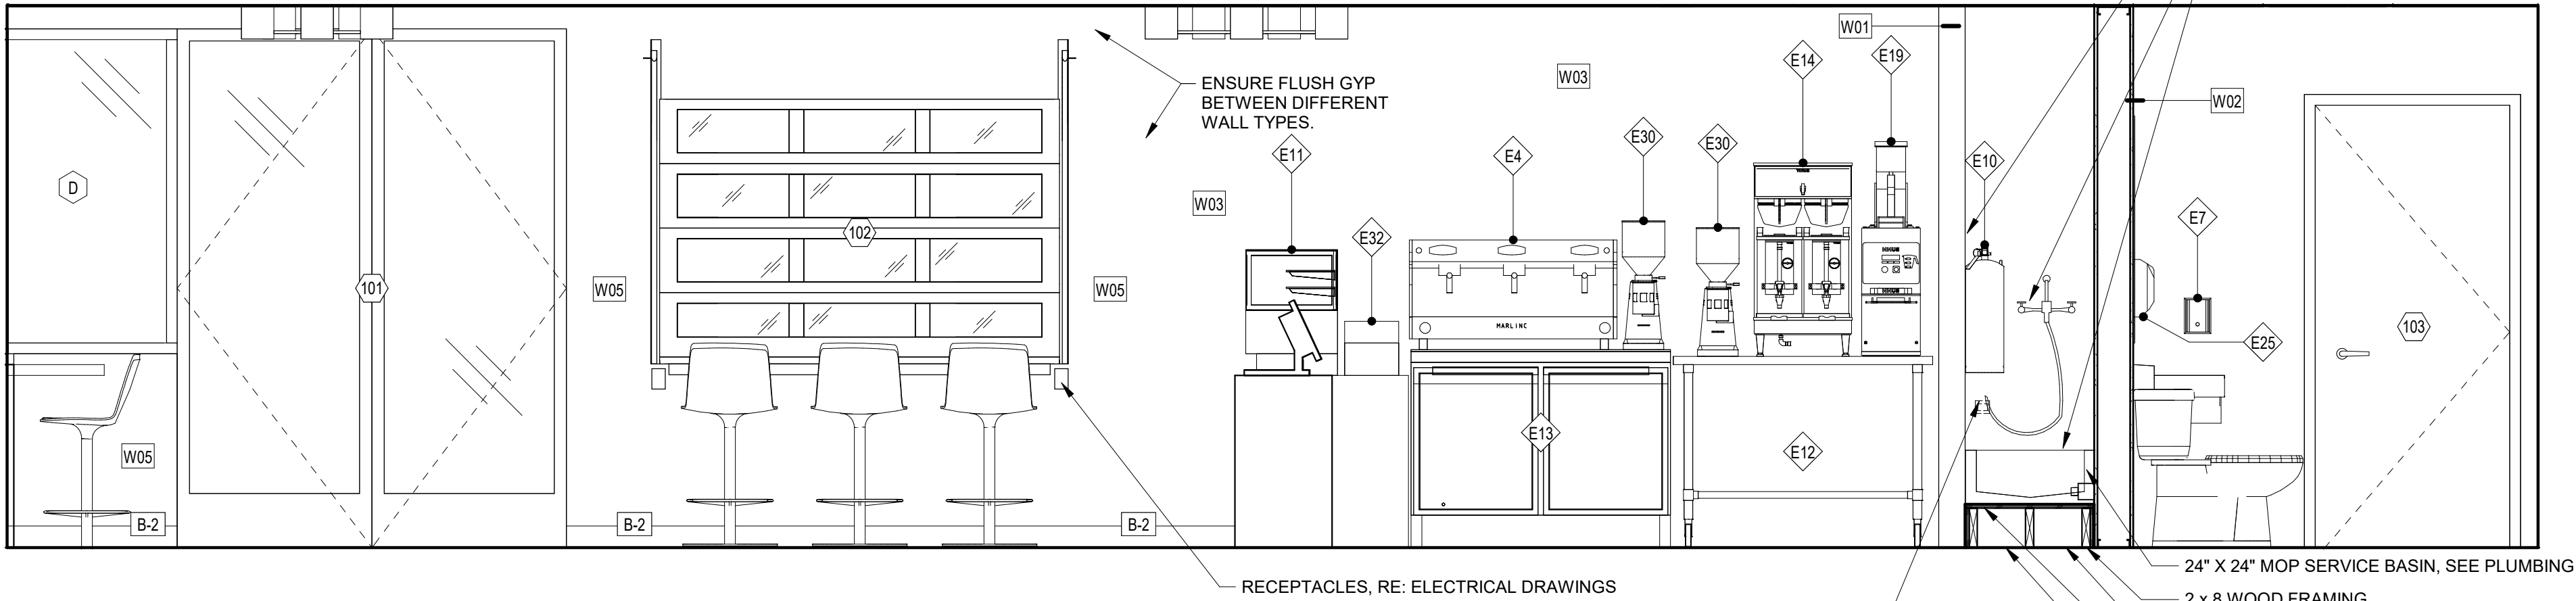

1 COFFEE SHOP ELEVATION DOOR SIDE  
1/2" = 1'-0"

## GENERAL NOTES:

- FINISH FLOOR ELEVATION (100.00) IS FOR REFERENCE ONLY. SEE SEPARATE BOUND CIVIL SET FOR ACTUAL FLOOR ELEVATION.
- ALL WALL DIMENSIONS ARE TO FACE OF FINISHED WALL.
- PROVIDE BLOCKING WHERE REQUIRED FOR FIXTURE INSTALLATION. COORDINATE WITH FIXTURE INSTALLER FOR MOUNTING HEIGHTS.
- BRACE WALLS THAT DO NOT EXTEND TO STRUCTURE WITH 3 5/8" METAL STUD DIAGONAL BRACE AT 48" O.C., ANCHOR TO BOTTOM FLUTE OF ROOF DECKING AND AT TOP TRACK OF PARTITION WALL. BRACES TO BE CONCEALED WHENEVER POSSIBLE.
- THE HINGE SIDE OF ALL DOOR FRAMES SHALL BE MOUNTED 4" FROM ADJACENT PERPENDICULAR WALL UNLESS NOTED OTHERWISE.
- RE: I-SERIES FOR FURNITURE PLANS.
- CONTRACTOR SHALL PROVIDE BLOCKING OR BACKING FOR ALL WALL MOUNTED AND RECESSED ACCESSORIES AND EQUIPMENT. ASSURE THAT ALL REQUIRED BACKING IS INSTALLED IN WALLS PRIOR TO INSTALLING DRYWALL. THIS INCLUDES BACKING FOR WALL-MOUNTED DOORSTOPS.
- THE HINGE SIDE OF ALL DOOR FRAMES SHALL BE MOUNTED 4" MIN. FROM ADJACENT PERPENDICULAR WALL U.N.O.
- SINKS AND FITTING SHOWN WITHIN MILLWORK ARE INDICATED ON PLUMBING PLANS.
- CONTRACTOR SHALL FIELD MEASURE ALL AREAS TO RECEIVE MILLWORK PRIOR TO FABRICATION OF MILLWORK.
- VERIFY ALL PLUMBING FIXTURES WITH PLUMBING DRAWINGS.

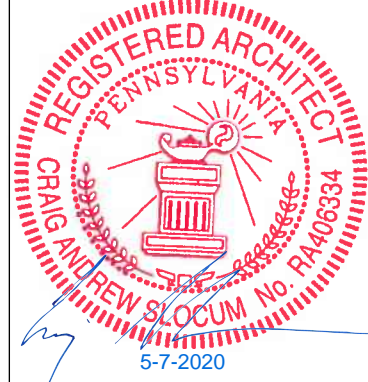

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## AGENCY SET

PROJECT  
19176  
DATE  
05-07-2020  
DRAWN  
LMV  
CHECKED  
JSG / CAS

REVISED

SHEET TITLE  
**INTERIOR ELEVATIONS**

SHEET

**A22**  
ORIGINAL SHEET SIZE  
24" x 36"


## Specialty Equipment Schedule

Mark	Description	Manufacturer	Model	Comments
E1	SEAT COVER DISPENSER	BOBRICK	B-5221	
E2	SANITARY NAPKIN DISPOSAL	BOBRICK	B-35139	
E3	3 COMP SINK			
E4	ESPRESSO MACHINE			
E5	TOILET PAPER DISPENSER	BOBRICK	B-685	
E6	TOWEL RACK	BOBRICK	B676 X 24	
E7	SOAP DISPENSER	BOBRICK	B-2012	
E8	MEDICINE CABINET MIRROR	BOBRICK	B-398	
E9	MIRROR	BOBRICK	B-165	
E10	FIRE EXTINGUISHER			MIN 2A RATING
E11	PASTRY DISPLAY CASE			
E12	STAINLESS STEEL ROLLING PREP TABLE 48" X 30"			
E13	COOLER			
E14	COFFEE MAKER			
E15	MOP SINK			
E16	DISHWASHER			
E17	MICROWAVE			
E18	ADA COMPLIANT GRAB BAR SET	BOBRICK		
E19	COFFEE GRINDER			
E20	RANGE / OVEN			
E21	TV			
E22	STAINLESS STEEL ROLLING PREP TABLE 36" X 18"			
E23	TOILET PAPER DISPENSER	BOBRICK	B-697	
E24	VENT HOOD			
E25	HAND DRYER	BOBRICK	B-7128	
E26	SINK CABINET WITH 2 DRAWERS, GRAY, 32-1/2" X 19-1/4" X 35"	IKEA	HEMNES / RATTVIKEN	PROVIDE BLOCKING IN WALL AS NEEDED. FAUCET TO BE IKEA RUNSKAR BATH FAUCET WITH STRAINER, CHROME PLATED
E27	SHOWER CURTAIN ROD		B-207 X 60	
E28	SHOWER HARDWARE			
E29	REFRIGERATOR			OFCI
E30	FLOOR DRAIN			RE: PLUMBING
E32	SYRUP HOLDER			
E34	MOP AND BROOM HOLDER	BOBRICK	B-223 X 24	




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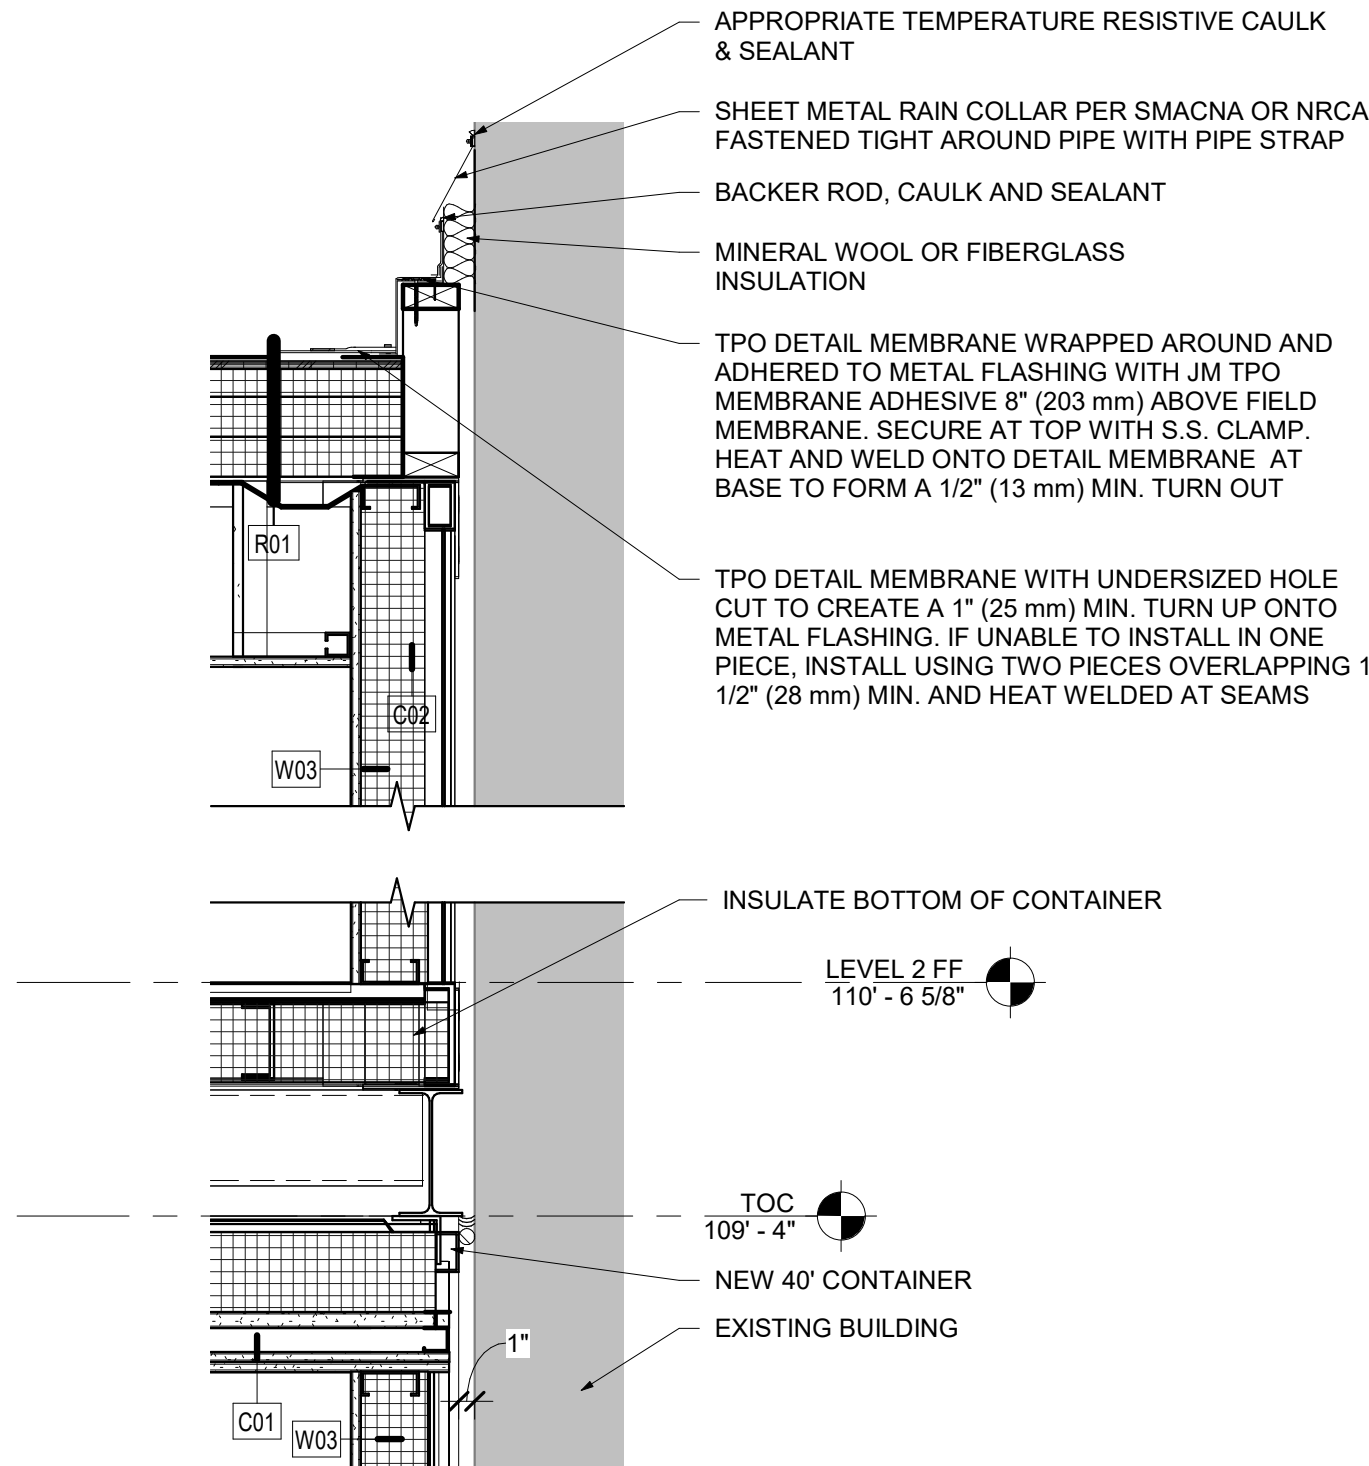
7 ATTACHMENT DETAIL 3  
1" = 1'-0"

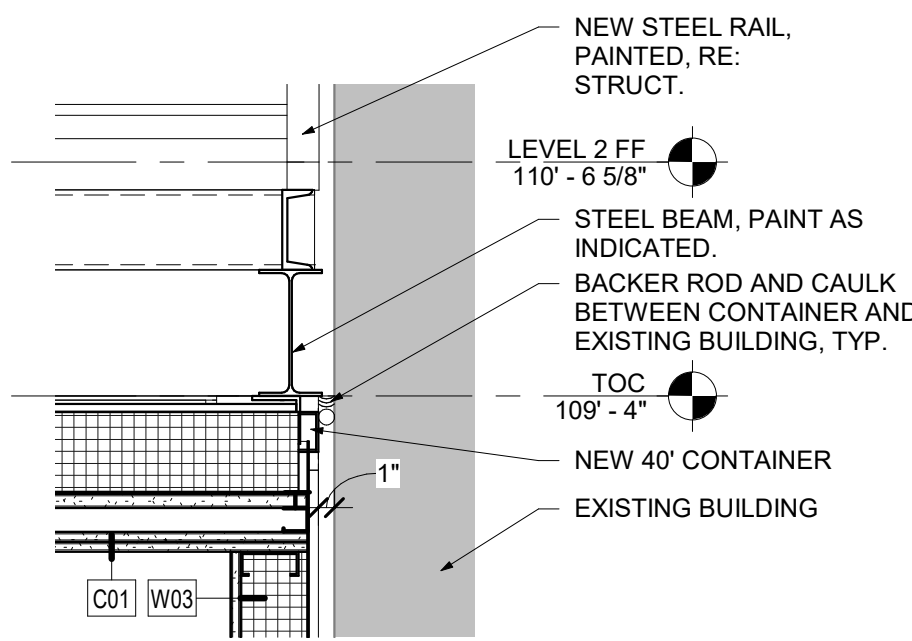


8 ATTACHMENT DETAIL 2  
1" = 1'-0"

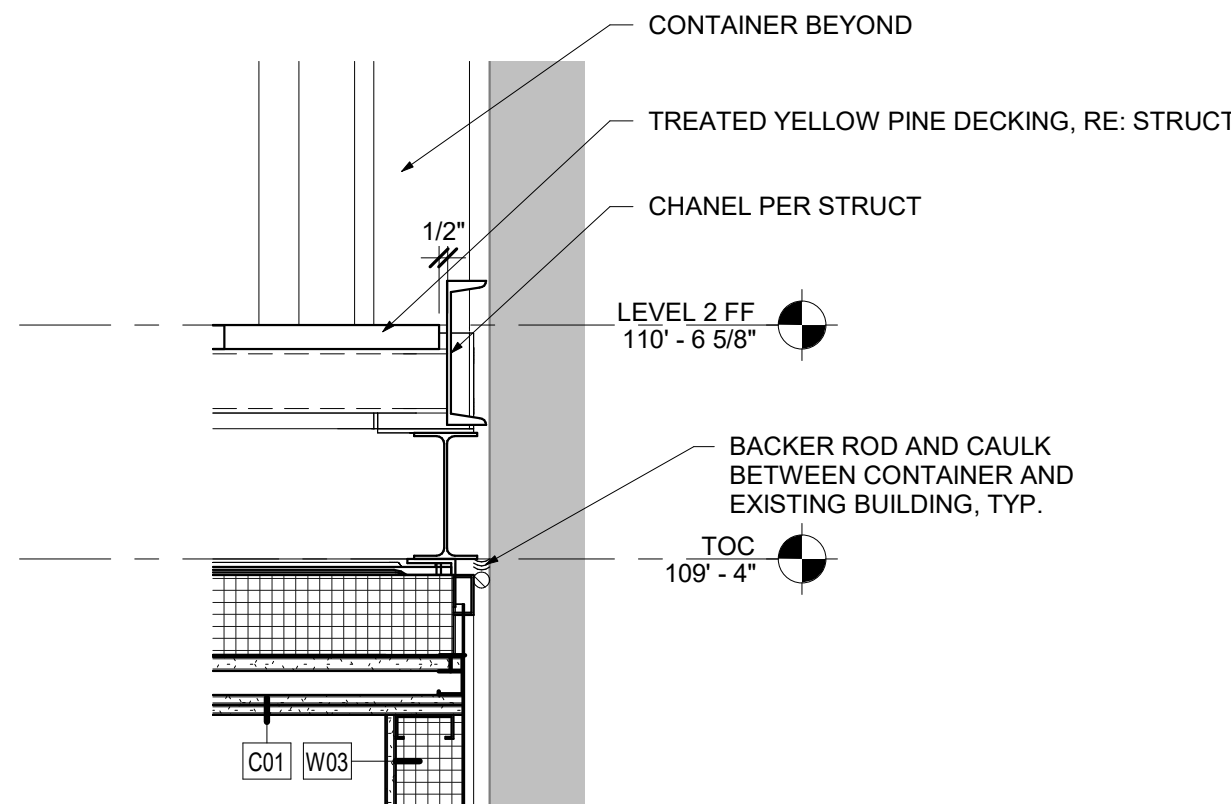


6 ATTACHMENT DETAIL 1  
1" = 1'-0"




5 ROOF SECTION - S MAIN STREET  
1 1/2" = 1'-0"

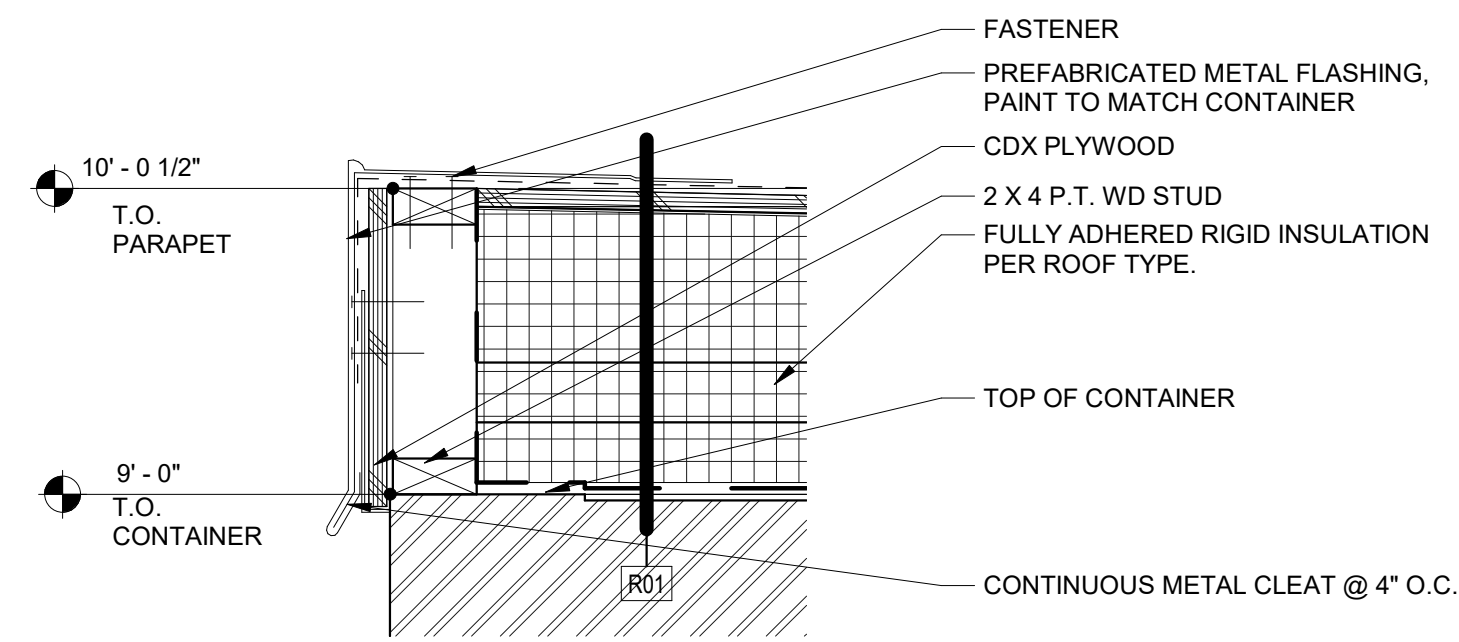


4 ROOF SECTION - GUTTER  
1 1/2" = 1'-0"

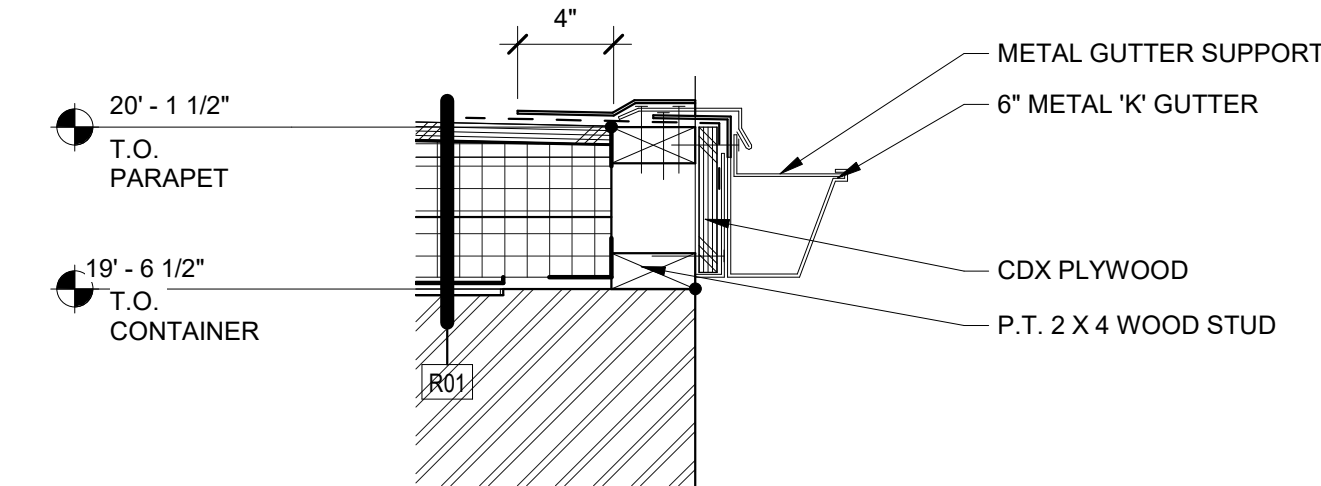


3 CONTAINER STACKING SECTION PUBLIC  
3/4" = 1'-0"

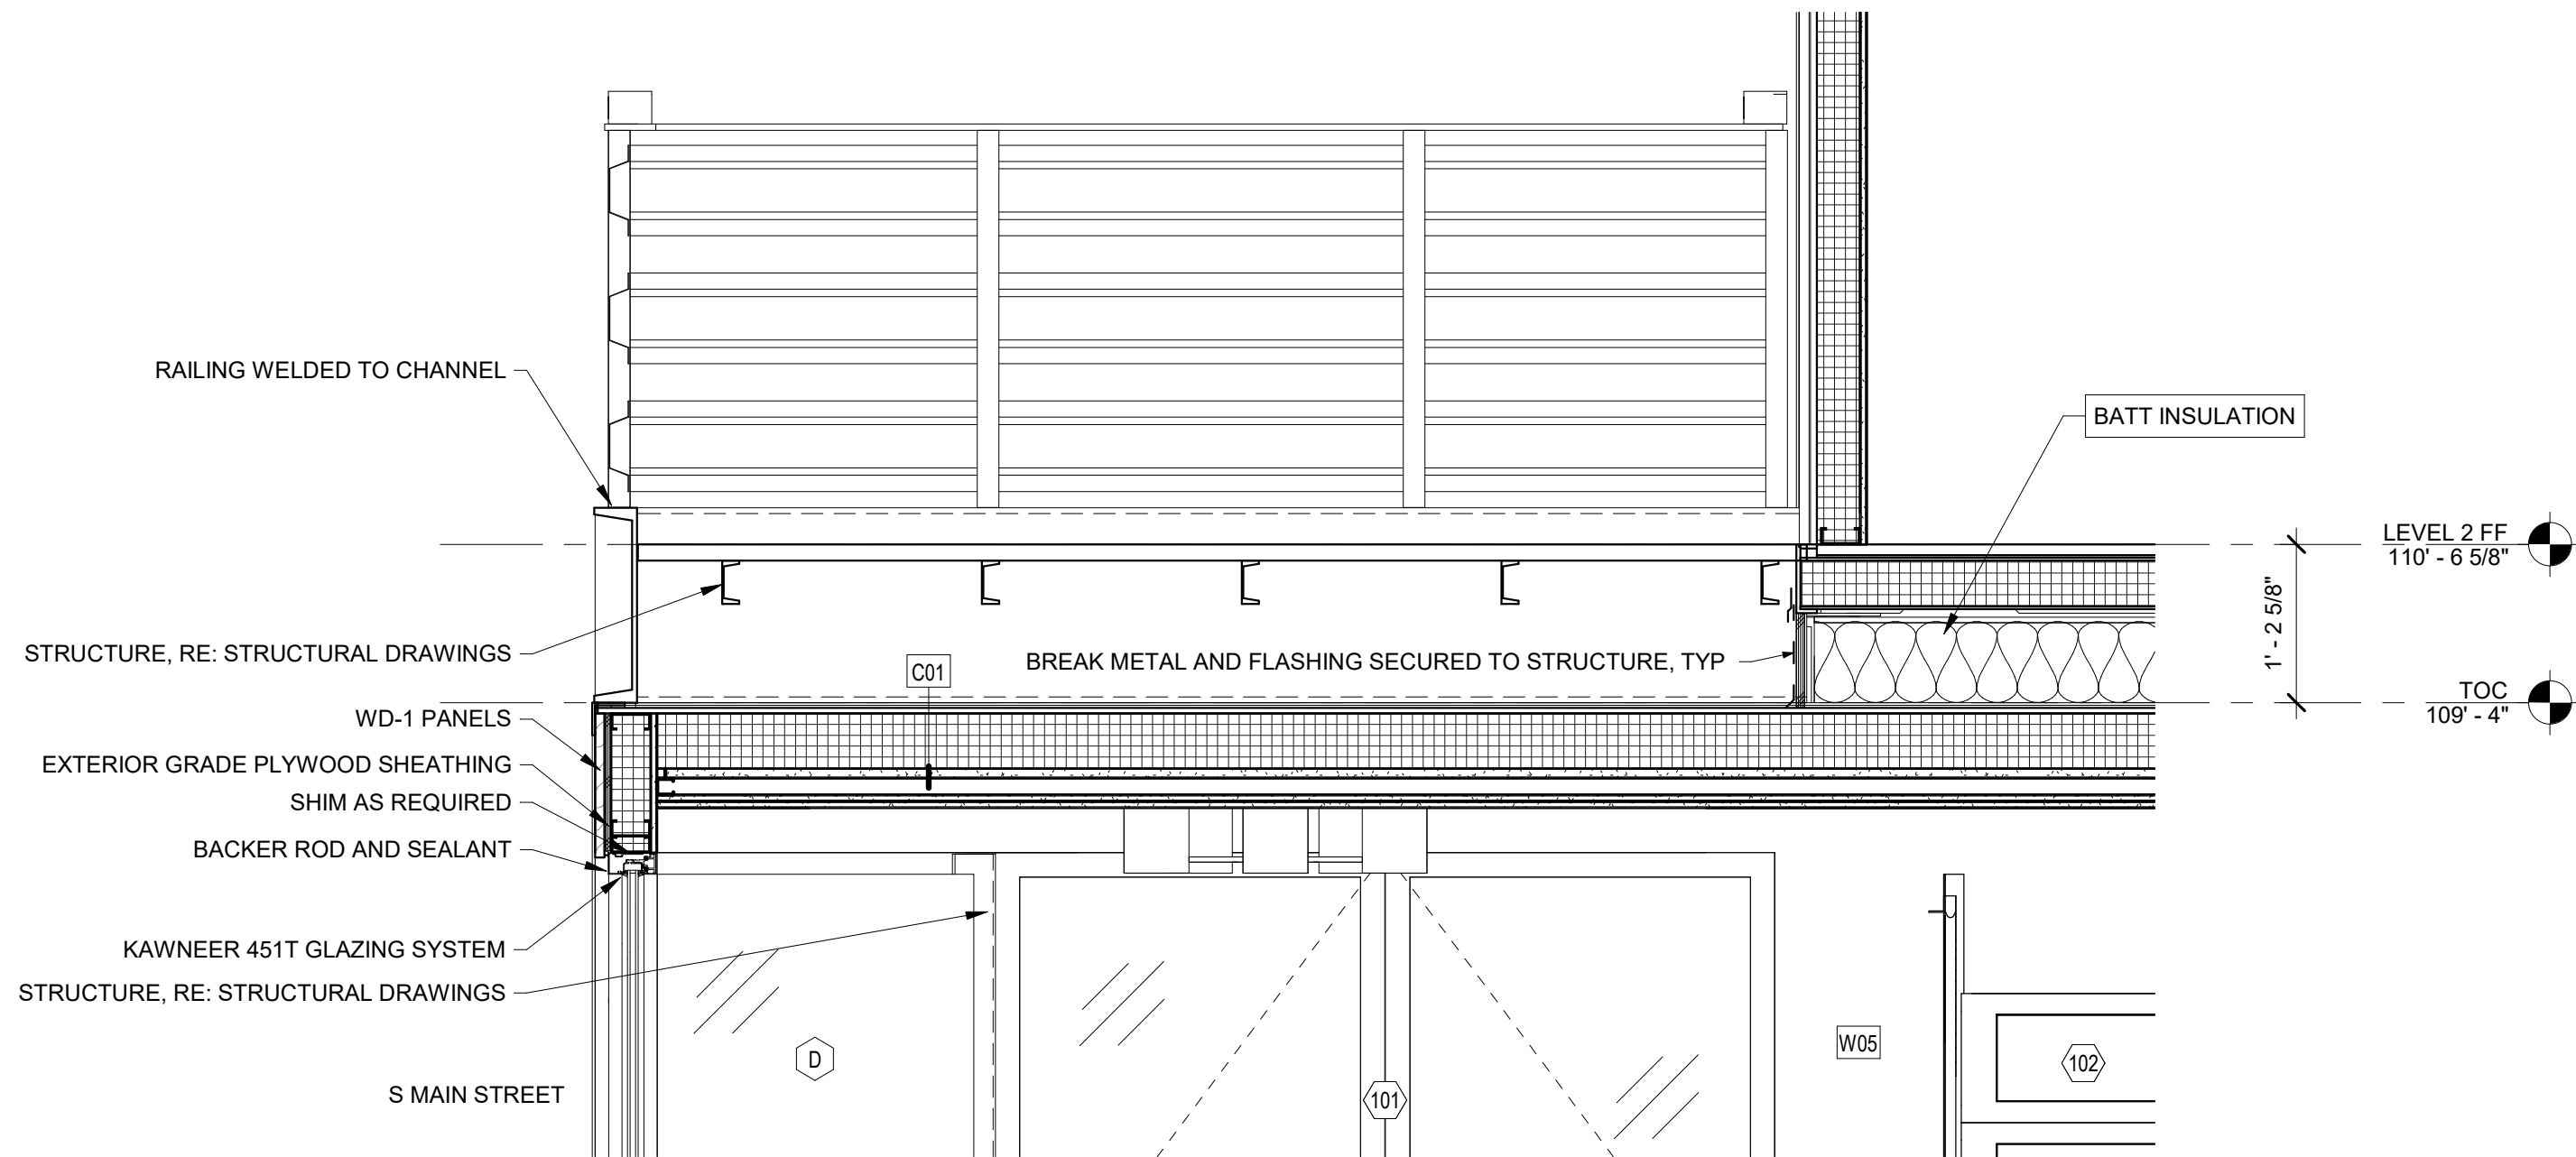

2 CONTAINER STACKING SECTION PRIVATE  
3/4" = 1'-0"

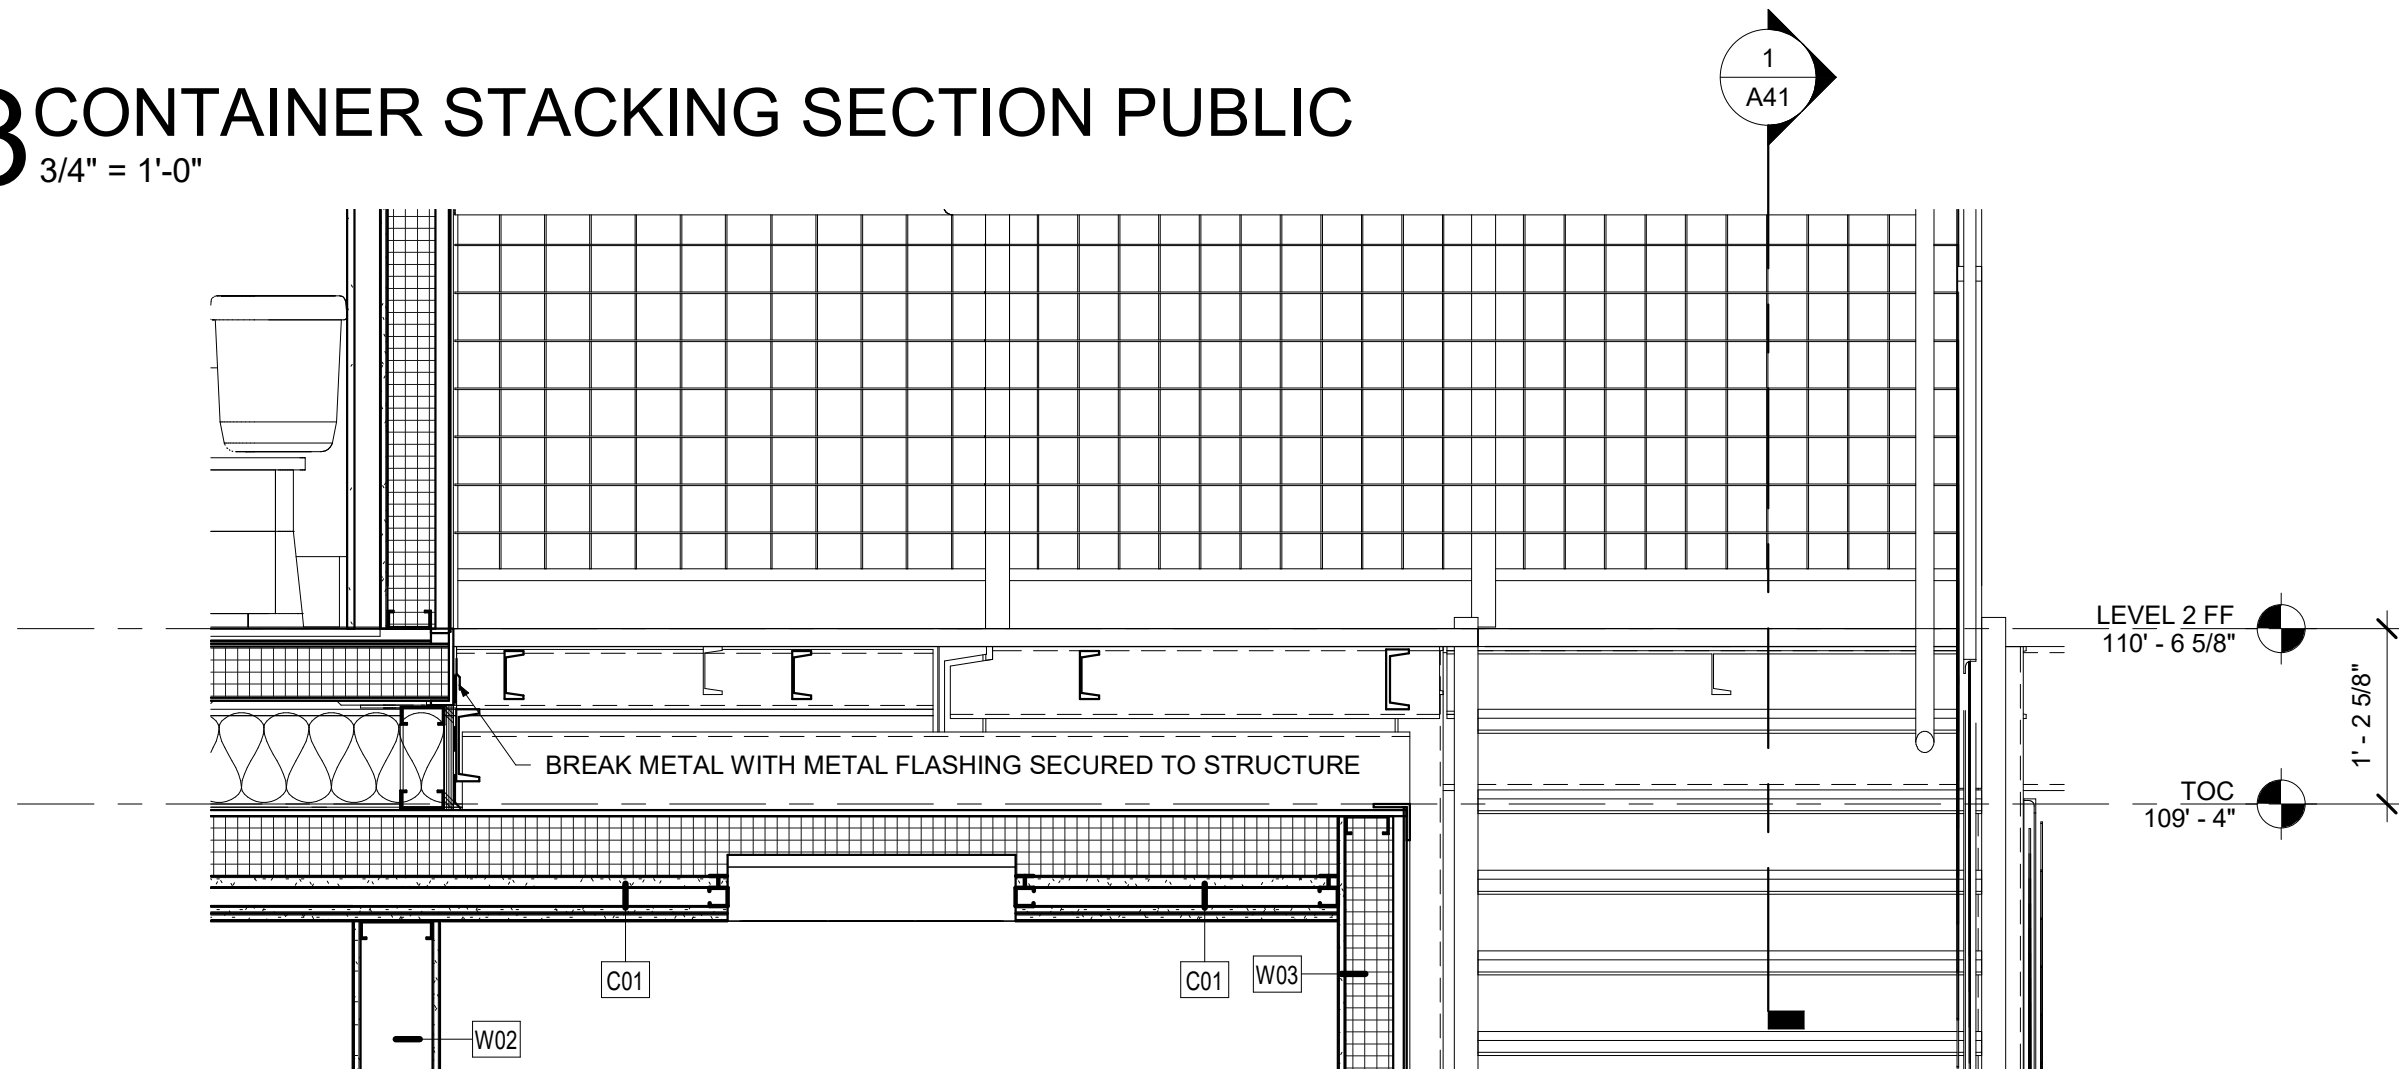


1 ROOF PLAN  
1/4" = 1'-0"

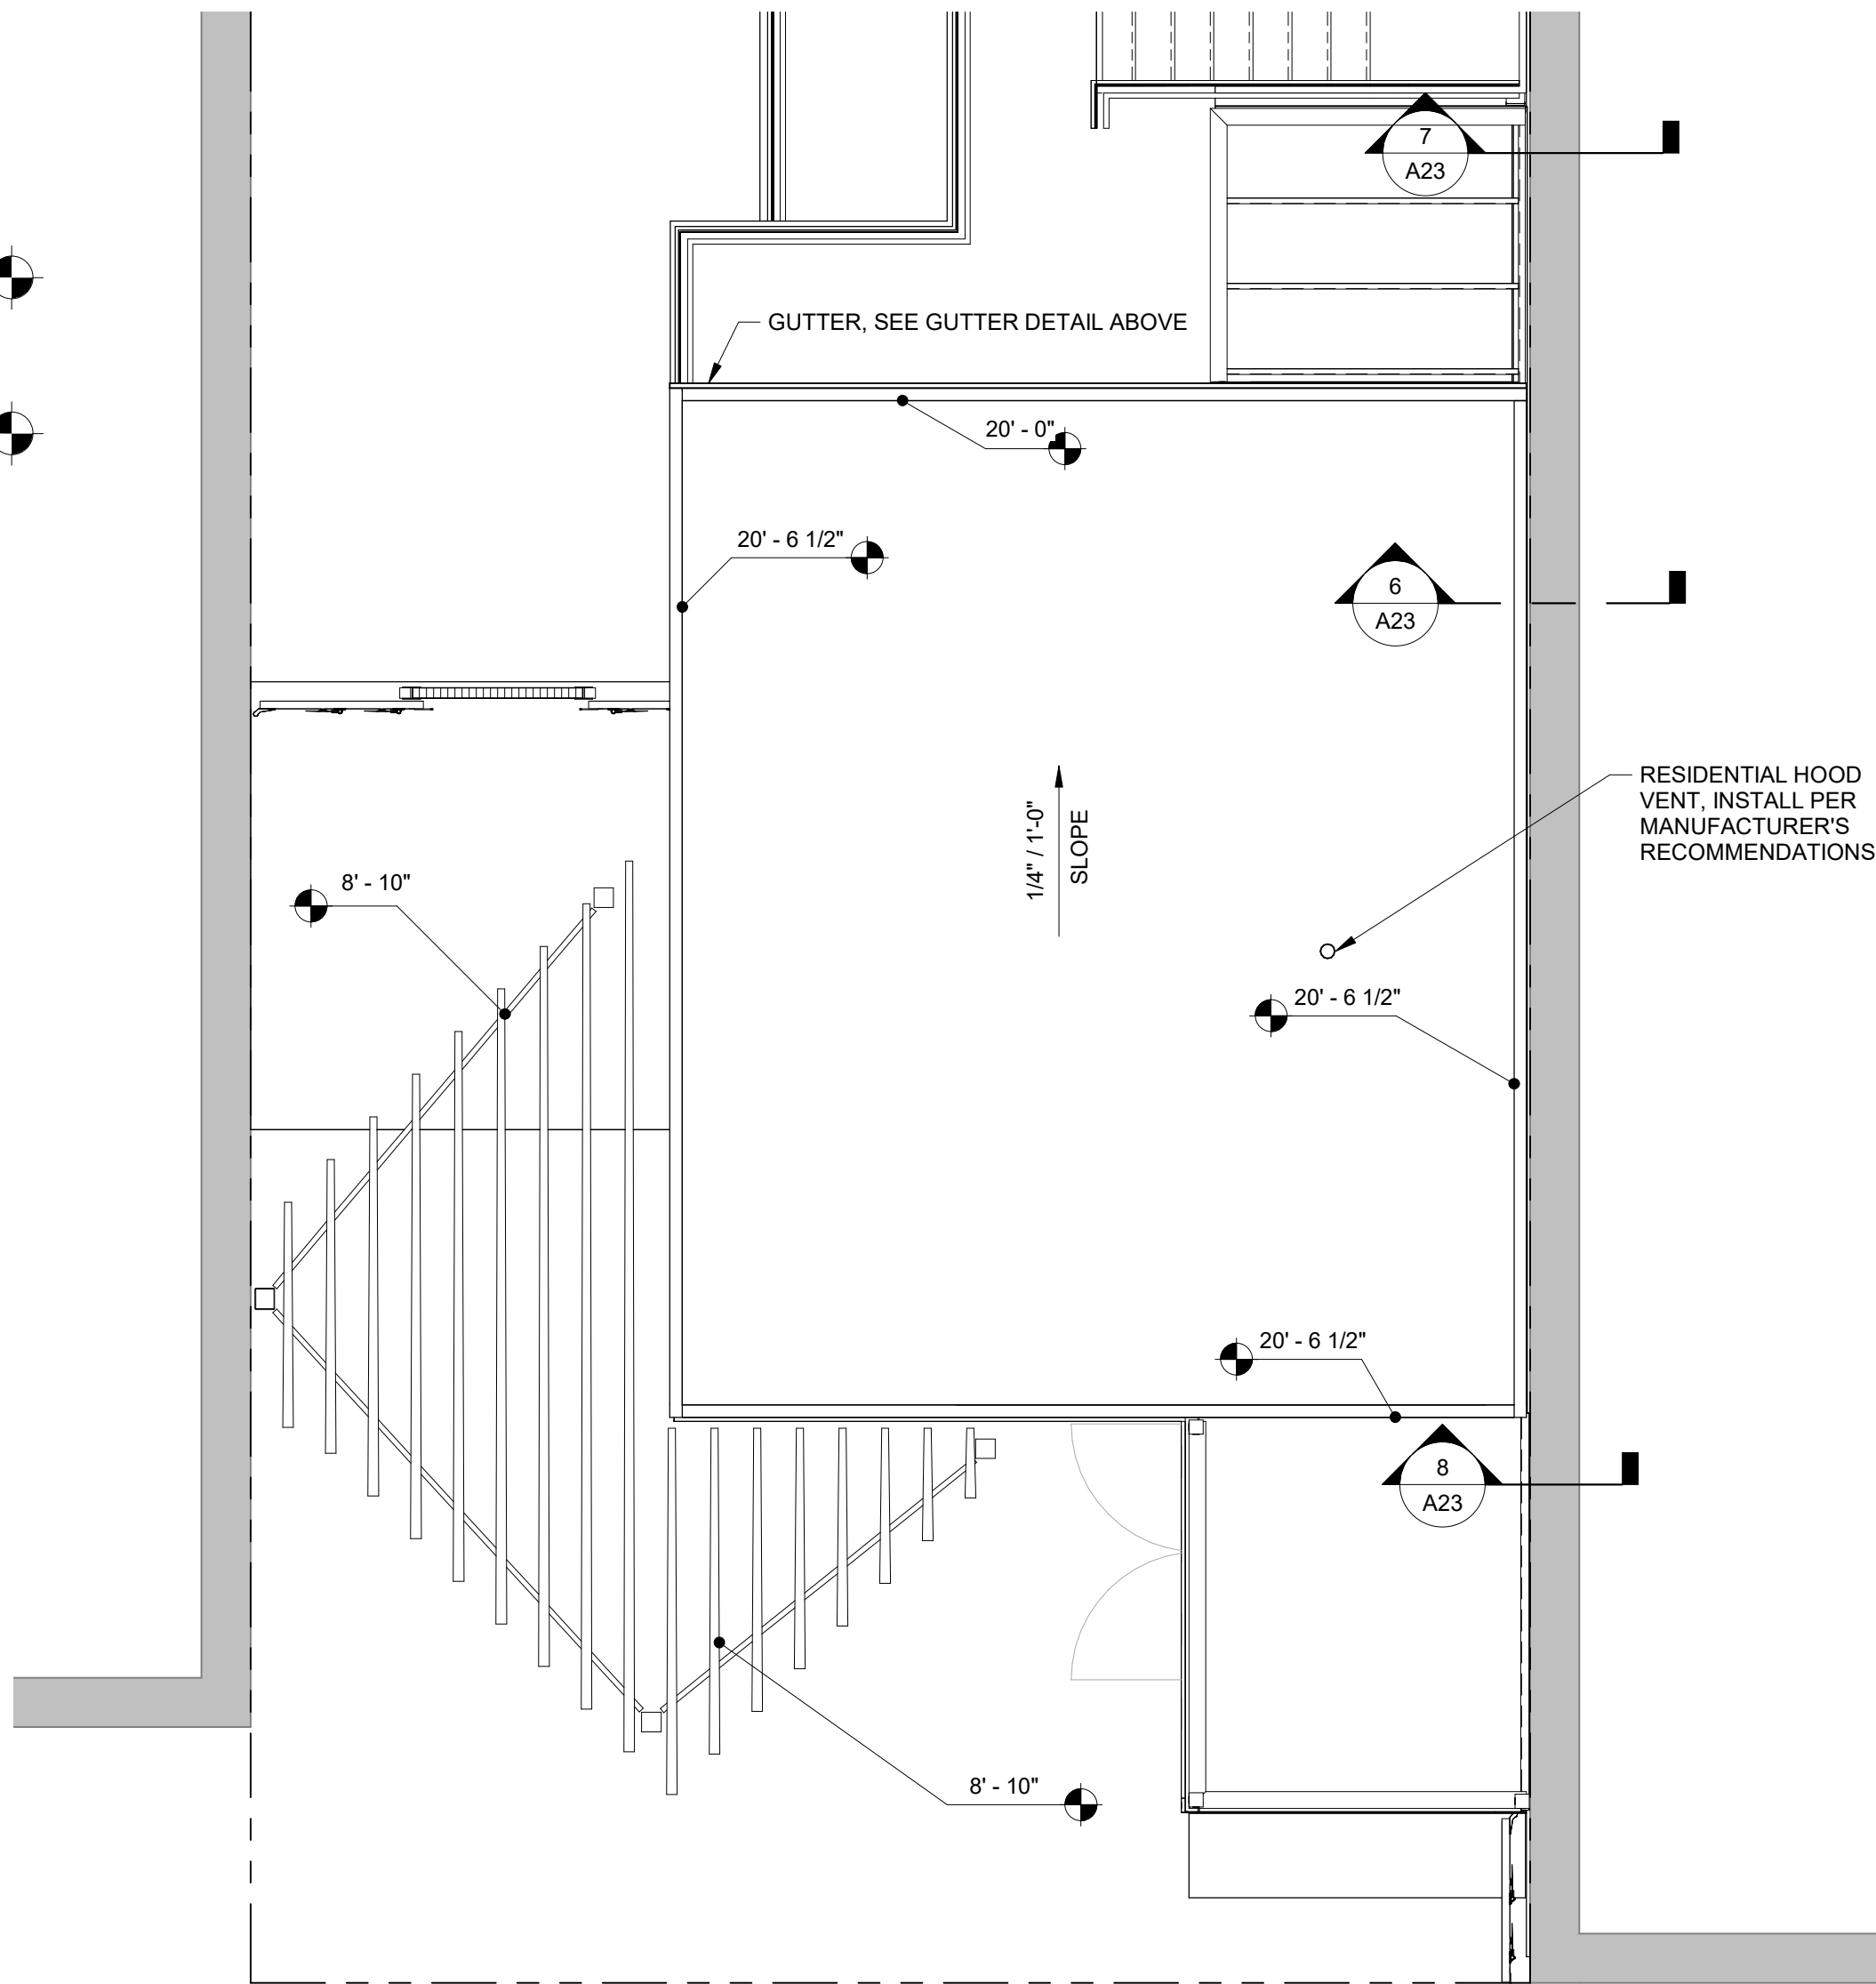

1 ROOF TYPES  
1" = 1'-0"


R01

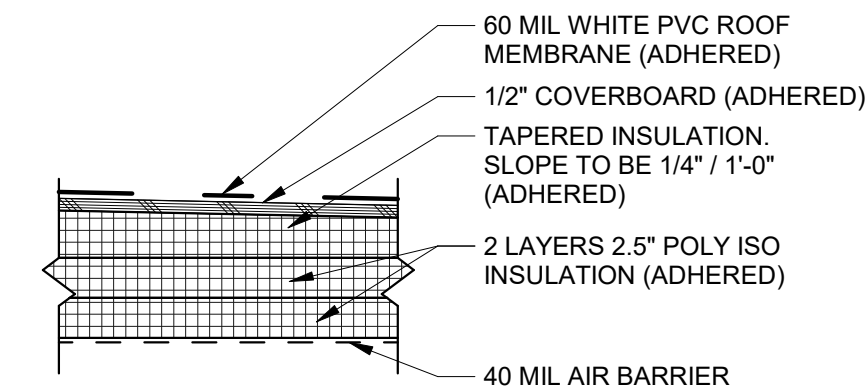

NOTES:  
1. ROOF TYPE R01 TO BE INSTALLED AT TOP OF RESIDENTIAL CONTAINER

## GENERAL NOTES:

- CONTRACTOR TO VERIFY & COORDINATE DUCT LAYOUT WITH CURB AND ROOF PENETRATION LOCATIONS, REFER ALSO TO REFRIGERATION DRAWINGS FOR REFRIGERATION PIPING REQUIREMENTS AND COORDINATION.
- SEE STRUCTURAL FRAMING PLAN FOR ROOF DECK HEIGHTS TO ESTABLISH ROOF SLOPES AND ROOF MEMBER LOCATIONS.
- MAINTAIN ALL ROOF PENETRATIONS 3'-0" OR GREATER FROM FLOW LINES
- PREFABRICATED CURBS (FOR ROOF TOP MECHANICAL & REFRIGERATION EQUIPMENT SHALL BE INSTALLED BY GENERAL CONTRACTOR AND SET LEVEL.
- ALL DIMENSIONS ARE FOR GENERAL ARRANGEMENT & LOCATION ONLY. ACTUAL REQUIREMENTS & DIMENSIONS SHOULD BE VERIFIED AND COORDINATED WITH EQUIPMENT, SHOP DRAWING SUBMITTALS AND STRUCTURAL FRAMING.
- ALL PLANES OF ROOF SHALL SLOPE MIN. 1/4" / L.F. TO DRAINS OR GUTTER, CW/ STRUCTURAL DRAWINGS
- NO PLUMBING VENTS OR EXHAUST UNITS WITHIN 10'-0" OF INTAKE OR 10'-0" OF EXTERIOR WALL.
- FABRICATE SHEET METAL CURB CAPS TO ALLOW FOR THICKNESS OF ROOFING PLY EXTENDING UP CURB FACE, RE: DETAILS
- SCUPPER SILLS AND OVERFLOW DRAIN RIMS SHALL BE 2" ABOVE PRIMARY ROOF DRAIN RIMS. COORDINATE AND VERIFY INSTALLATIONS.
- COORDINATE ROOF CURBS WITH HVAC EQUIPMENT.
- PROVIDE 1/2" WIDE GAP IN 2 x PARAPET NAILER AT ROOF CONTROL JOINT.
- ALL ROOF OPENINGS GREATER THAN 12"x12" SHALL BE FRAMED WITH STEEL ANGLES, RE: STRUCTURAL DRAWINGS.

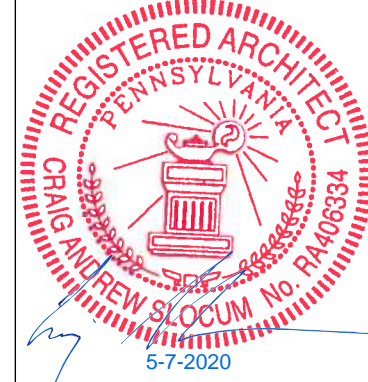

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79 SOUTH MAIN STREET

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CRAIG A. SLOCUM, ARCHITECT

## AGENCY SET

PROJECT	DATE
19176	05-07-2020
DRAWN	CHECKED
LMV	JSG / CAS

REVISED



SHEET TITLE

**ROOF PLAN**

SHEET


**A23**  
ORIGINAL SHEET SIZE  
24" x 36"



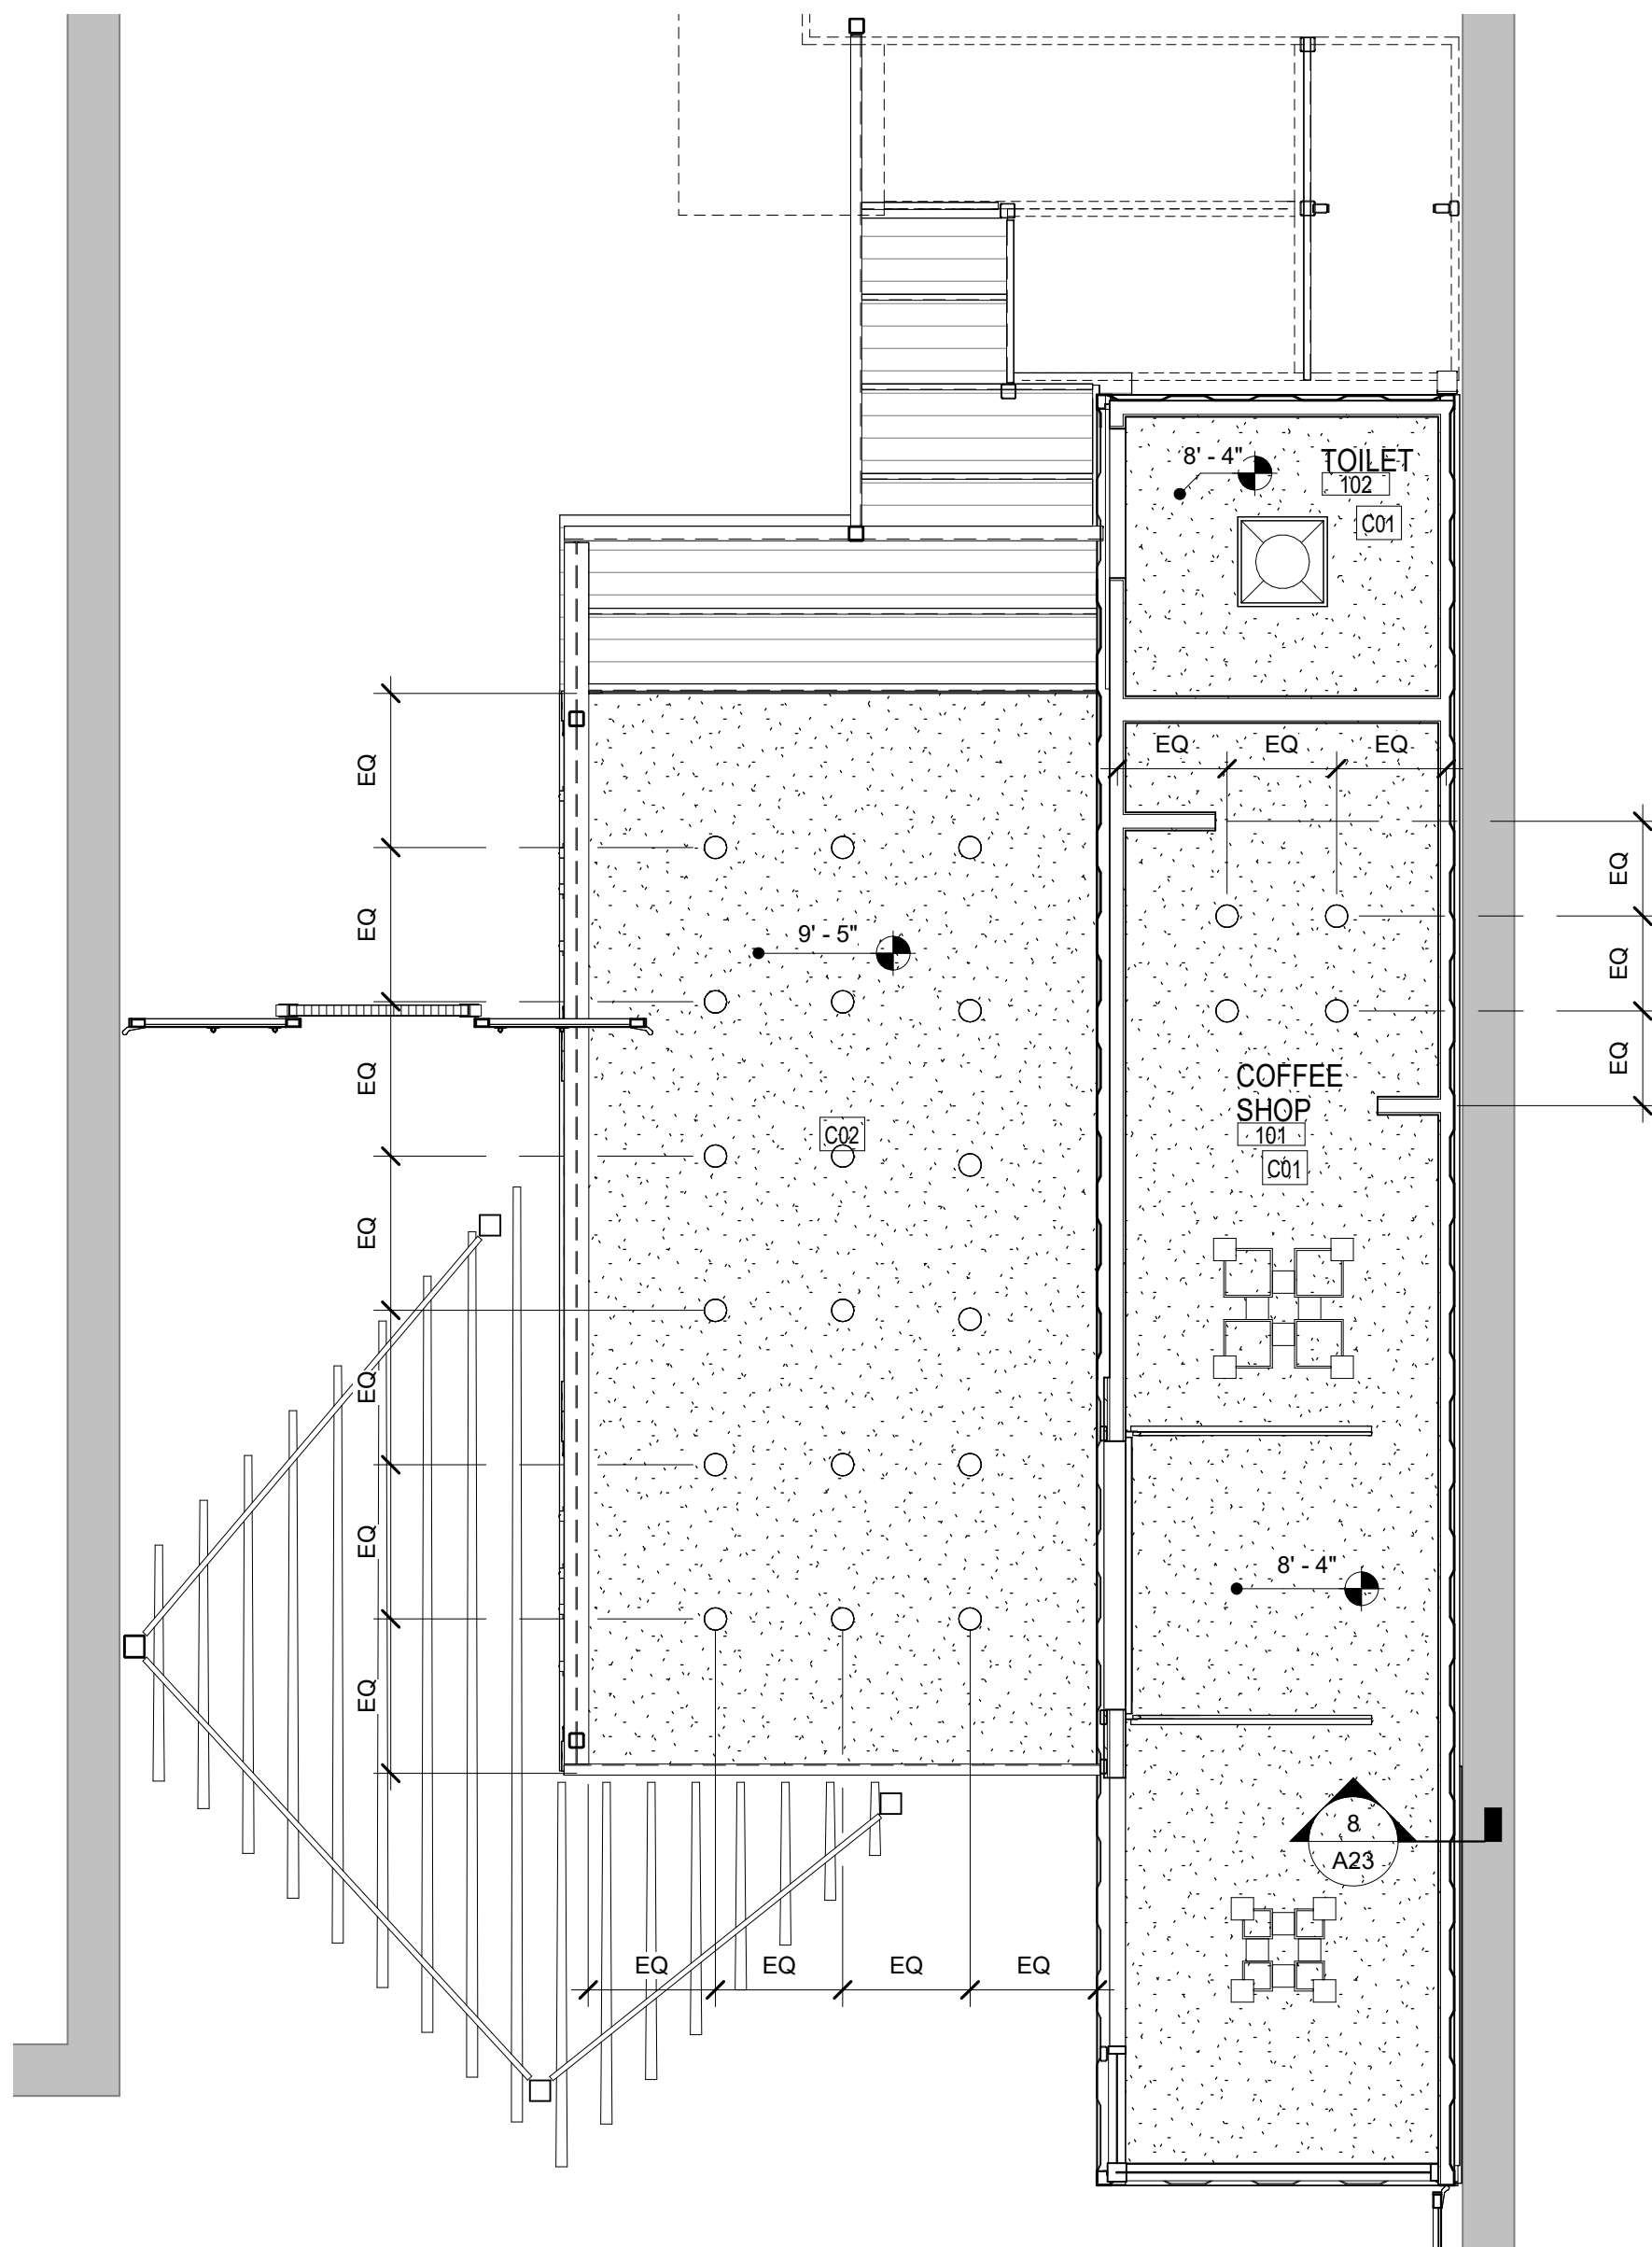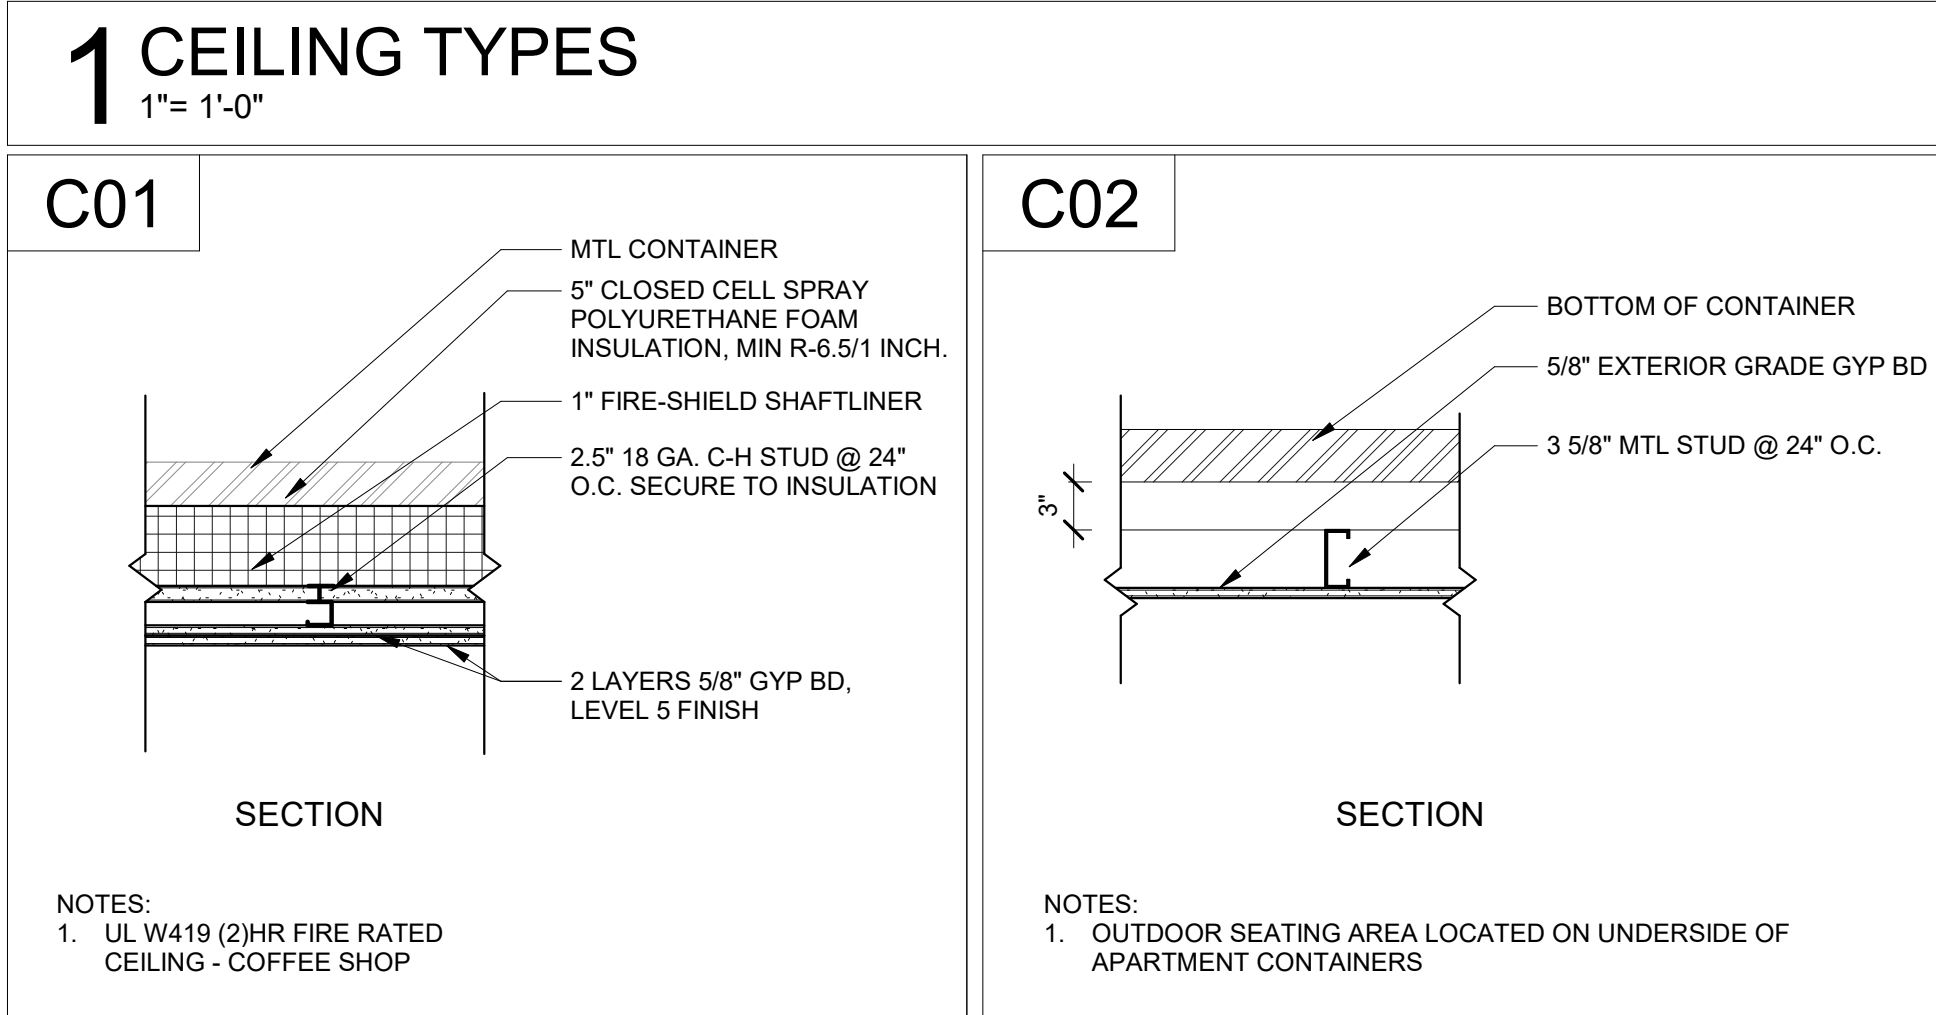

1 REFLECTED CEILING PLAN - LEVEL 1

1/4" = 1'-0"

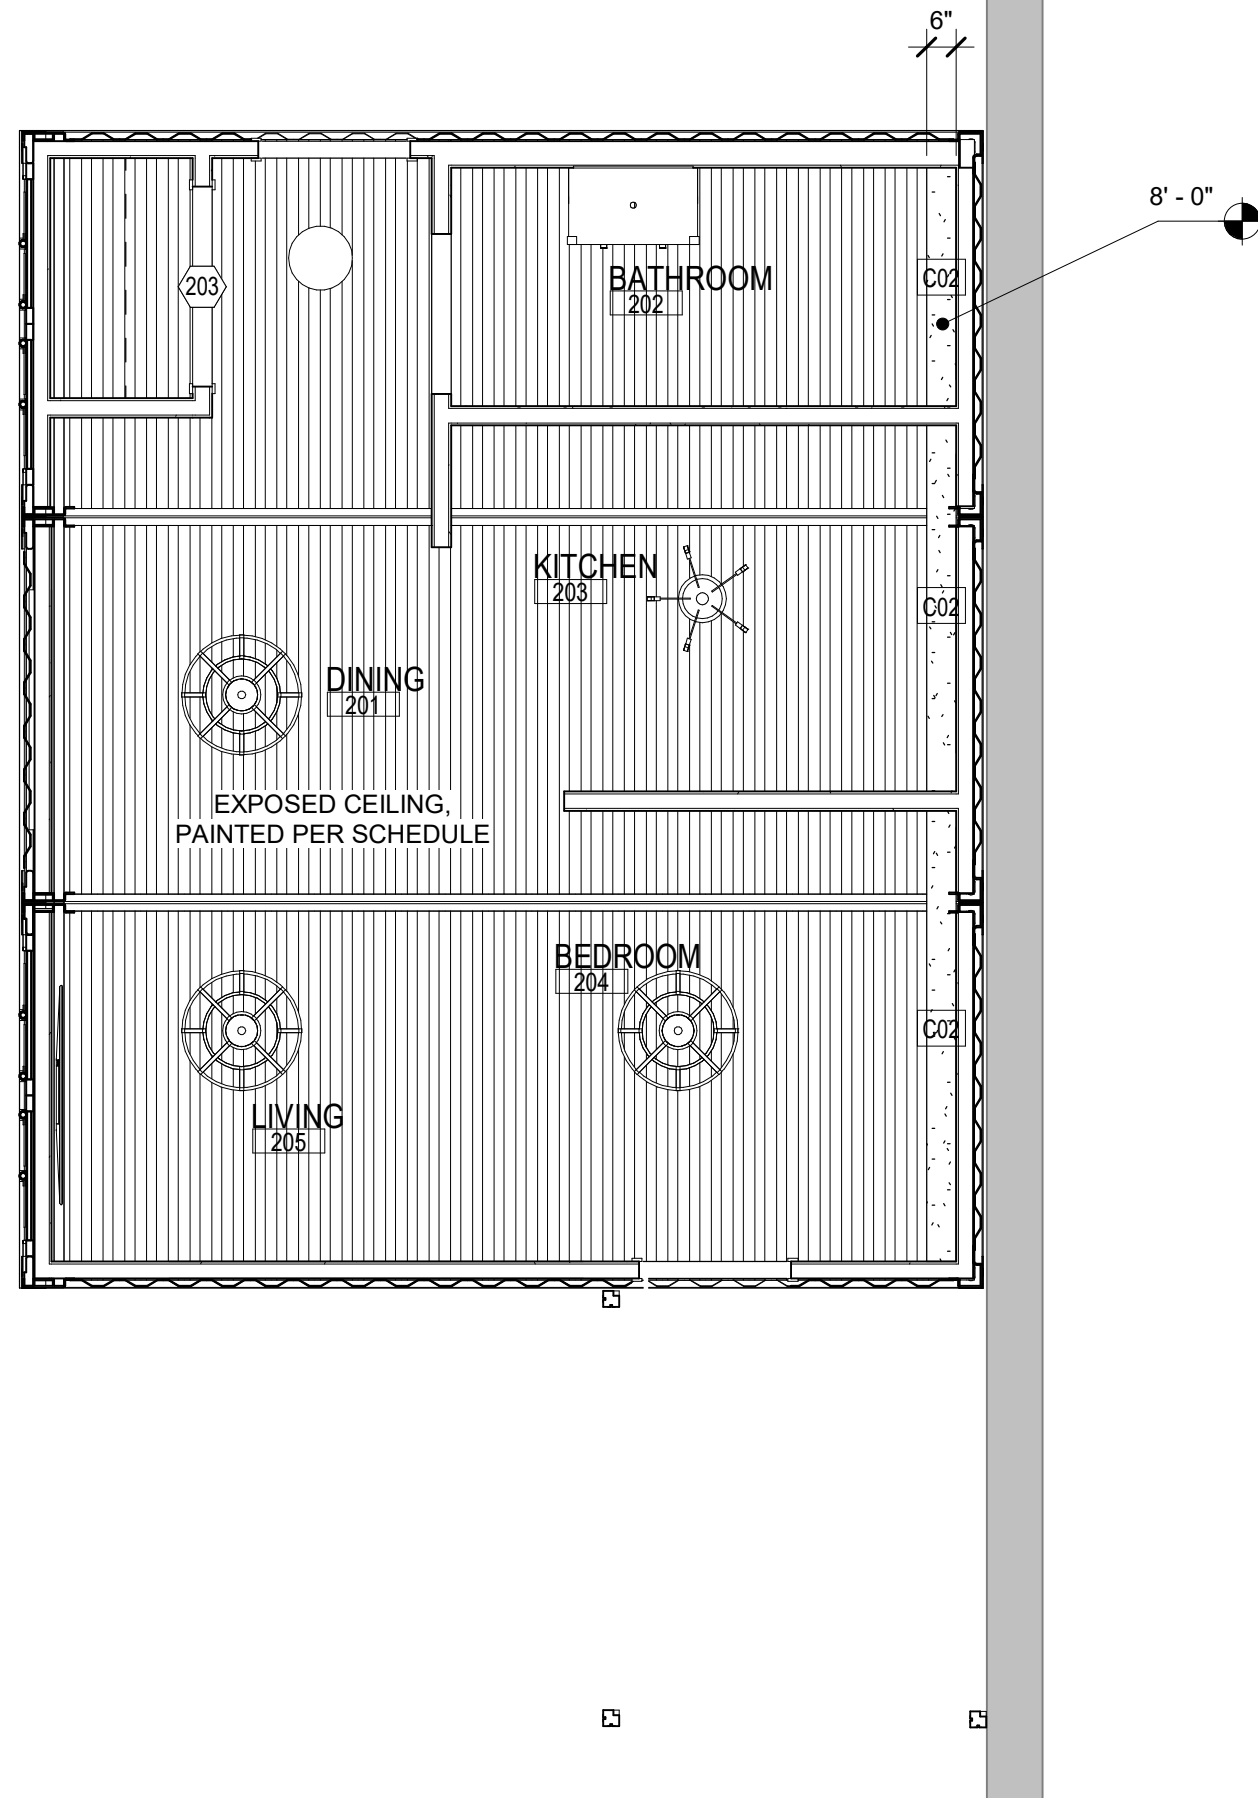

2 REFLECTED CEILING PLAN - LEVEL 2

1/4" = 1'-0"

LEGEND:

- MATERIAL DESIGNATION, RE: FINISH SCHEDULE I&J
- INDICATES FINISH CEILING OR SOFFIT HEIGHT ABOVE DATUM, FINISH FLOOR.
- GYPSON BOARD
- INDUSTRIAL CAGE CEILING FAN #FAC12005
- SHADES OF LIGHT MINIMALIST SPREAD CEILING LIGHT #FM18064 BZ
- SHADES OF LIGHT SIMPLY INDUSTRIAL WALL LIGHT #SC19154 IR
- MODERN RINGED LED CEILING LIGHT #FM16026 BK
- MID CENTURY MODERN CUBE LIGHT 28" W INTEGRATED LED FLUSHMOUNT LIGHTING IN BLACK, WHITE LIGHT #HL565180
- MID CENTURY MODERN CUBE LIGHT 37.5" W INTEGRATED LED FLUSHMOUNT LIGHTING IN BLACK, WHITE LIGHT #HL565180

GENERAL NOTES:

- A. CONTRACTOR TO VERIFY & COORDINATE DUCT LAYOUT WITH CURB AND ROOF PENETRATION LOCATIONS, REFER ALSO TO REFRIGERATION DRAWINGS FOR REFRIGERATION PIPING REQUIREMENTS AND COORDINATION.
- B. SEE STRUCTURAL FRAMING PLAN FOR ROOF DECK HEIGHTS TO ESTABLISH ROOF SLOPES AND ROOF MEMBER LOCATIONS.
- C. MAINTAIN ALL ROOF PENETRATIONS 3'-0" OR GREATER FROM FLOW LINES
- D. PREFABRICATED CURBS (FOR ROOF TOP MECHANICAL & REFRIGERATION EQUIPMENT SHALL BE INSTALLED BY GENERAL CONTRACTOR AND SET LEVEL.
- E. ALL DIMENSIONS ARE FOR GENERAL ARRANGEMENT & LOCATION ONLY. ACTUAL REQUIREMENTS & DIMENSIONS SHOULD BE VERIFIED AND COORDINATED WITH EQUIPMENT, SHOP DRAWING SUBMITTALS AND STRUCTURAL FRAMING.
- F. ALL PLANES OF ROOF SHALL SLOPE MIN. 1/4 "/L.F. TO DRAINS OR GUTTER, CW/ STRUCTURAL DRAWINGS
- G. NO PLUMBING VENTS OR EXHAUST UNITS WITHIN 10'-0" OF INTAKE OR 10'-0" OF EXTERIOR WALL.
- H. FABRICATE SHEET METAL CURB CAPS TO ALLOW FOR THICKNESS OF ROOFING PLY EXTENDING UP CURB FACE, RE: DETAILS
- I. SCUPPER SILLS AND OVERFLOW DRAIN RIMS SHALL BE 2" ABOVE PRIMARY ROOF DRAIN RIMS. COORDINATE AND VERIFY INSTALLATIONS.
- J. COORDINATE ROOF CURBS WITH HVAC EQUIPMENT.
- K. PROVIDE 1/2" WIDE GAP IN 2 x PARAPET NAILER AT ROOF CONTROL JOINT.
- L. ALL ROOF OPENINGS GREATER THAN 12"x12" SHALL BE FRAMED WITH STEEL ANGLES, RE: STRUCTURAL DRAWINGS.

### SHEET NOTES:



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CRAIG A. SLOCUM, ARCHITECT

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19176	05-07-2020
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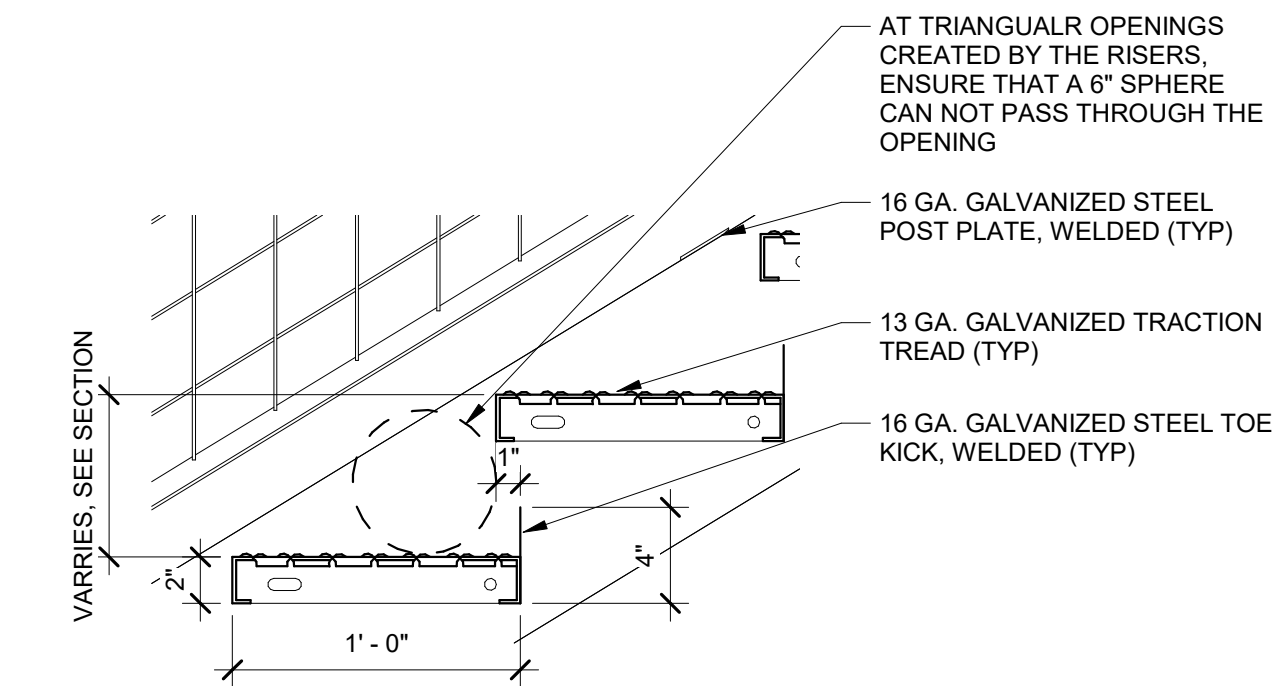
REFLECTED  
CEILING  
PLANS

SHEET


A31

ORIGINAL SHEET SIZE  
24" x 36"







3 TREAD DETAIL - STAIR SECTION  
1 1/2" = 1'-0"

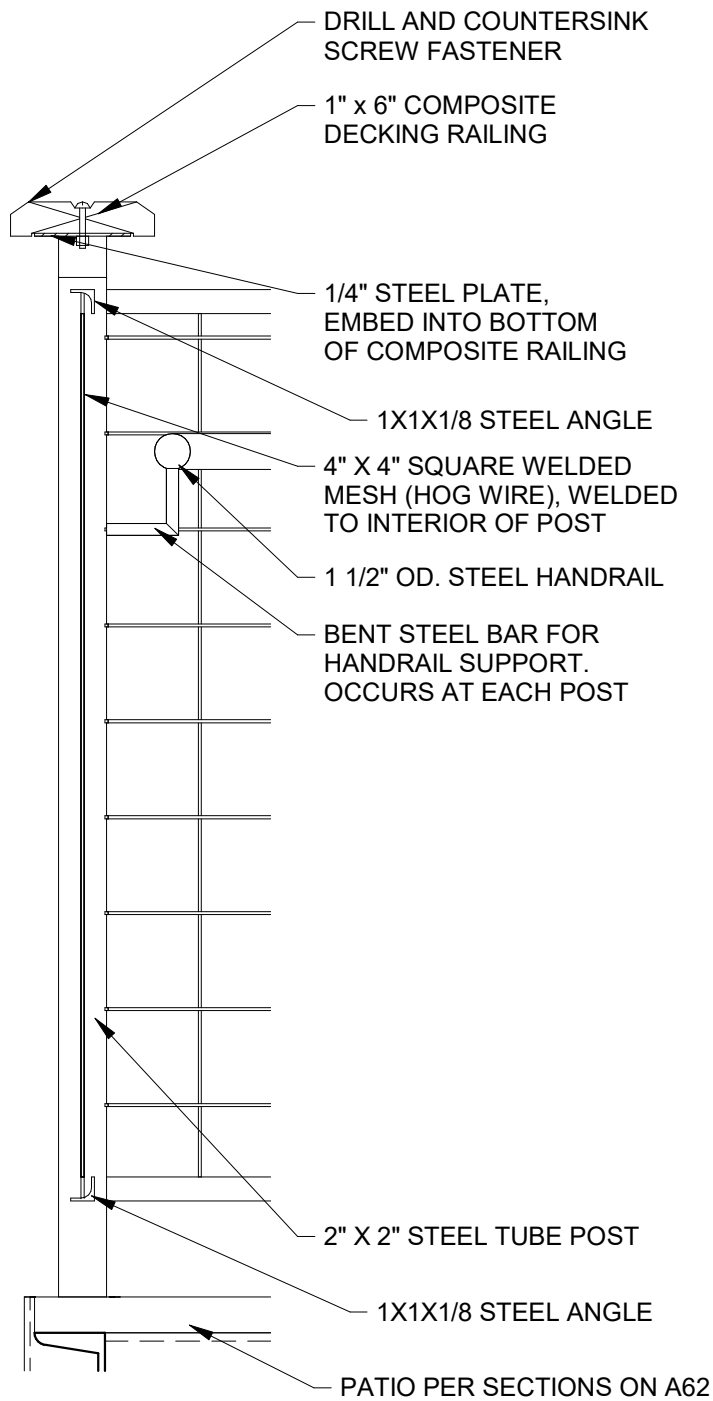


2 TYP RAILING DETAIL  
1 1/2" = 1'-0"

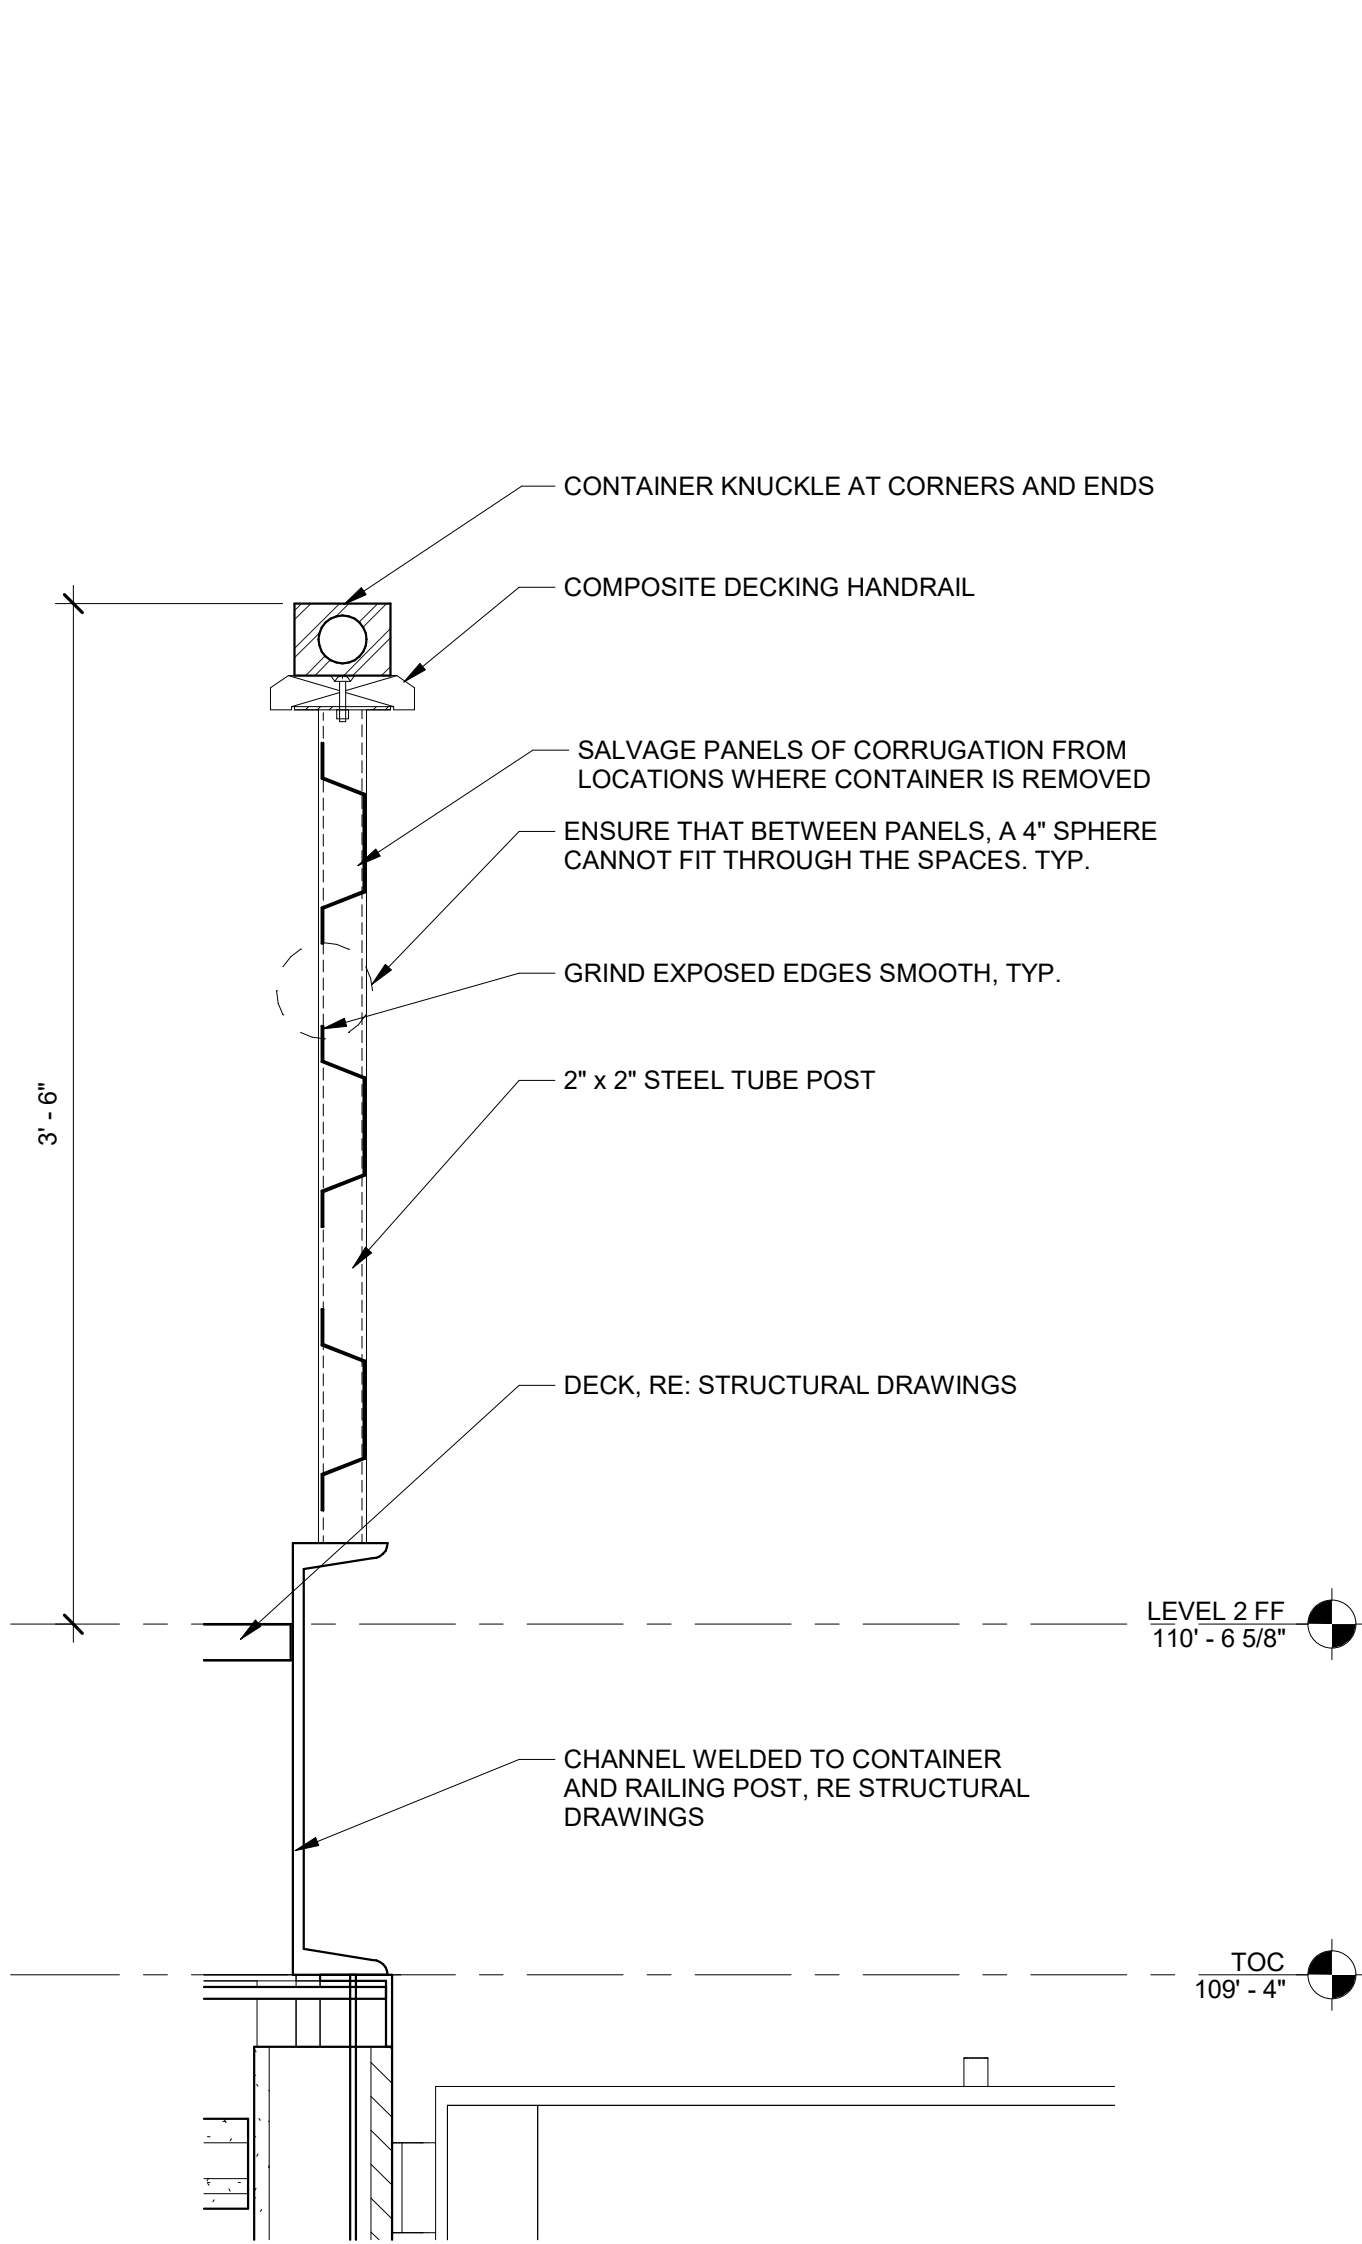

5 FRONT RAILING SECTION  
1 1/2" = 1'-0"

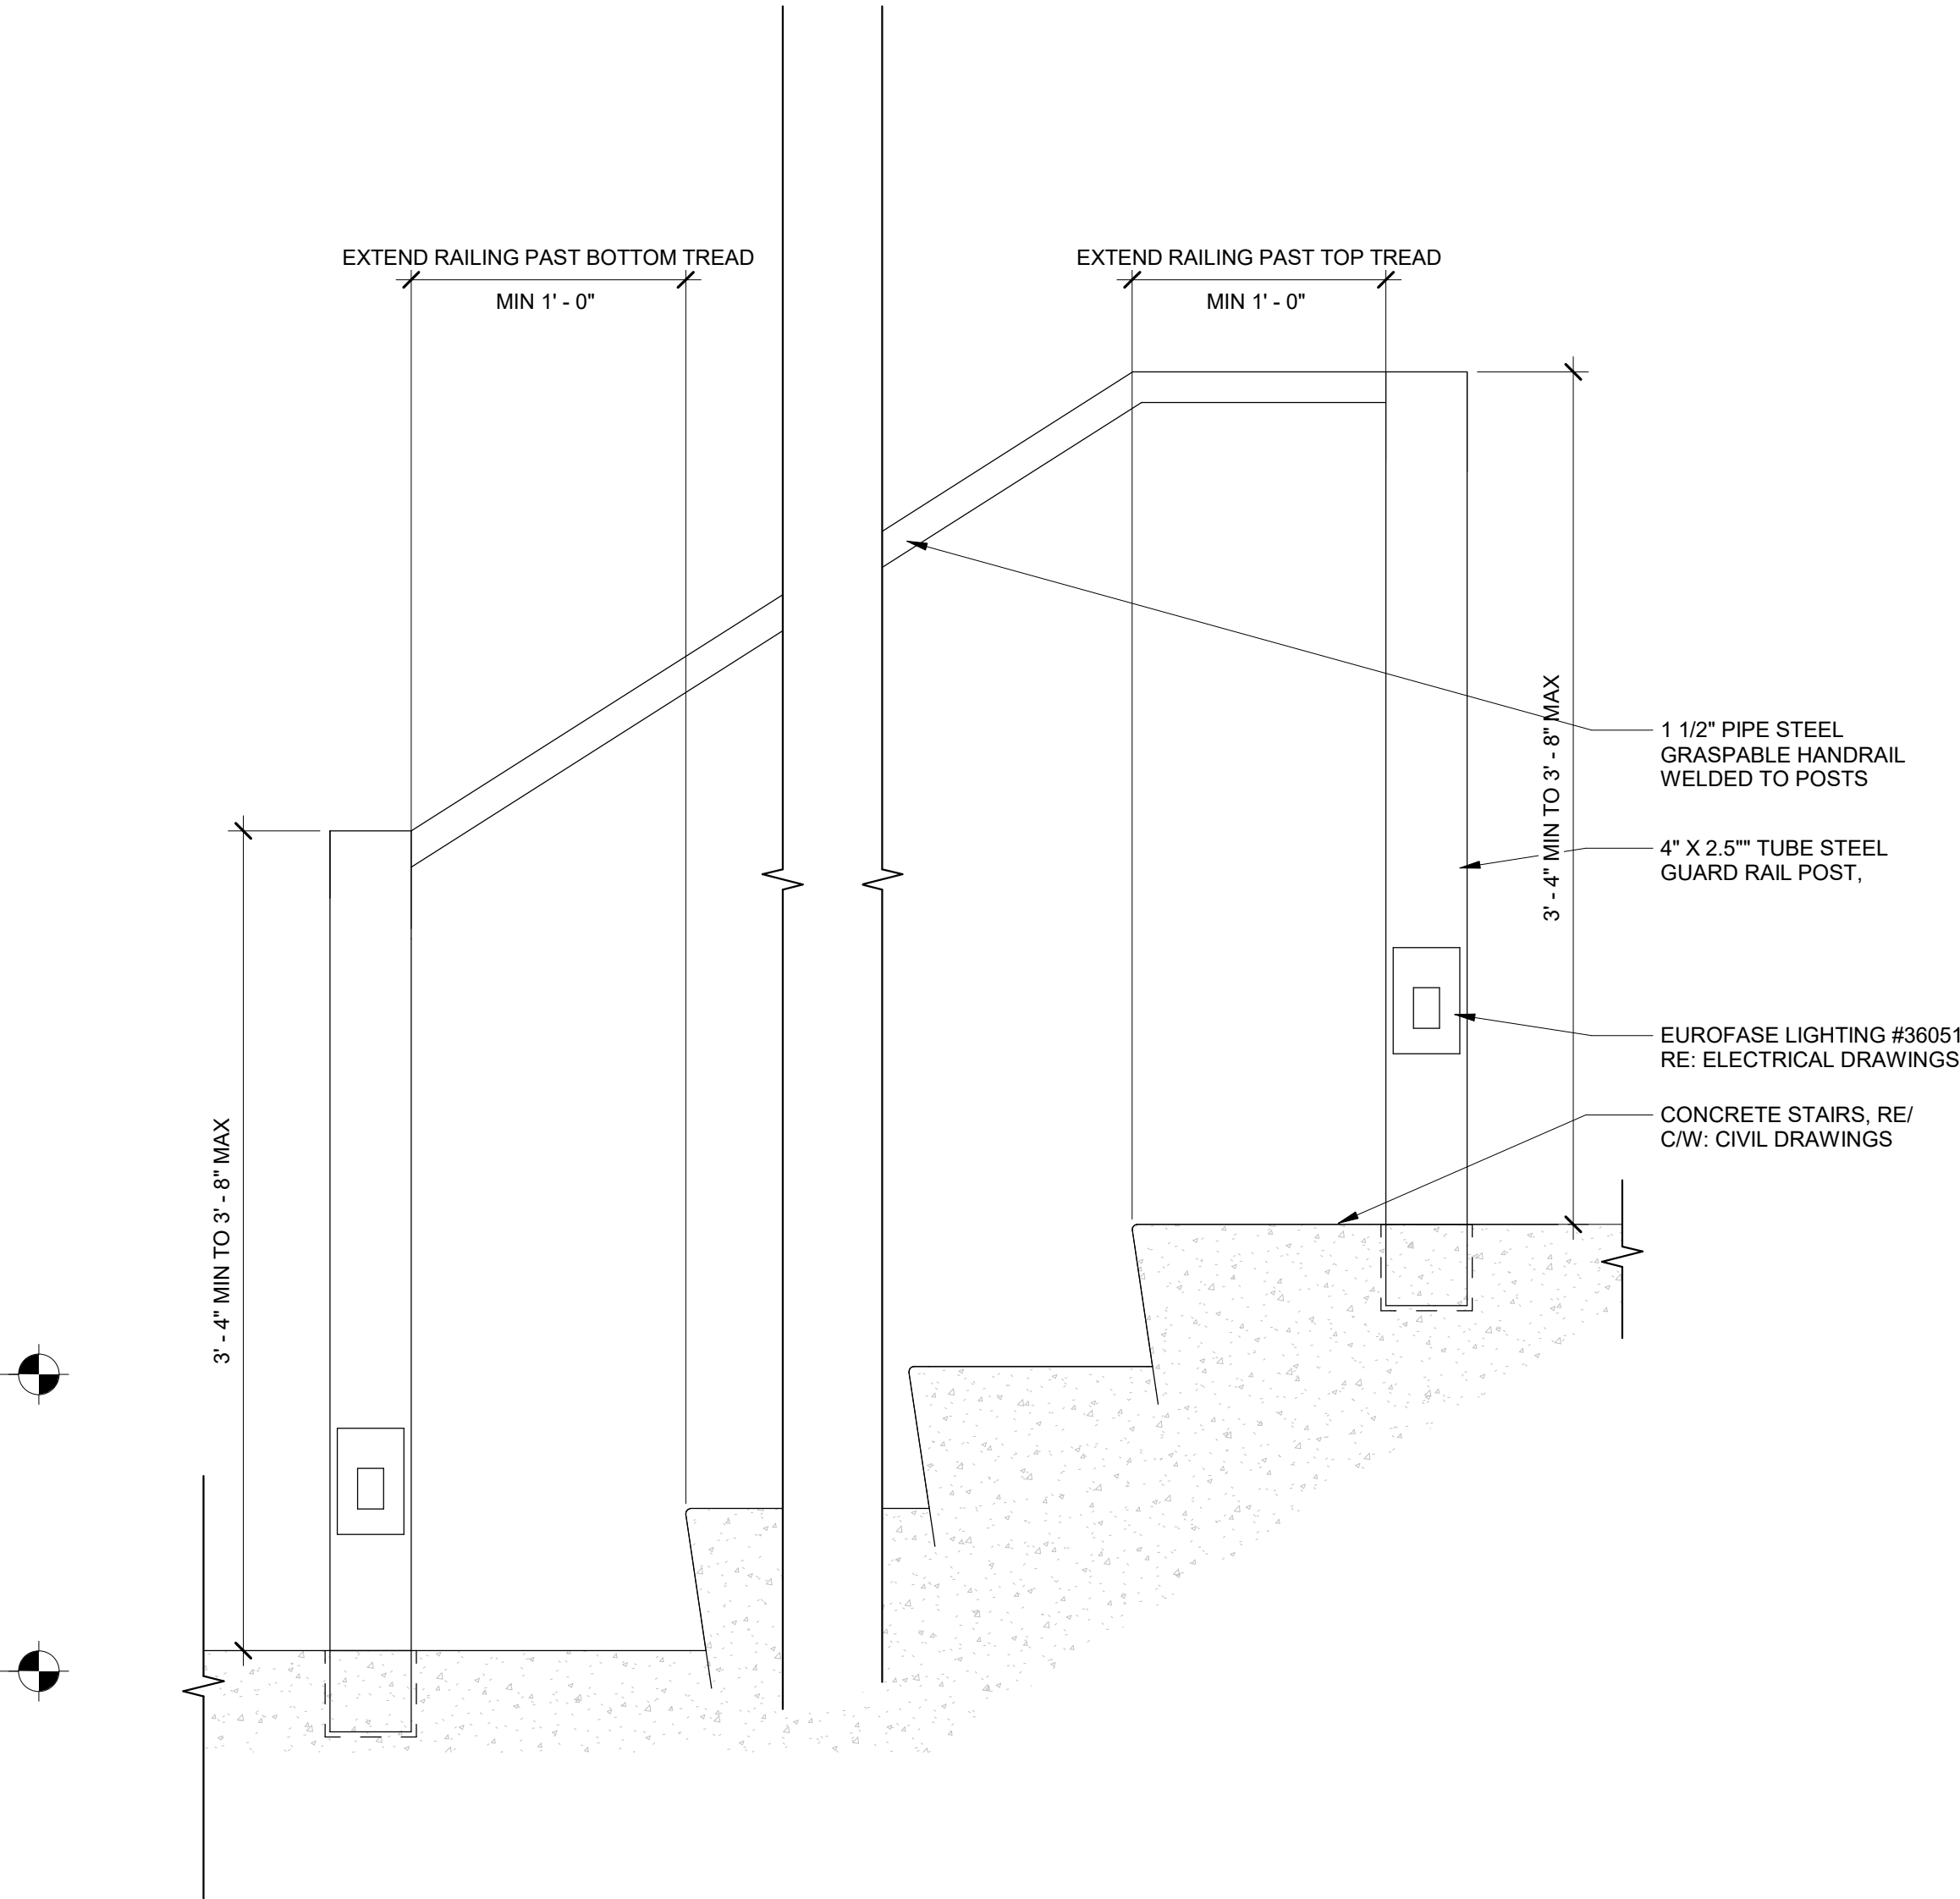

4 CONCRETE STAIR RAILING DETAIL  
1 1/2" = 1'-0"

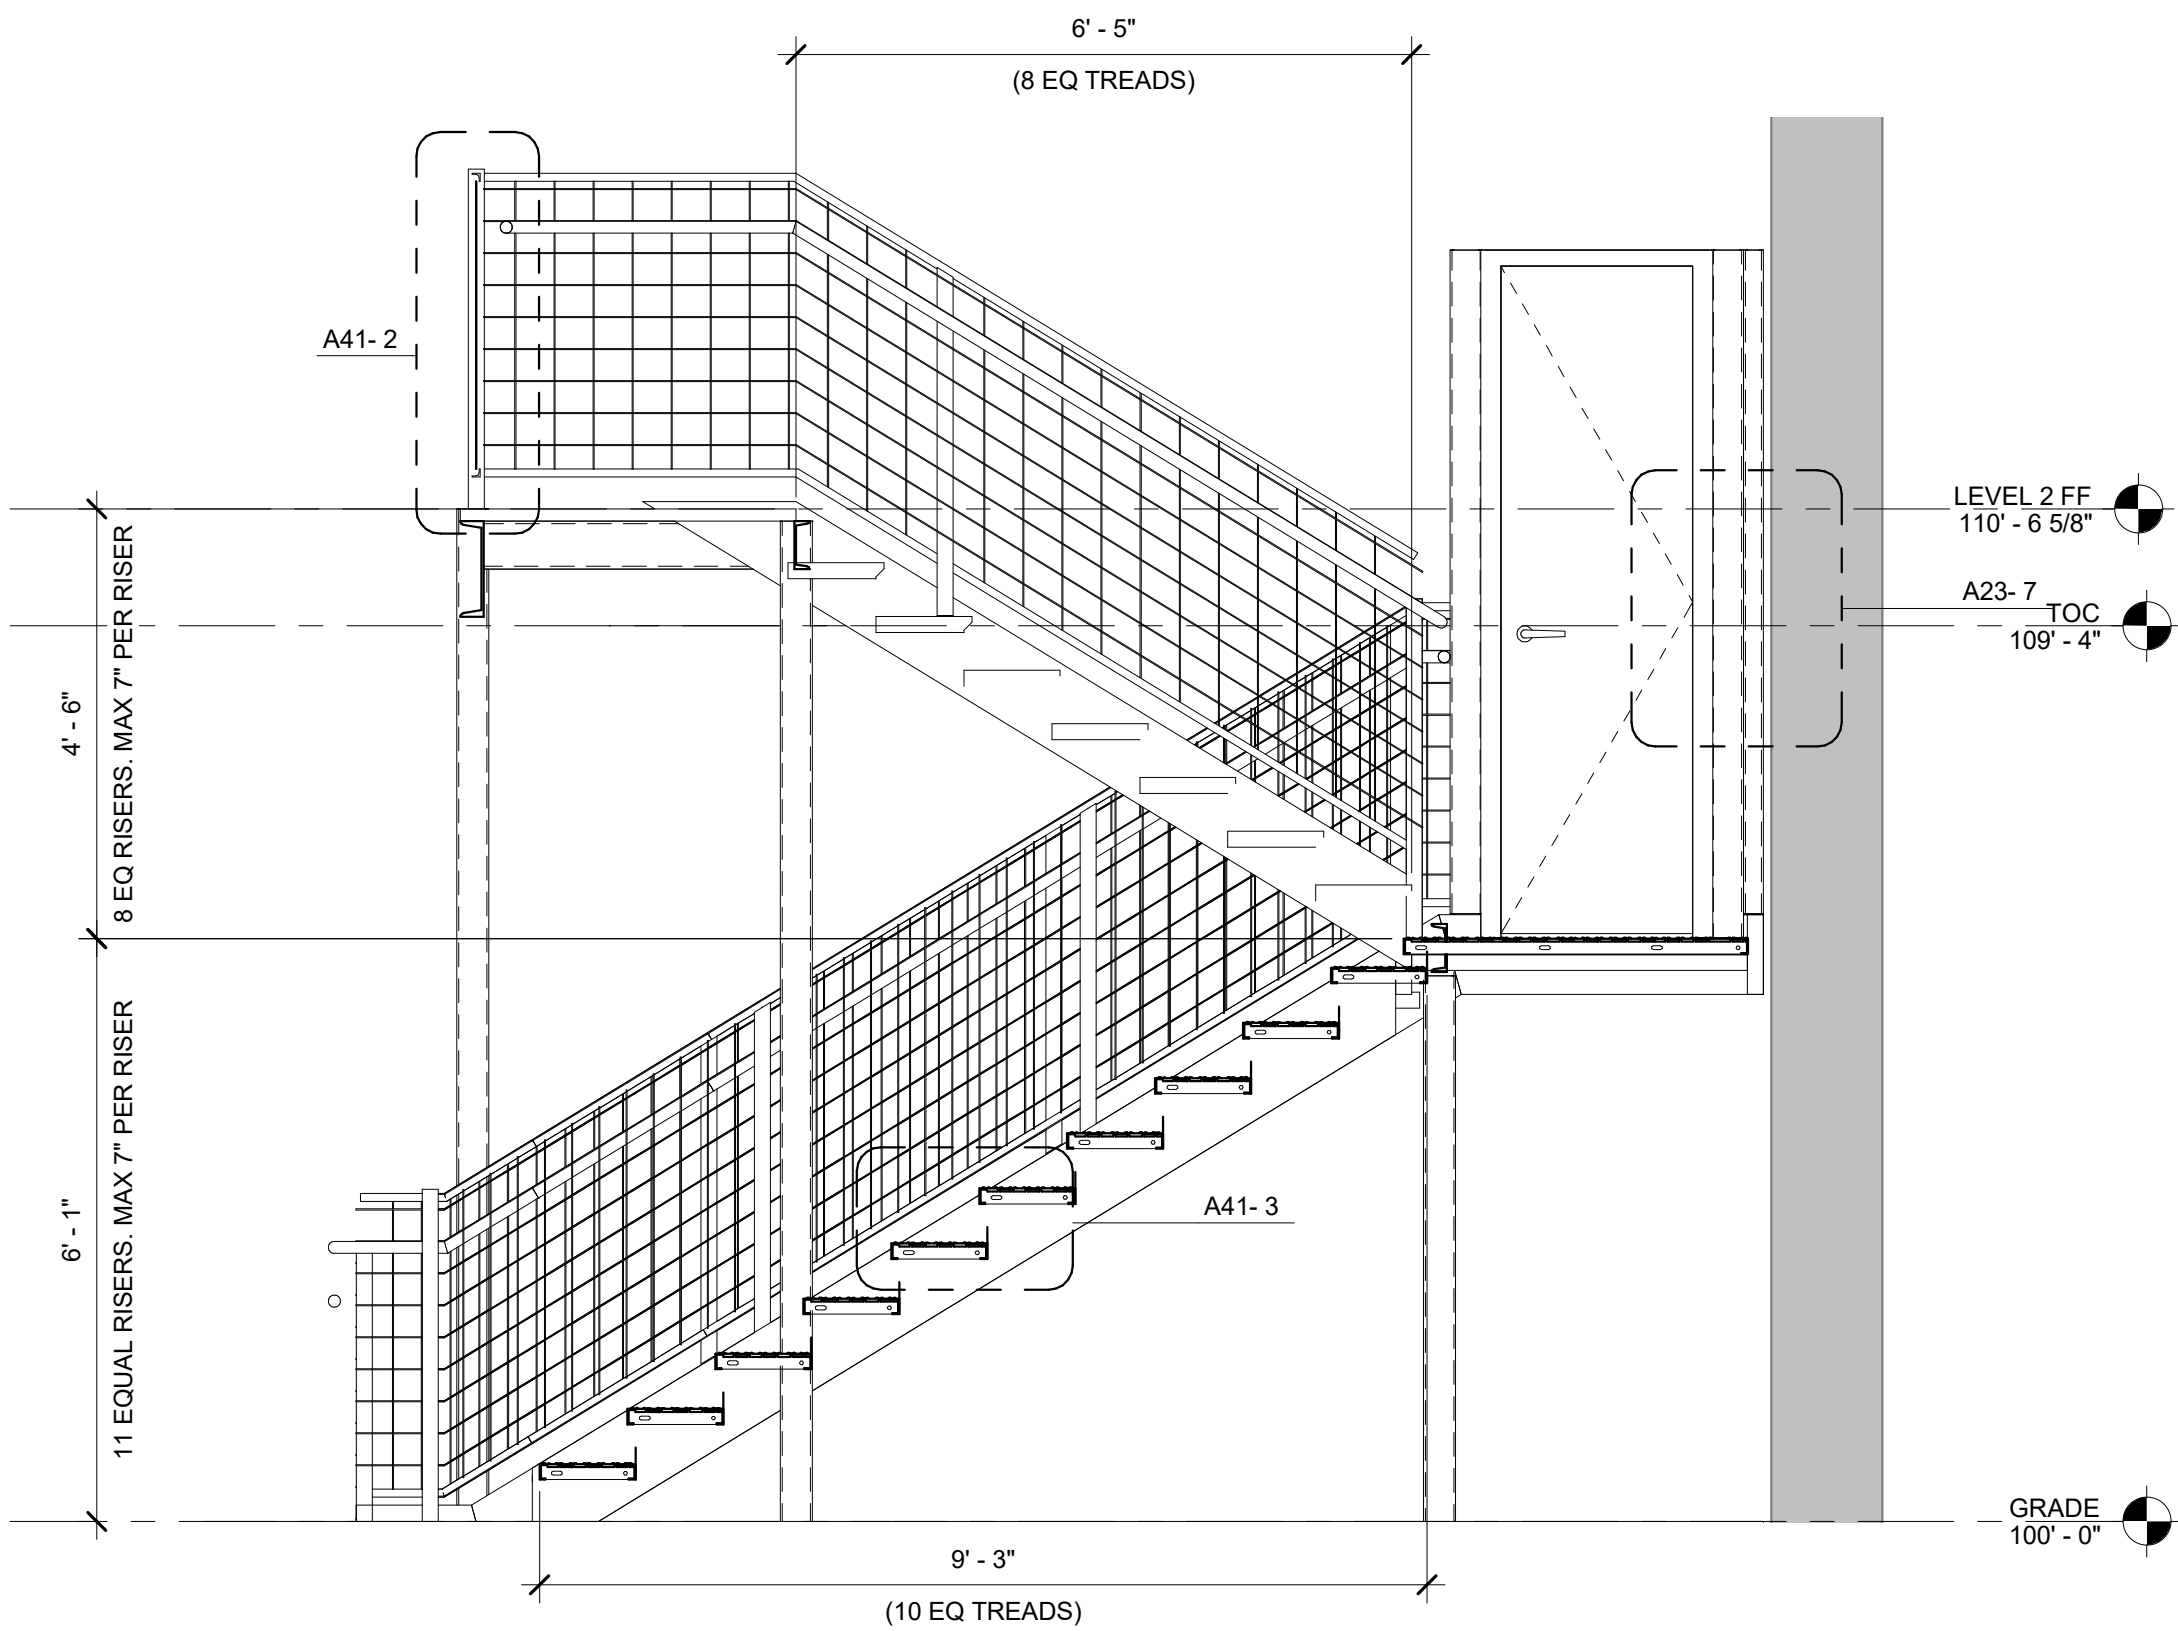


1 STAIR SECTION  
1/2" = 1'-0"

LEGEND:

GENERAL NOTES:

- A. DIMENSION IS NOT SHOWN ON INTERIOR SHEETS UNLESS INTERIOR SPECIFIC. REFER ARCHITECTURAL DRAWINGS FOR DIMENSIONS.
- B. FIELD VERIFY ALL DIMENSIONS PRIOR TO FABRICATION / ORDERING.

## ### SHEET NOTES:

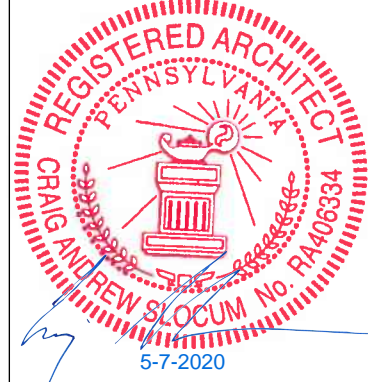

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**CONTAINER COFFEE SHOP**  
79 SOUTH MAIN STREET  
PITTSBURGH, PA

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AGENCY SET

PROJECT	DATE
19176	05-07-2020
DRAWN	CHECKED
LMV	JSG / CAS

REVISED


SHEET TITLE  
**VERTICAL CIRCULATION**

SHEET


**A41**  
ORIGINAL SHEET SIZE  
24" x 36"




3 COFFEE SHOP EQUIPMENT PLAN  
1/2" = 1'-0"

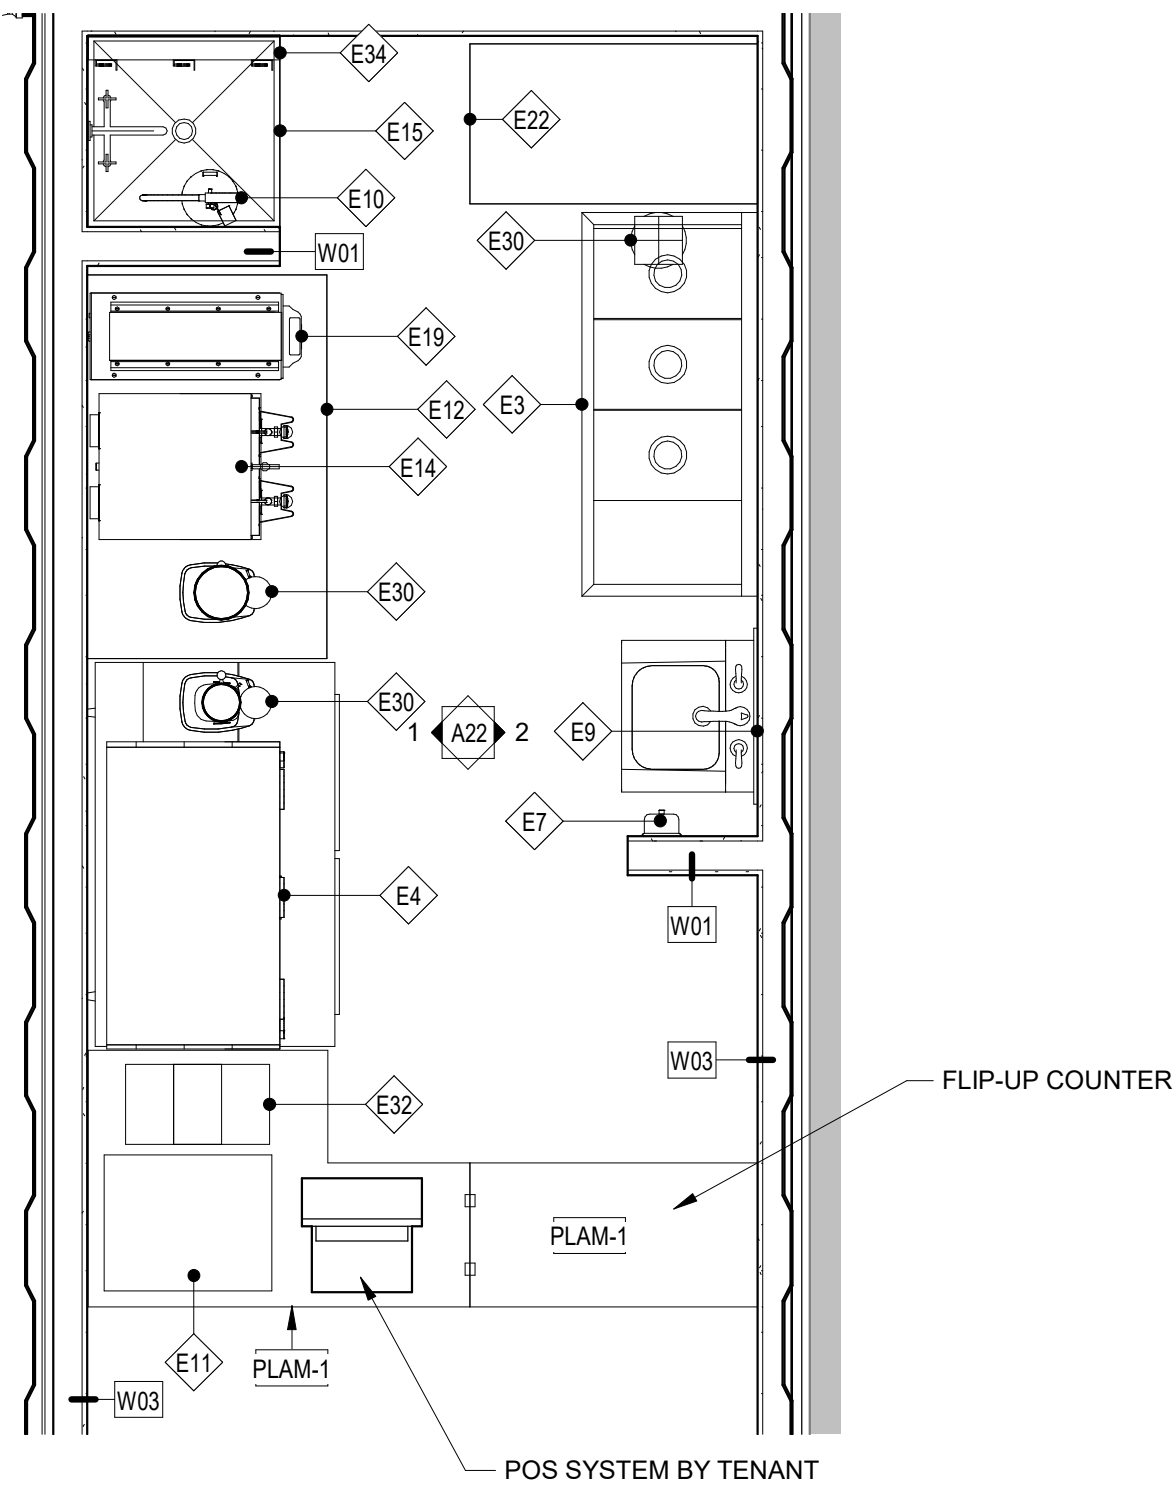


2 COFFEE SHOP TOILET 102 + MOP SINK  
1/2" = 1'-0"

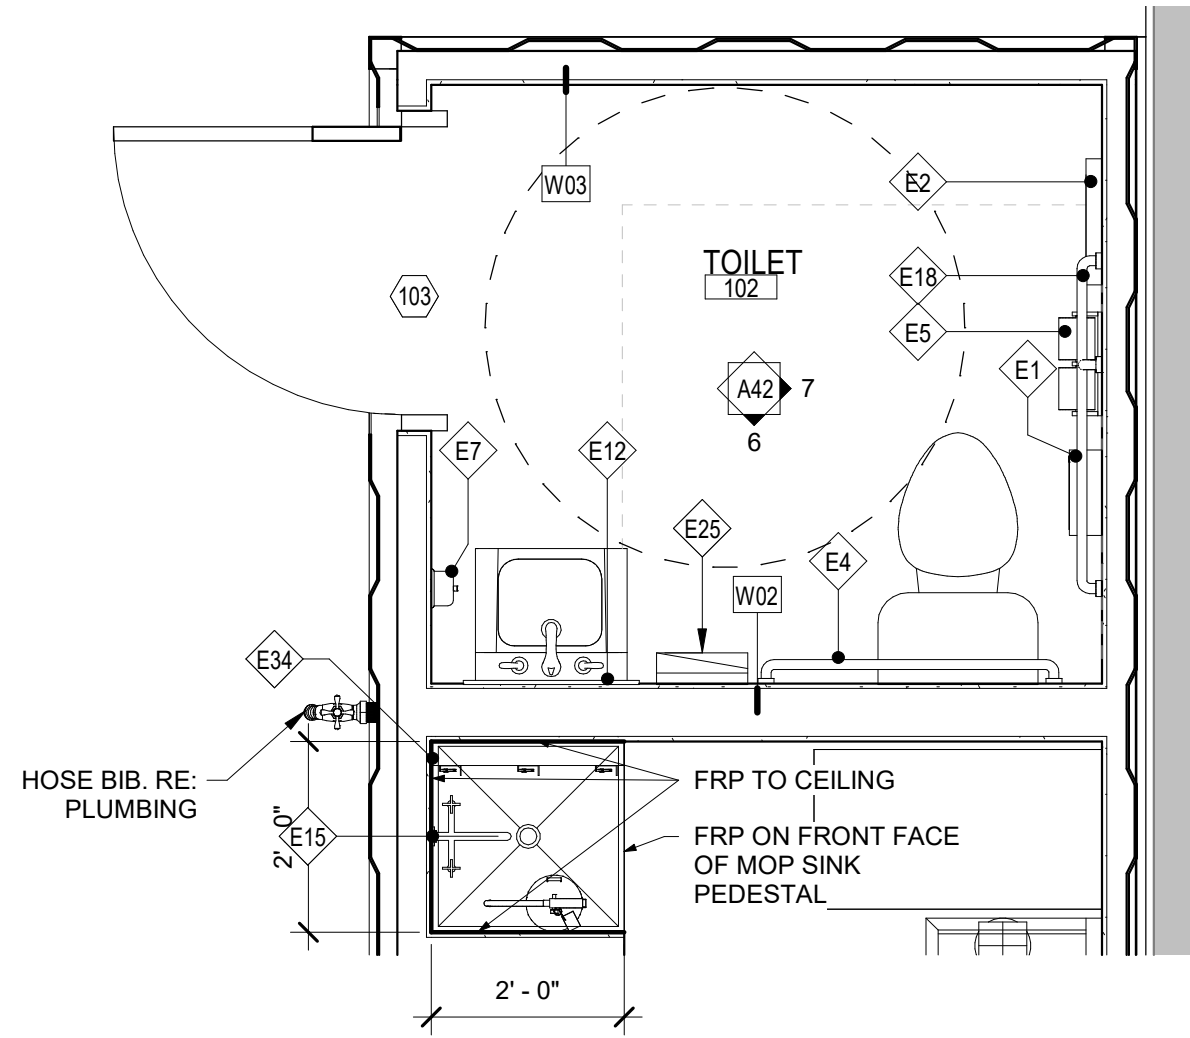


4 APARTMENT RR TUB WALL  
1/2" = 1'-0"

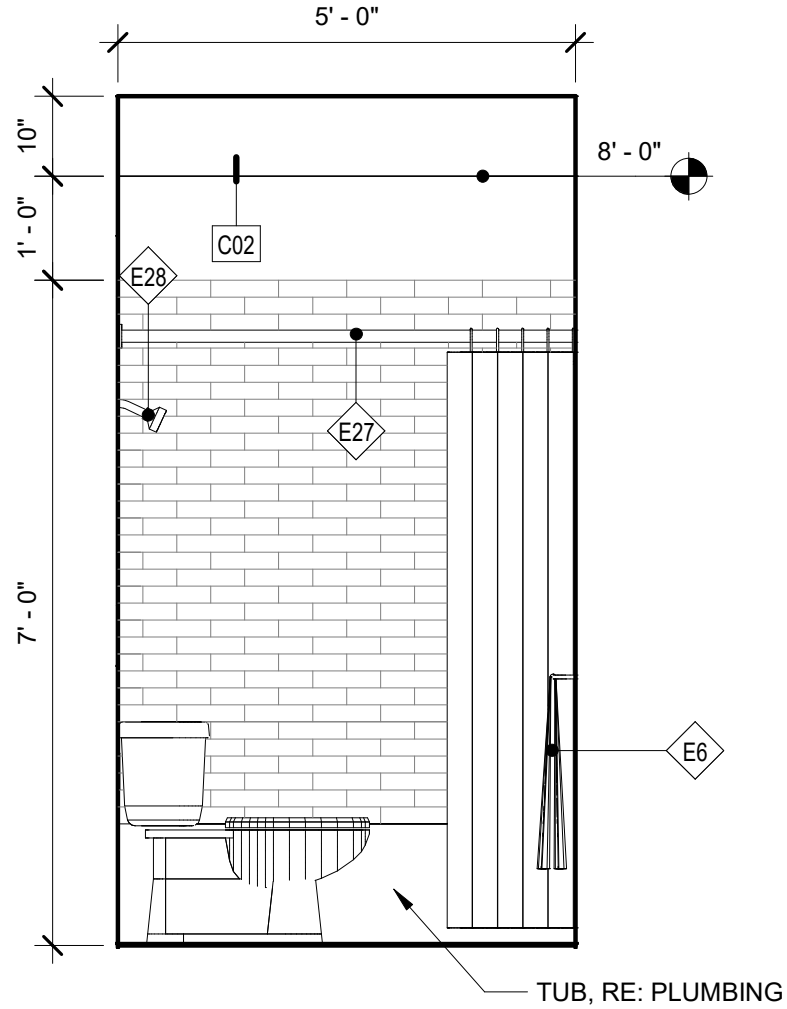

5 APARTMENT RESTROOM WET WALL  
1/2" = 1'-0"

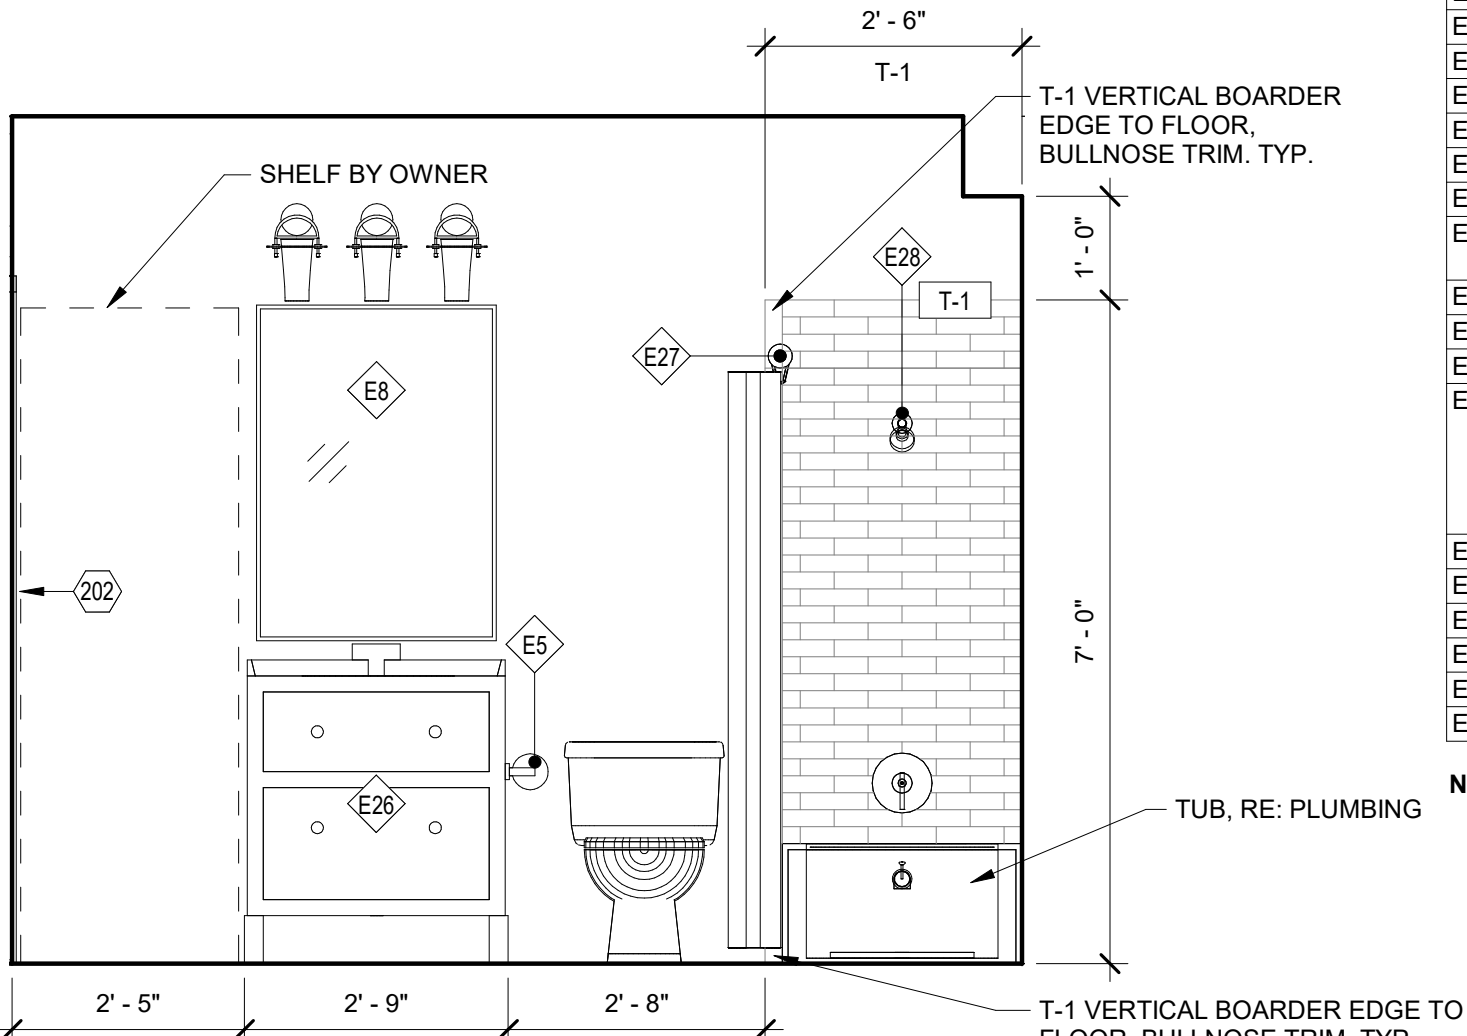


NOTE: BATHROOM HARDWARE (APARTMENT): ALTERNATES MAY BE SELECTED UPON ARCHITECT APPROVAL

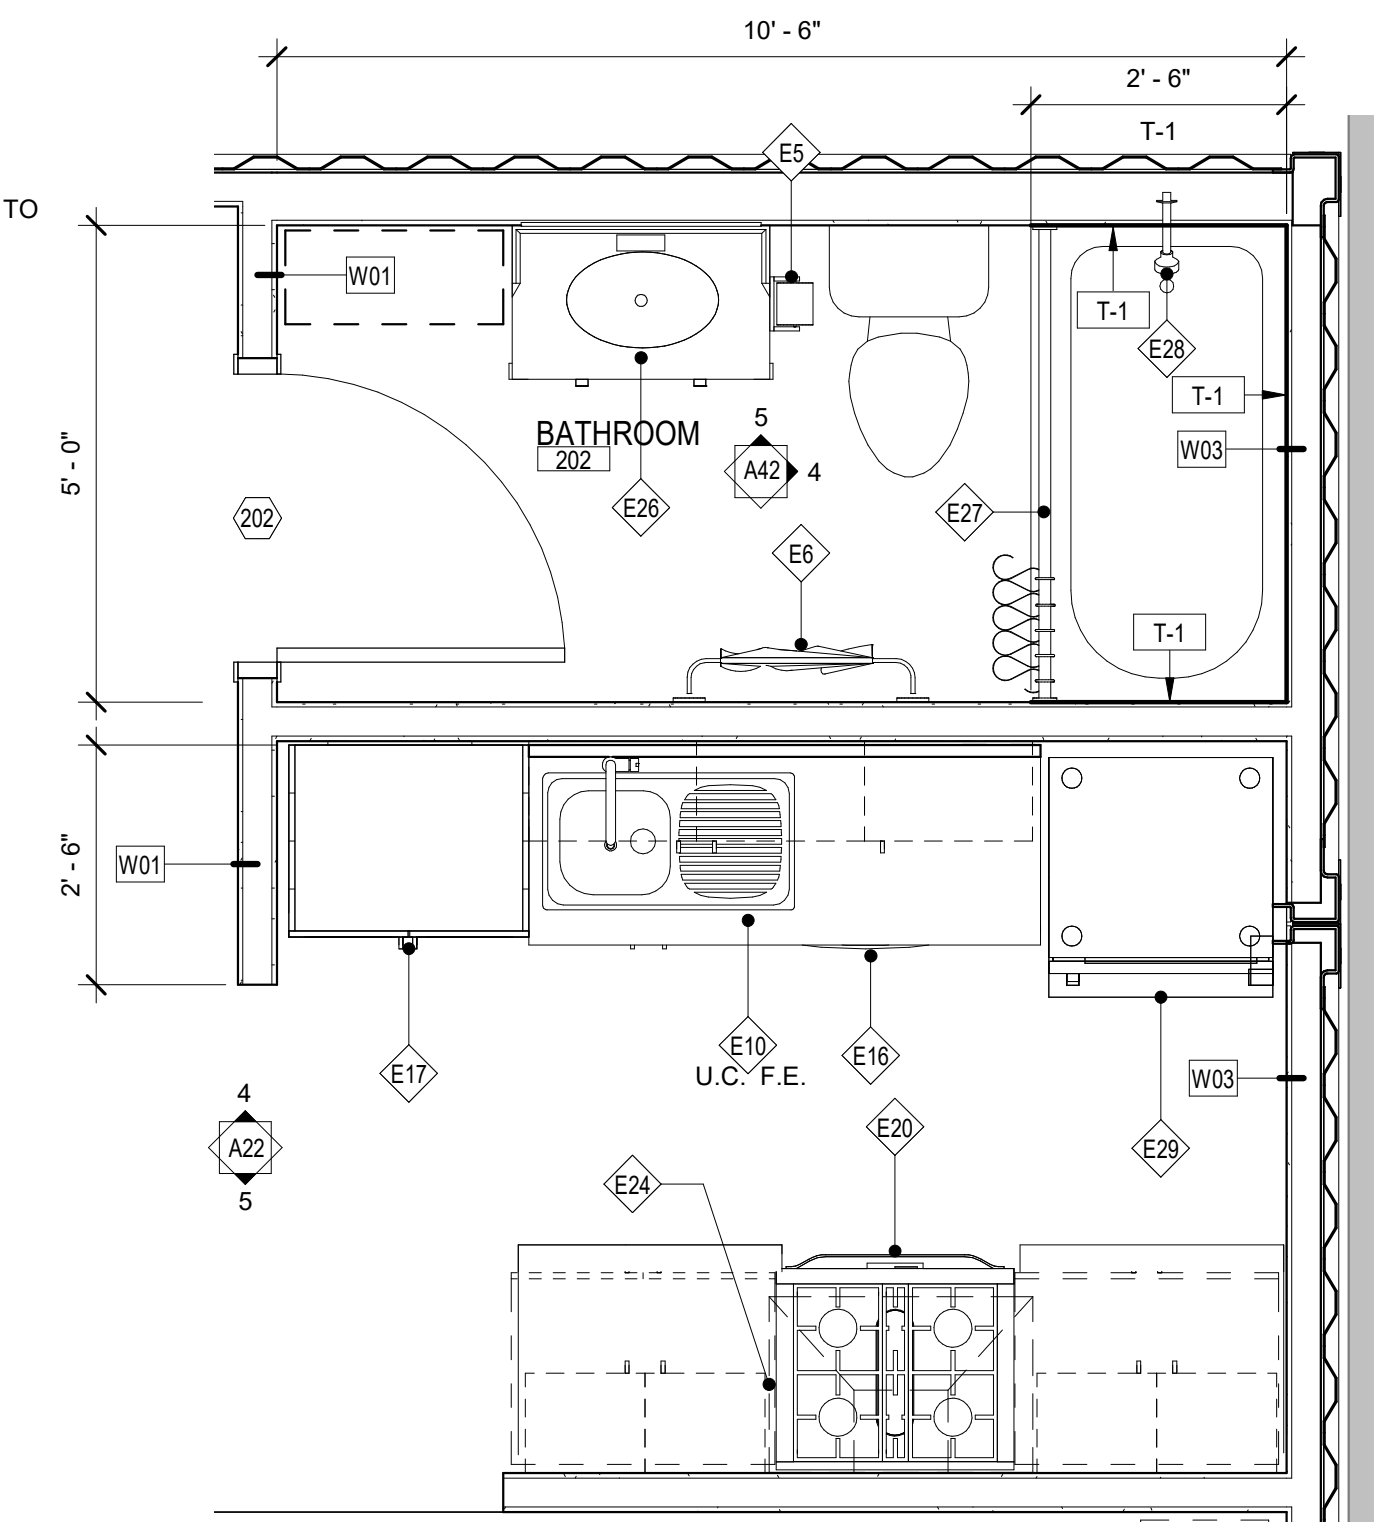


1 APARTMENT RESTROOM / KITCHEN  
1/2" = 1'-0"


8 MOUNTING HEIGHTS  
1/4" = 1'-0"

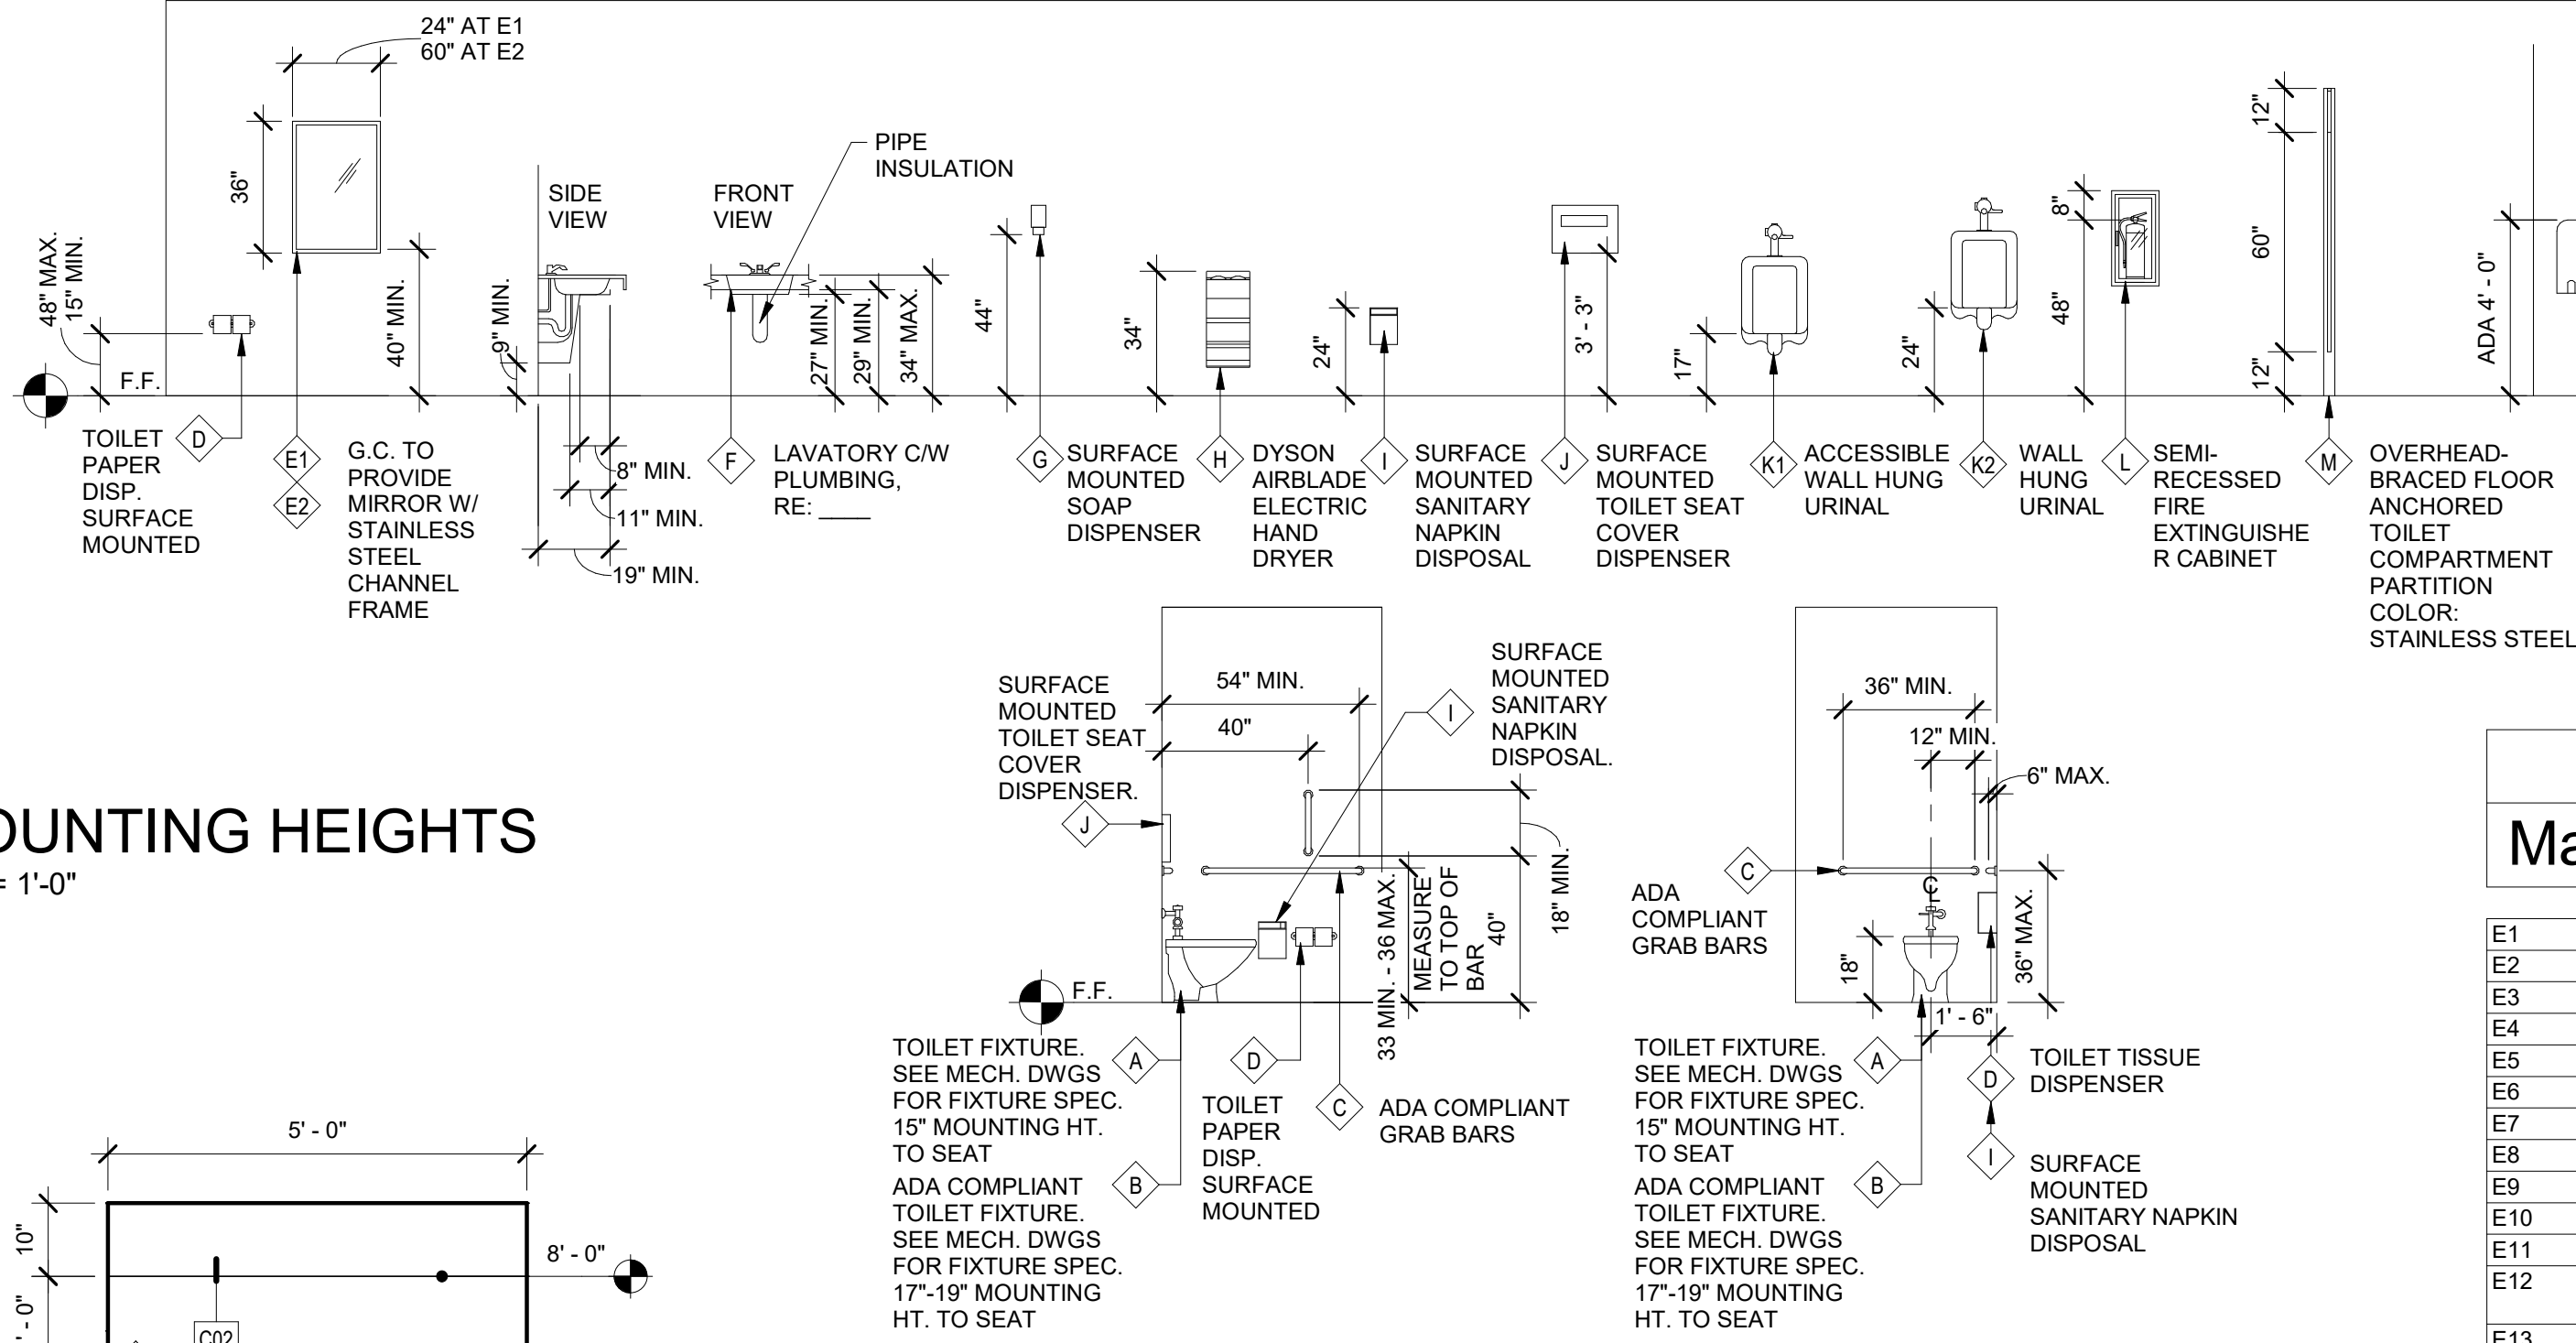

6 TOILET 102 WET WALL  
1/2" = 1'-0"

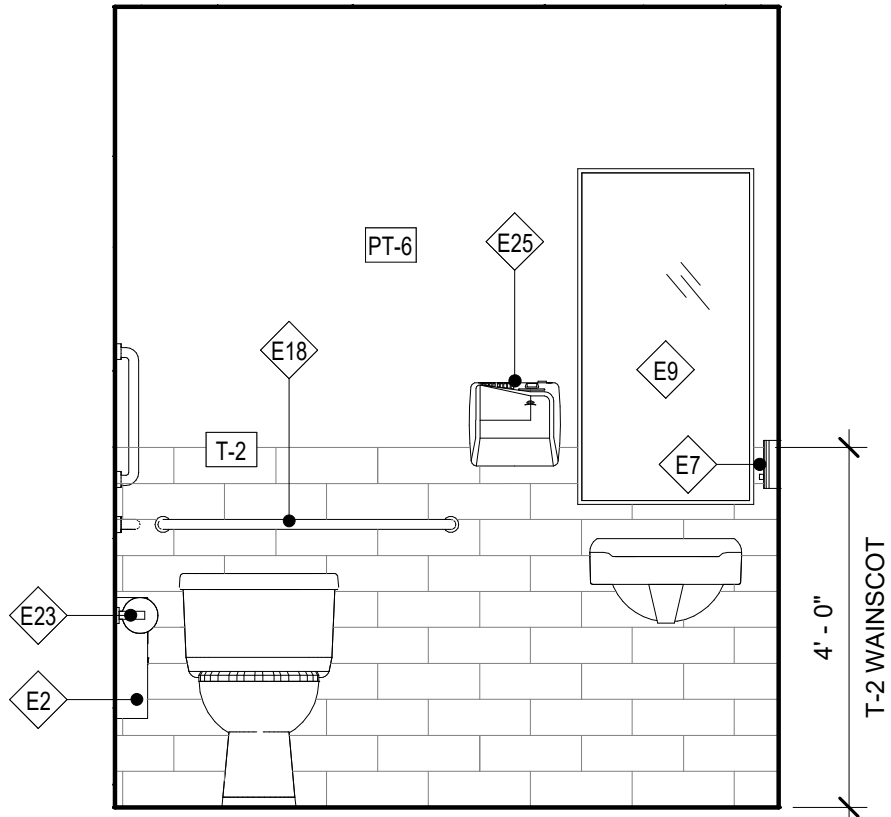

7 TOILET 102 SIDE WALL  
1/2" = 1'-0"

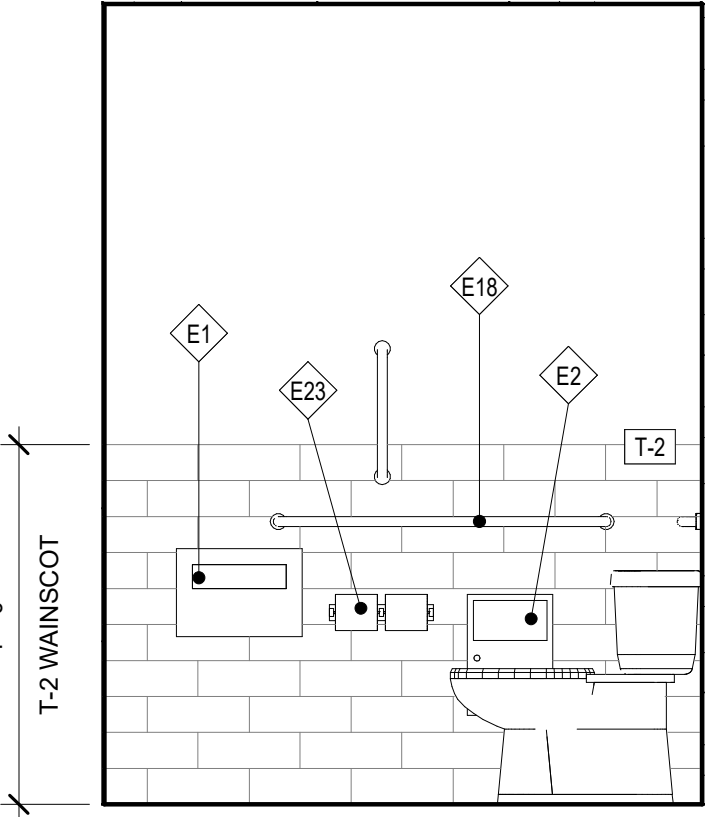

Specialty Equipment Schedule				
Mark	Description	Manufacturer	Model	Comments
E1	SEAT COVER DISPENSER	BOBRICK	B-5221	
E2	SANITARY NAPKIN DISPOSAL	BOBRICK	B-35139	
E3	3 COMP SINK			
E4	ESPRESSO MACHINE			
E5	TOILET PAPER DISPENSER	BOBRICK	B-685	
E6	TOWEL RACK	BOBRICK	B676 X 24	
E7	SOAP DISPENSER	BOBRICK	B-2012	
E8	MEDICINE CABINET MIRROR	BOBRICK	B-398	
E9	MIRROR	BOBRICK	B-165	
E10	FIRE EXTINGUISHER			MIN 2A RATING
E11	PASTRY DISPLAY CASE			
E12	STAINLESS STEEL ROLLING PREP TABLE 48" X 30"			
E13	COOLER			
E14	COFFEE MAKER			
E15	MOP SINK			
E16	DISHWASHER			
E17	MICROWAVE			
E18	ADA COMPLIANT GRAB BAR SET	BOBRICK		
E19	COFFEE GRINDER			
E20	RANGE / OVEN			
E21	TV			
E22	STAINLESS STEEL ROLLING PREP TABLE 36" X 18"			
E23	TOILET PAPER DISPENSER	BOBRICK	B-697	
E24	VENT HOOD			
E25	HAND DRYER	BOBRICK	B-7128	
E26	SINK CABINET WITH 2 DRAWERS, GRAY, 32-1/2" X 19-1/4" X 35"	IKEA	HEMNES / RATTVIKEN	PROVIDE BLOCKING IN WALL AS NEEDED. FAUCET TO BE IKEA RUNSKAR BATH FAUCET WITH STRAINER, CHROME PLATED
E27	SHOWER CURTAIN ROD		B-207 X 60	
E28	SHOWER HARDWARE			
E29	REFRIGERATOR			CFCI
E30	FLOOR DRAIN			RE: PLUMBING
E32	SYRUP HOLDER			
E34	MOP AND BROOM HOLDER	BOBRICK	B-223 X 24	

### GENERAL NOTES:

- FINISH FLOOR ELEVATION (100.00) IS FOR REFERENCE ONLY. SEE SEPARATE BOUND CIVIL SET FOR ACTUAL FLOOR ELEVATION.
- ALL WALL DIMENSIONS ARE TO FACE OF STUD AND/OR NOMINAL FACE OF MASONRY.
- PROVIDE BLOCKING WHERE REQUIRED FOR FIXTURE INSTALLATION. COORDINATE WITH FIXTURE INSTALLER FOR MOUNTING HEIGHTS.
- BRACE WALLS THAT DO NOT EXTEND TO STRUCTURE WITH 3 5/8" METAL STUD DIAGONAL BRACE AT 48" O.C., ANCHOR TO BOTTOM FLUTE OF ROOF DECKING AND AT TOP TRACK OF PARTITION WALL. BRACES TO BE CONCEALED WHENEVER POSSIBLE.
- PROVIDE 5/8" GYP. BD. AT EXISTING EXTERIOR STUD FRAMED WALLS, FINISH.
- THE HINGE SIDE OF ALL DOOR FRAMES SHALL BE MOUNTED 4" FROM ADJACENT PERPENDICULAR WALL UNLESS NOTED OTHERWISE.
- RE: I-SERIES FOR FURNITURE PLANS.
- CONTRACTOR SHALL PROVIDE BLOCKING OR BACKING FOR ALL WALL MOUNTED AND RECESSED ACCESSORIES AND EQUIPMENT. ASSURE THAT ALL REQUIRED BACKING IS INSTALLED IN WALLS PRIOR TO INSTALLING DRYWALL. THIS INCLUDES BACKING FOR WALL-MOUNTED DOORSTOPS.
- THE HINGE SIDE OF ALL DOOR FRAMES SHALL BE MOUNTED 4" MIN. FROM ADJACENT PERPENDICULAR WALL U.N.O.
- SINKS AND FITTING SHOWN WITHIN MILLWORK ARE INDICATED ON PLUMBING PLANS.
- CONTRACTOR SHALL FIELD MEASURE ALL AREAS TO RECEIVE MILLWORK PRIOR TO FABRICATION OF MILLWORK.
- VERIFY ALL PLUMBING FIXTURES WITH PLUMBING DRAWINGS.

### AGENCY SET

PROJECT	DATE
19176	05-07-2020
DRAWN	CHECKED
LMV	JSG / CAS

### SHEET TITLE

## ENLARGED PLANS

SHEET


**A42**  
ORIGINAL SHEET SIZE  
24" x 36"

**CONTAINER COFFEE SHOP**  
79 SOUTH MAIN STREET  
PITTSBURGH, PA

CRAIG A. SLOCUM, ARCHITECT

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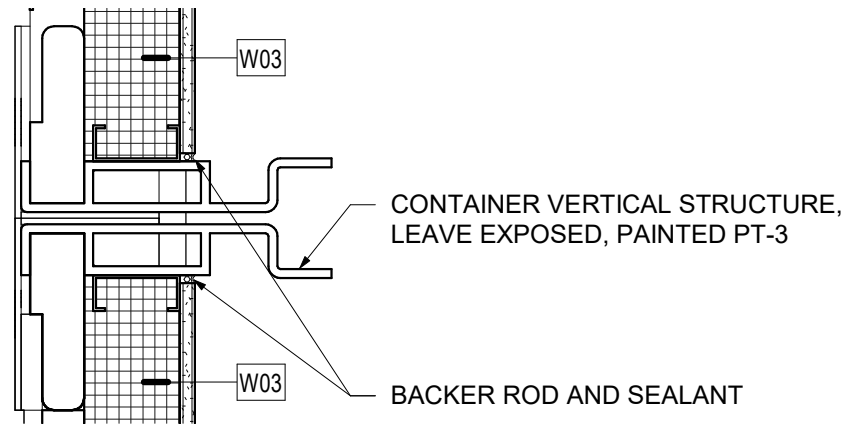
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5/7/2020 10:27:35 AM


### 3 TYPICAL APT EXPOSED STRUCTURE

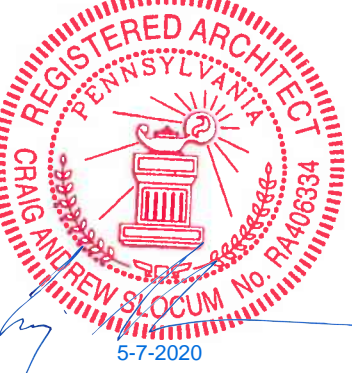1 1/2" = 1'-0"




### 2 SOFFIT DETAIL

1 1/2" = 1'-0"

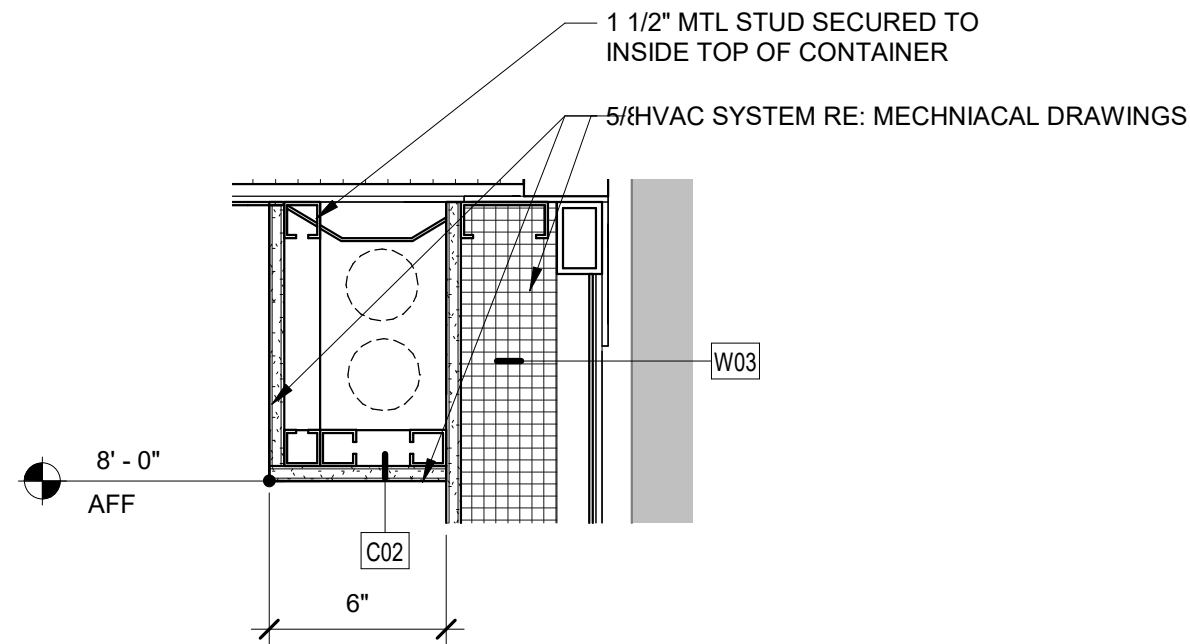


### 4 GATE PLAN

1 1/2" = 1'-0"

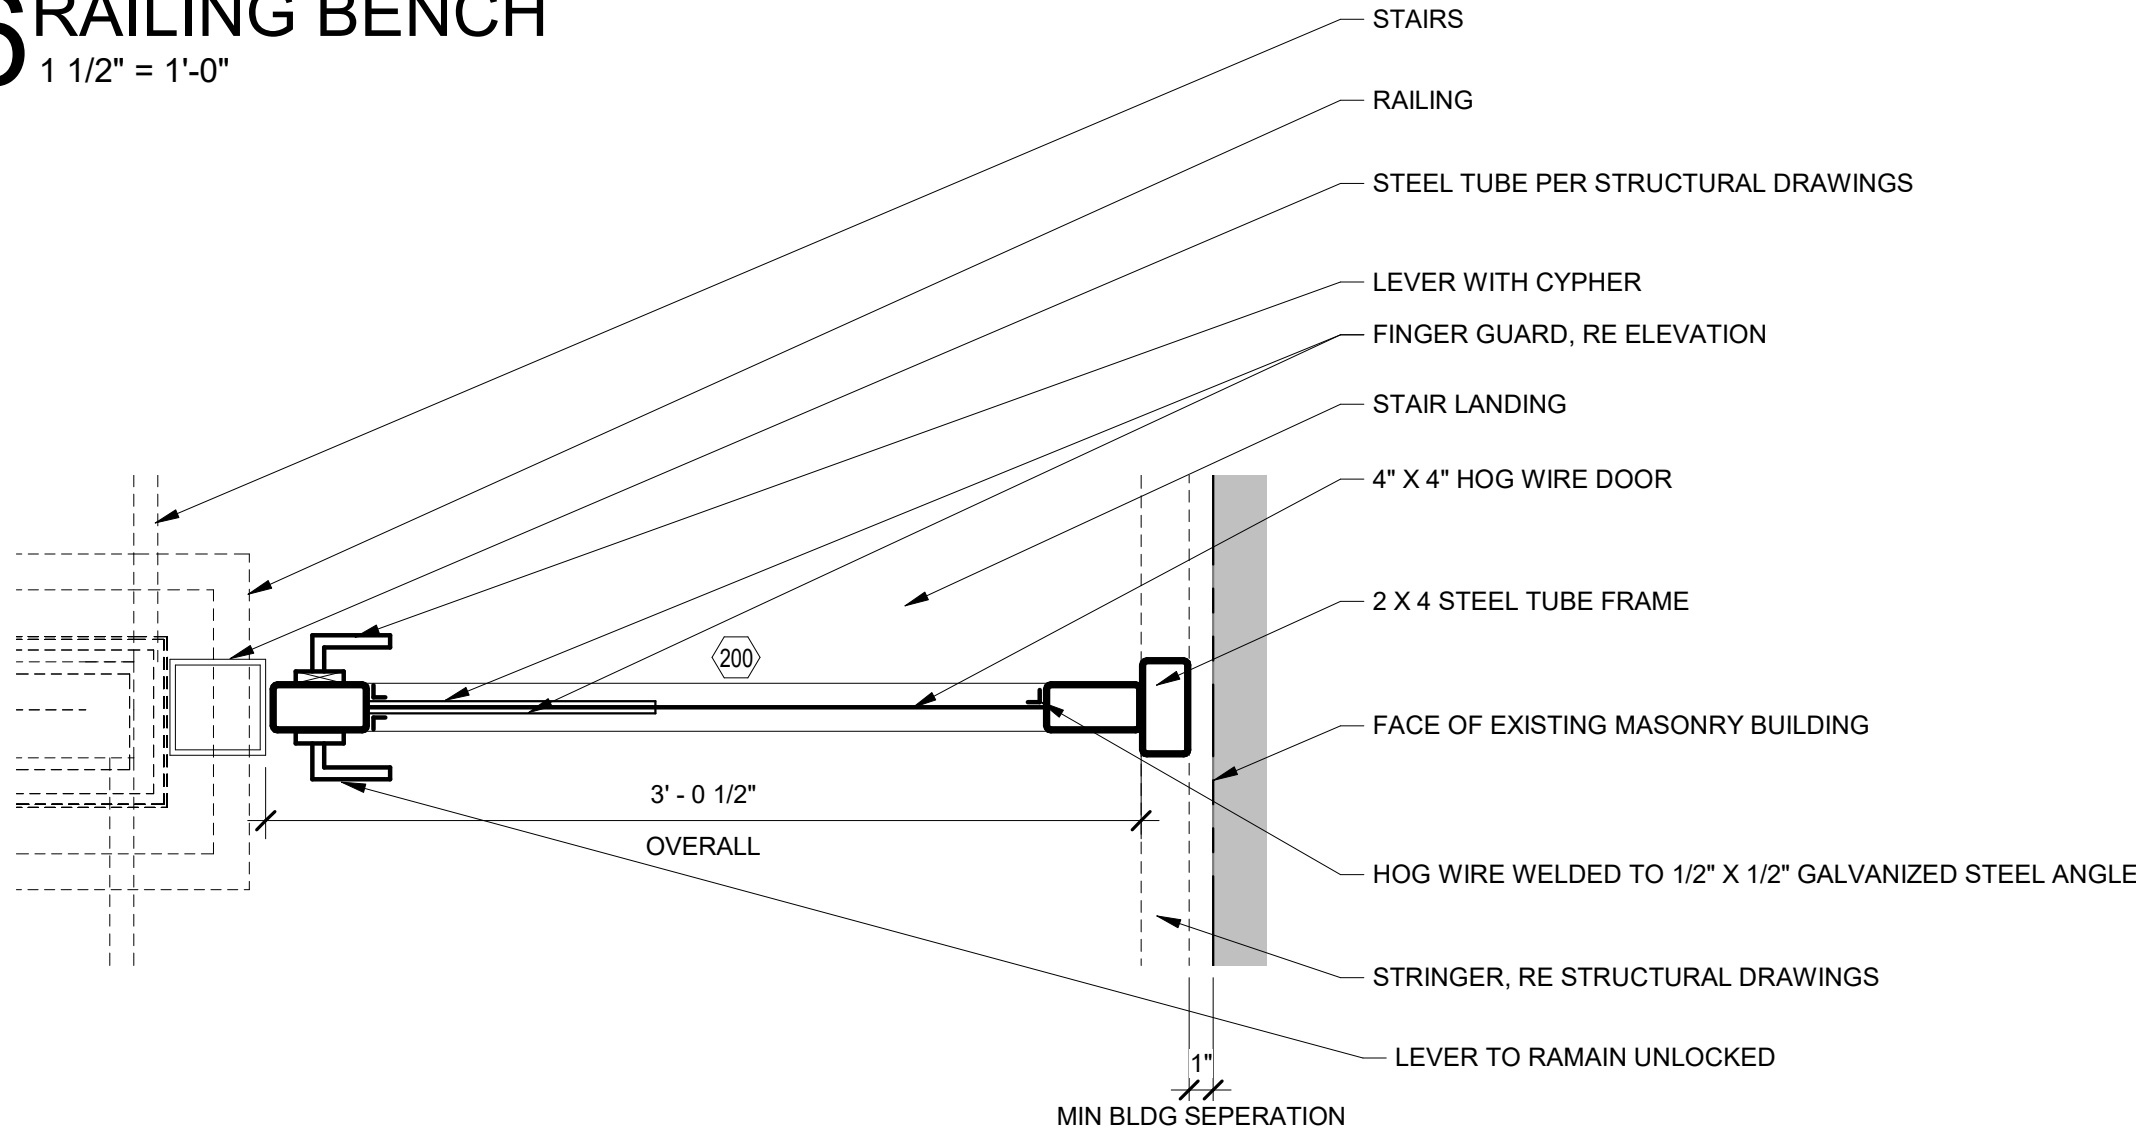


### 6 RAILING BENCH

1 1/2" = 1'-0"

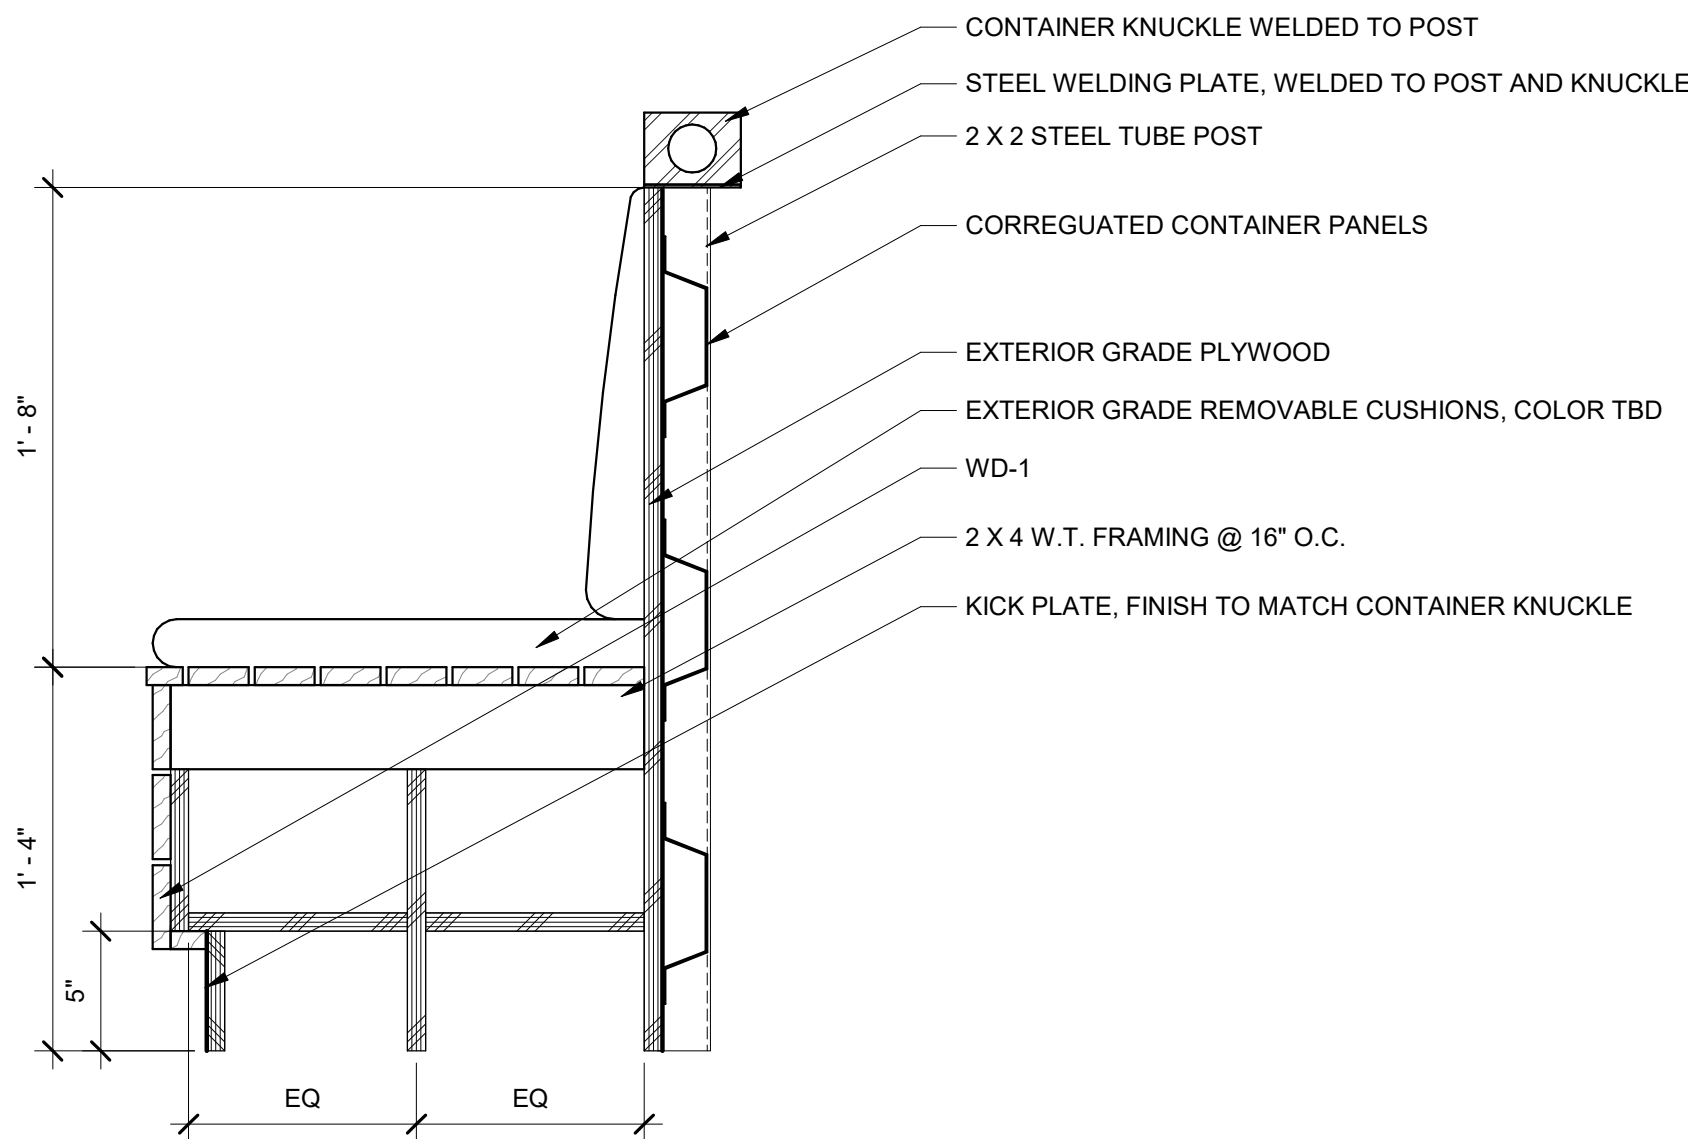


### 5 PATIO CONNECTION TO (E) STRUCTURE

1 1/2" = 1'-0"

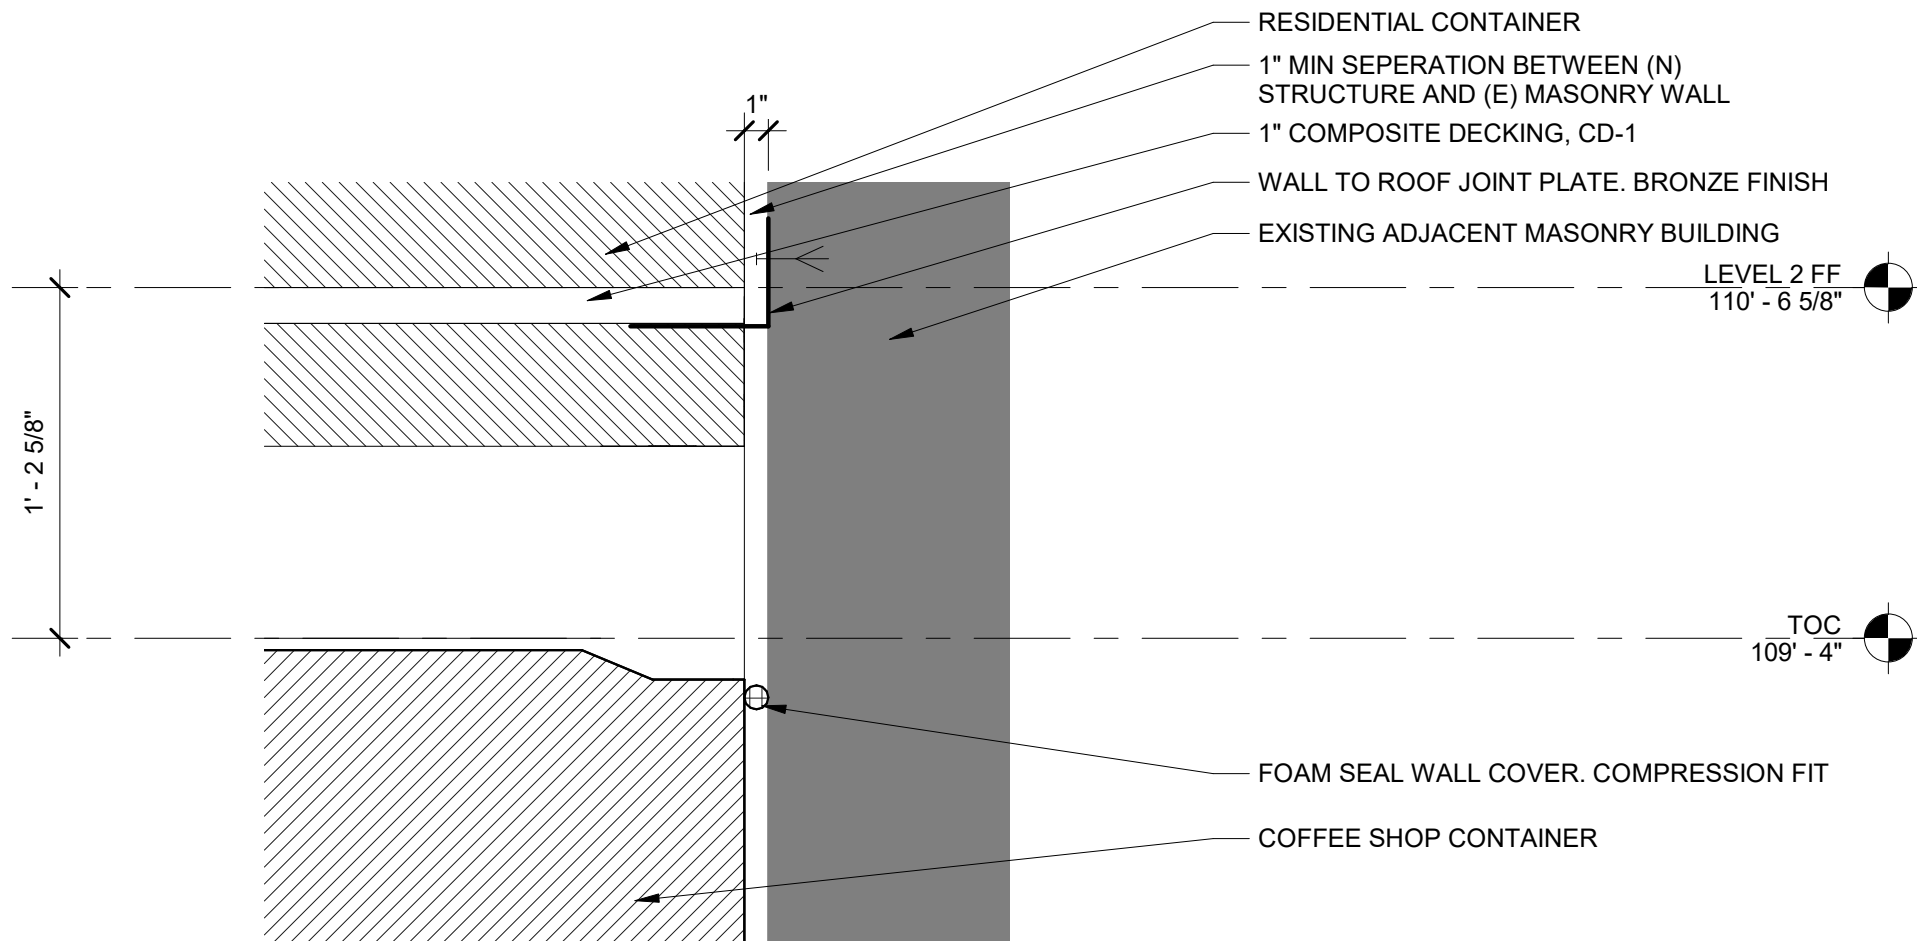

### 7 MEP PENETRATIONS

3/8" = 1'-0"

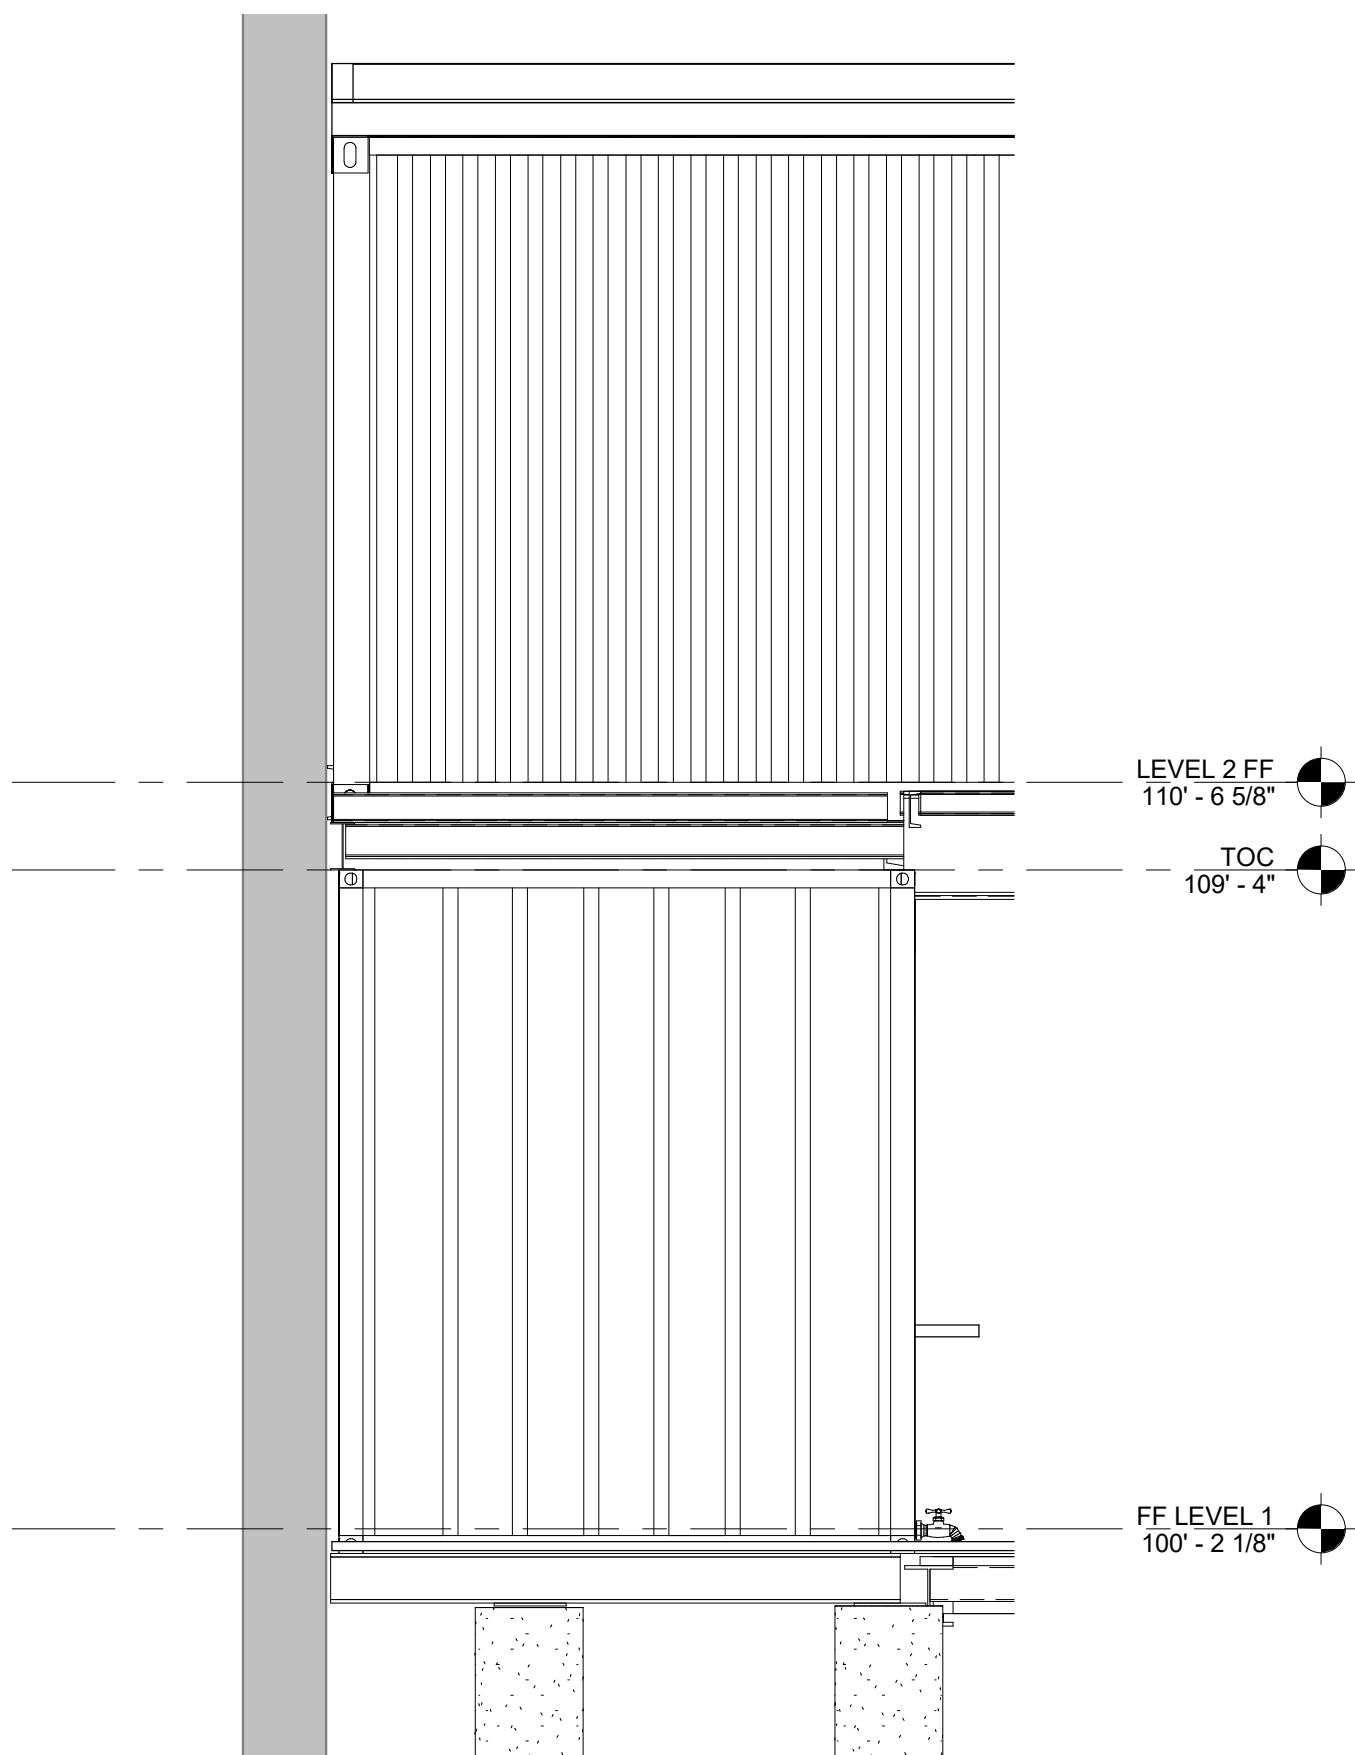

## GENERAL NOTES:

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- CONTRACTOR SHALL PROVIDE BLOCKING OR BACKING FOR ALL WALL MOUNTED AND RECESSED ACCESSORIES AND EQUIPMENT. ASSURE THAT ALL REQUIRED BACKING IS INSTALLED IN WALLS PRIOR TO INSTALLING DRYWALL. THIS INCLUDES BACKING FOR WALL-MOUNTED DOORSTOPS.
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- SINKS AND FITTING SHOWN WITHIN MILLWORK ARE INDICATED ON PLUMBING PLANS.
- CONTRACTOR SHALL FIELD MEASURE ALL AREAS TO RECEIVE MILLWORK PRIOR TO FABRICATION OF MILLWORK.
- VERIFY ALL PLUMBING FIXTURES WITH PLUMBING DRAWINGS.

## AGENCY SET

PROJECT	DATE
19176	05-07-2020
DRAWN	CHECKED
LMV	JSG / CAS

REVISED

SHEET TITLE

DETAILS

SHEET

A43

ORIGINAL SHEET SIZE  
24" x 36"

CONTAINER COFFEE SHOP  
79 SOUTH MAIN STREET  
PITTSBURGH, PA

2896 S COLORADO BLVD, SUITE 525  
DENVER, CO 80222  
(303) 962-9164  
www.cshqa.com

CRAIG A. SLOCUM, ARCHITECT


CRAIG A. SLOCUM, ARCHITECT

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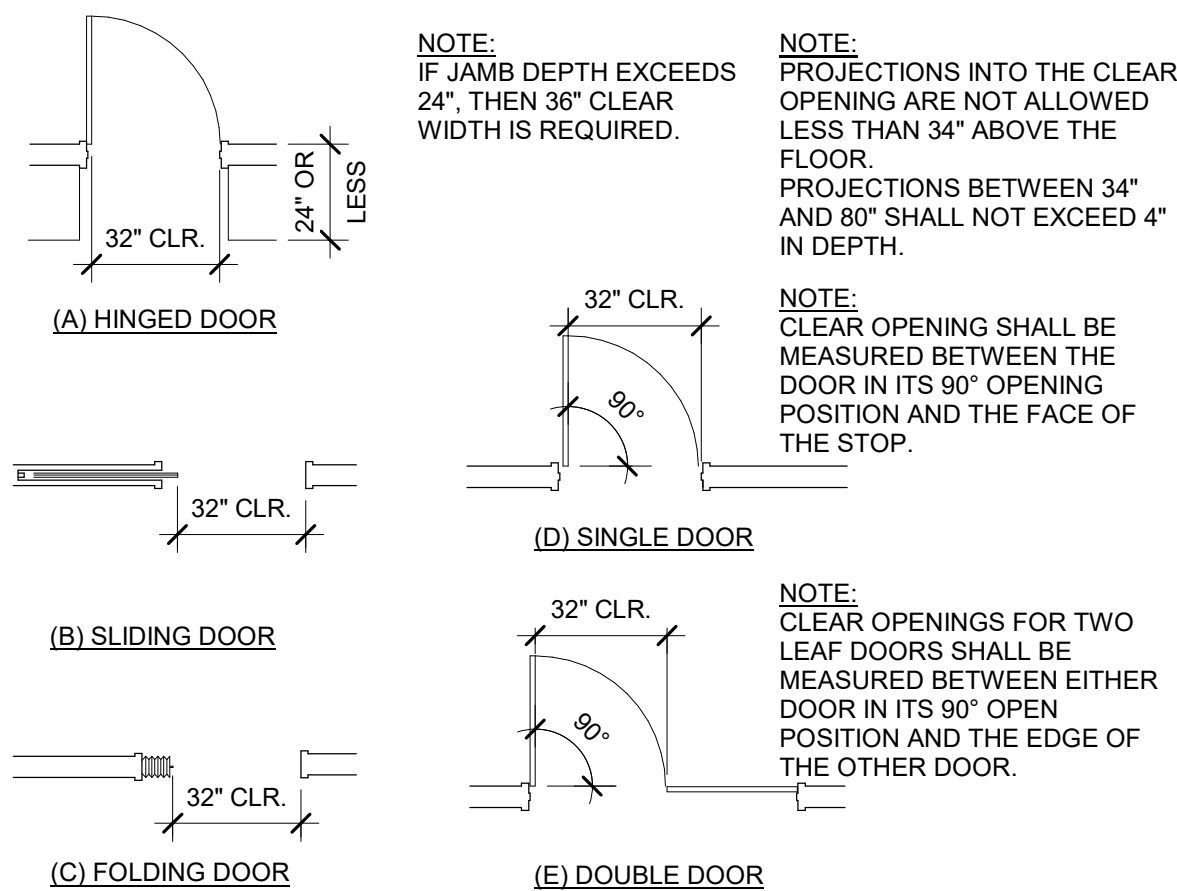







## 1 ACCESSIBLE BABY CHANGE

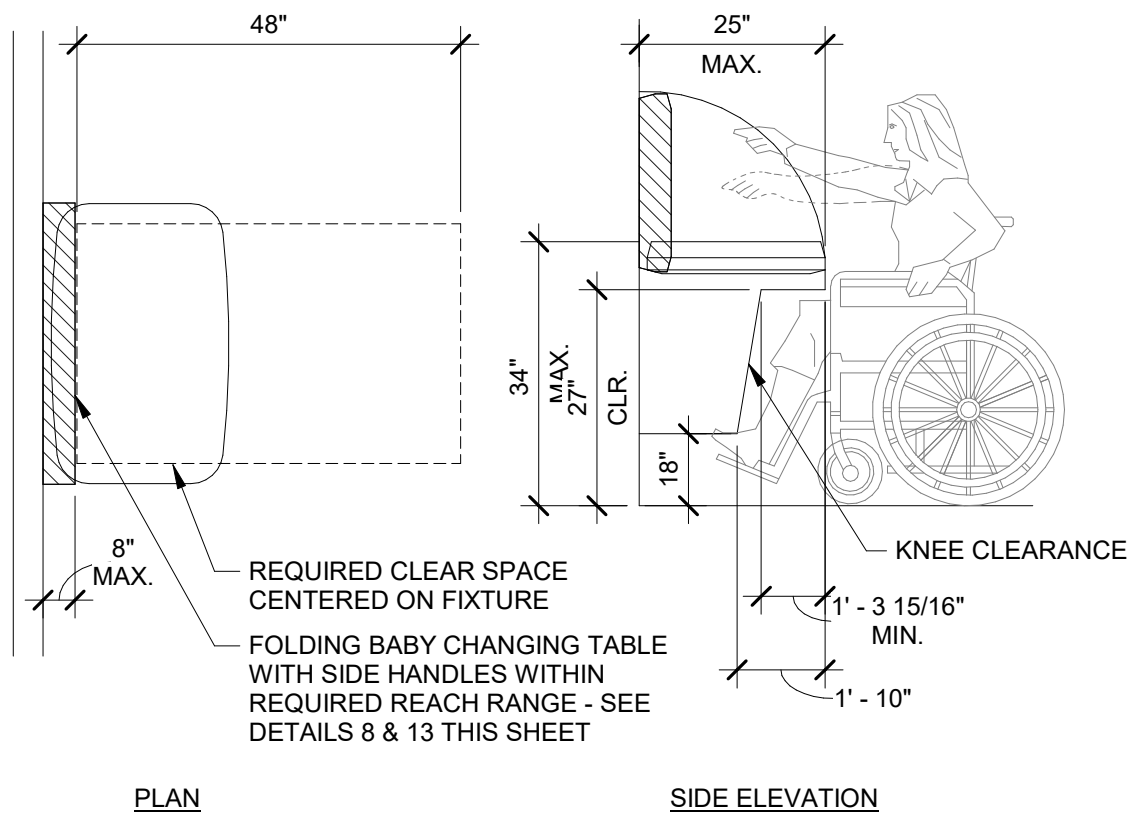1/4" = 1'-0"




## 6 CLEARANCE THRU DOORS

1/4" = 1'-0"

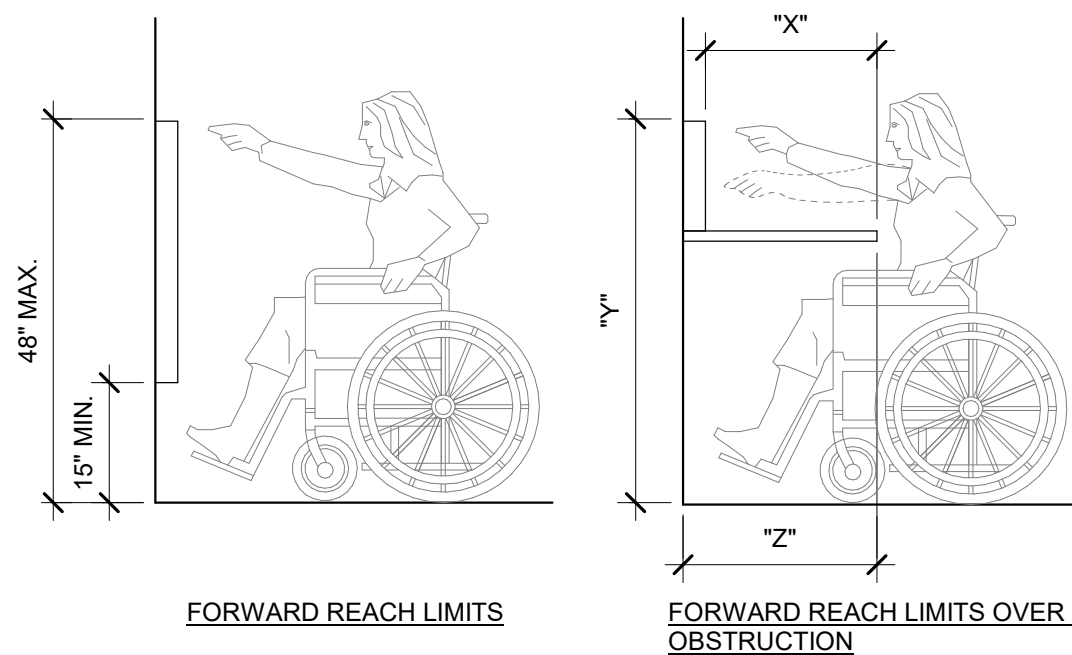


## 10 FORWARD REACH

1/2" = 1'-0"

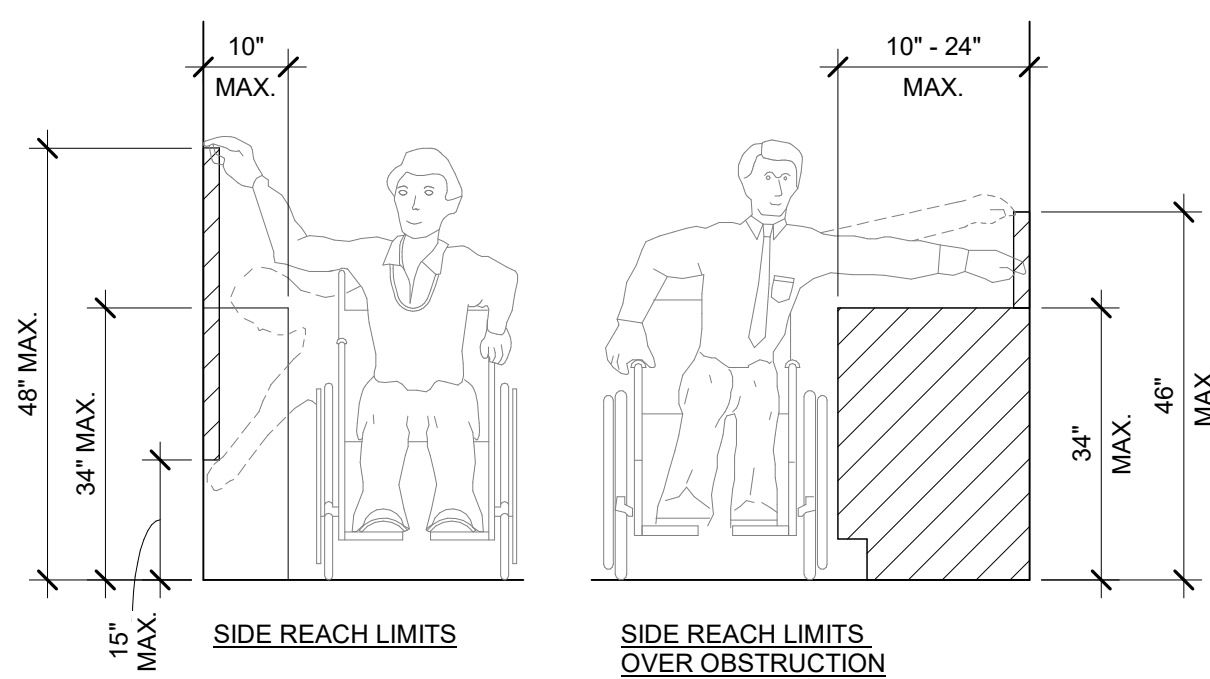


## 14 SIDE REACH

1/4" = 1'-0"

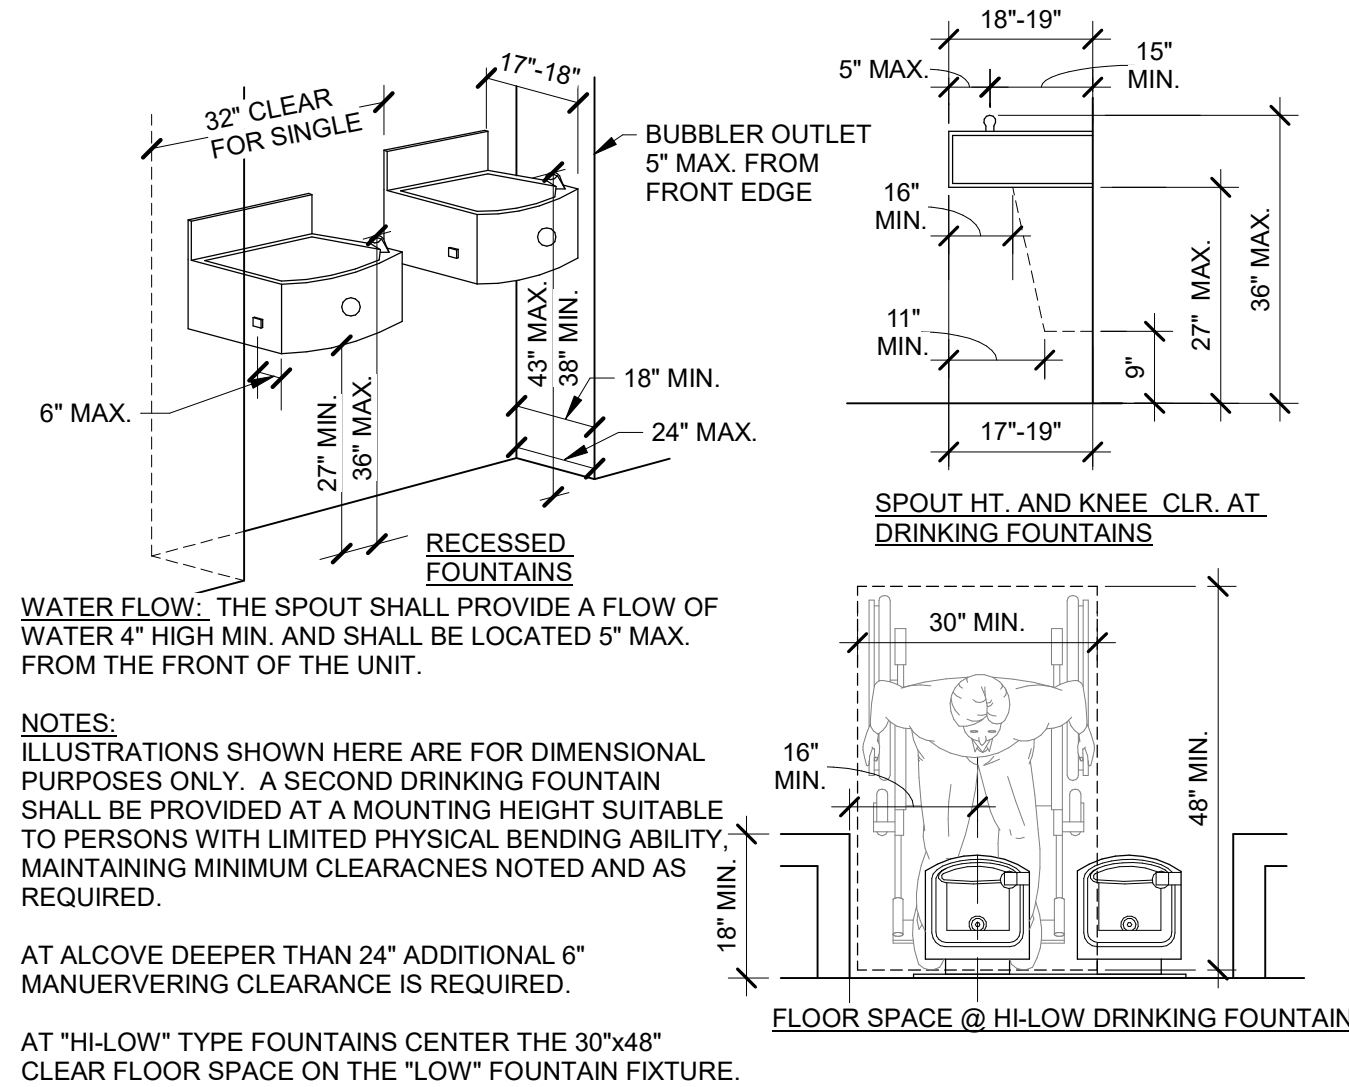

## 2 ACCESSIBLE DRINKING FOUNTAIN


1/4" = 1'-0"

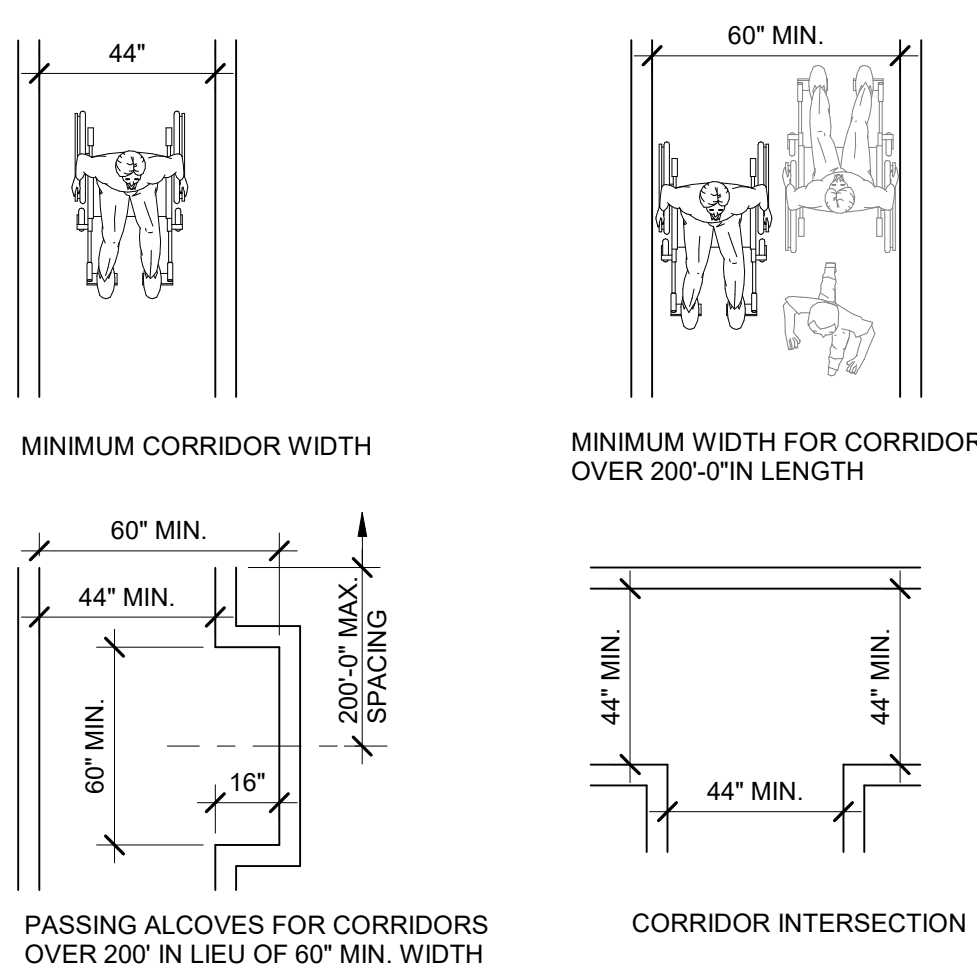

## 7 CORRIDOR WIDTH


1/4" = 1'-0"

A NARROW FRAME WITH A BEVELED TOP EDGE (60 DEGREE MAXIMUM BEVEL TO HORIZONTAL PLANE) INSTALLED AT THE BOTTOM OF TEMPERED GLASS DOOR (WITH NO SIDE FRAMES) MAY BE USED IN LIEU OF PROVIDING THE REQUIRED 10-INCH UNINTERRUPTED SURFACE AT THE BOTTOM OF THE DOOR.

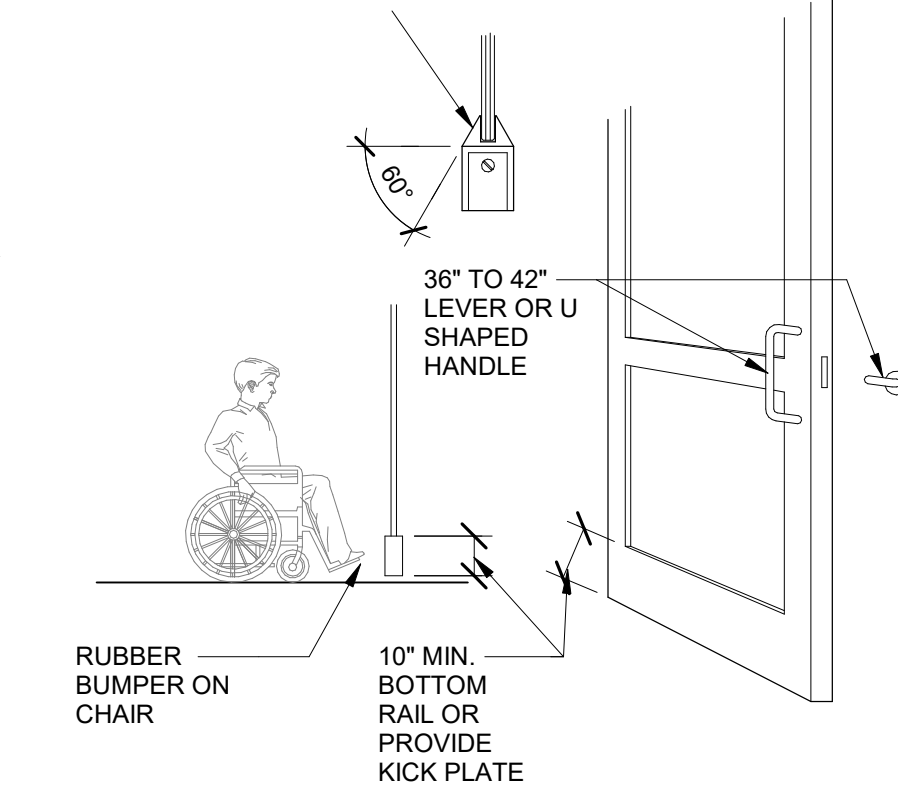


## 8 DOOR CONSTRUCTION

1/4" = 1'-0"

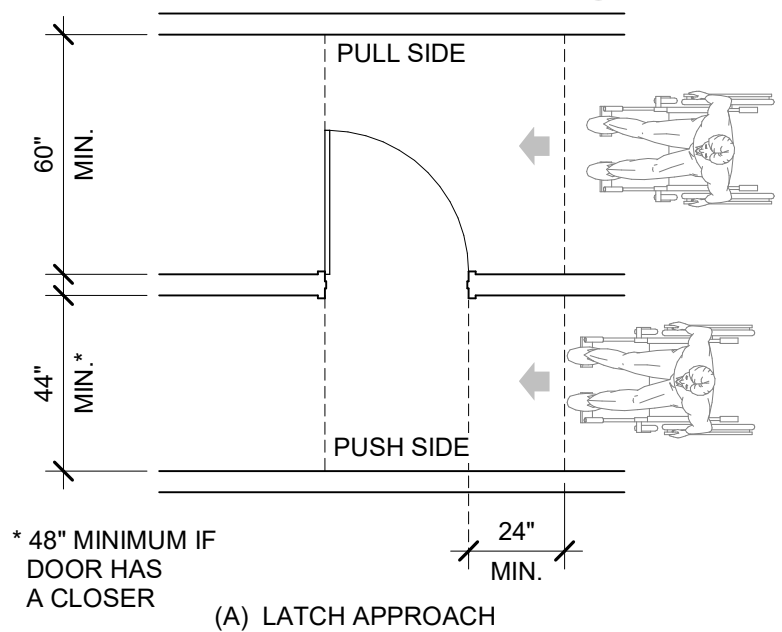

## 11 MANEUVERING CLEARANCES AT DOORS 01

1/4" = 1'-0"

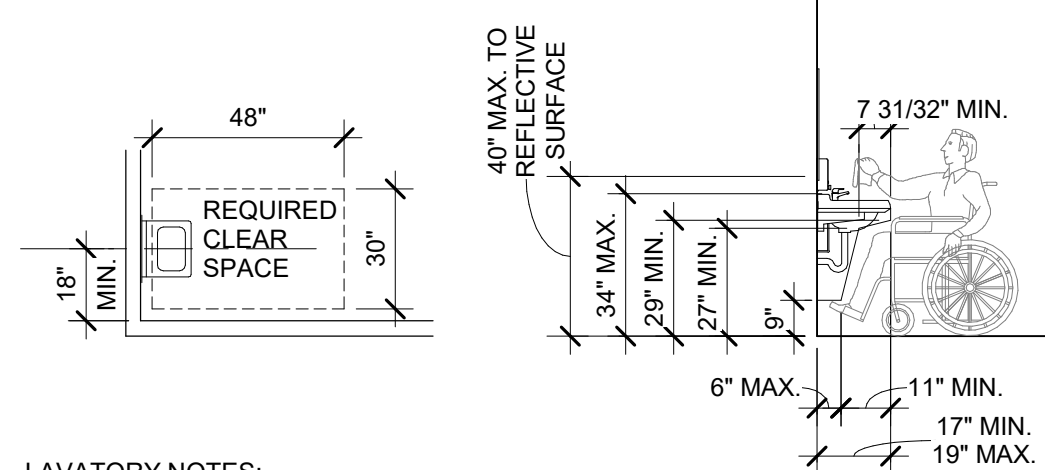


## 3 ACCESSIBLE LAVATORY

1/4" = 1'-0"

- LAVATORY NOTES:**
1. PROVIDE A CLEAR SPACE 30" X 48" MIN. IN FRONT OF THE LAVATORY. THE CLEAR SPACE MAY EXTEND INTO KNEE AND TOE SPACE UNDER THE LAVATORY.
  2. THE DIP OF THE OVERFLOW SHALL NOT BE CONSIDERED IN DETERMINING KNEE AND TOE CLEARANCES.
  3. INSULATE OR CONFIGURE WATER SUPPLY AND DRAIN PIPING UNDER SINKS TO PREVENT CONTACT.
  4. THERE SHALL BE NO SHARP OR ABRASIVE SURFACES ALLOWED UNDER LAVATORIES.
  5. FAUCET CONTROLS AND OPERATING MECHANISMS ARE REQUIRED TO BE OPERABLE WITH ONE HAND AND CANNOT REQUIRE GRASPING, PINCHING, OR TWISTING OF WRIST. THE FORCE REQUIRED TO ACTIVATE CONTROLS IS NOT TO EXCEED 5 LBS. LEVER OPERATED, PUSH TYPE AND ELECTRONICALLY CONTROLLED MECHANISMS ARE EXAMPLES OF ACCEPTABLE DESIGN.
  6. SELF CLOSING VALVES ARE ALLOWED IF THE FAUCET REMAINS OPEN FOR AT LEAST 10 SECONDS.

## 4 ACCESSIBLE URINAL

1/4" = 1'-0"

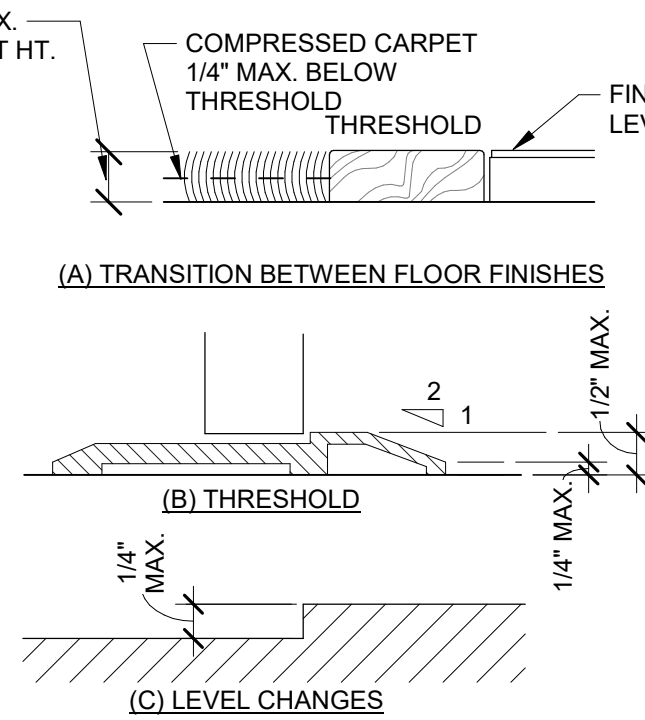


## 4 ACCESSIBLE URINAL

1/4" = 1'-0"

- DOOR NOTES:**
1. MINIMUM 10" HIGH SMOOTH SURFACE AT DOOR BOTTOM, EITHER ATTACHED PANEL OR INTEGRAL BOTTOM RAIL.
  2. ALL EXIT DOORS SHALL BE PIVOTED OR SIDE HINGED SWINGING TYPE.
  3. ALL DOORS SHALL HAVE A LEVEL FLOOR OR LANDING ON EACH SIDE OF THE DOOR NOT TO EXCEED A MAXIMUM OF 1/4" PER FOOT OR 2%.
  4. THE MINIMUM SIZE FOR ANY DOOR SHALL BE 3'-0" X 6'-8" AND SHALL HAVE A MINIMUM OF 32" CLEARANCE.
- HARDWARE NOTES:** IDTH SHALL BE 3'-0" NOMINAL OPENING.
1. DOORS SHALL BE OPENABLE FROM SINGLE EFFORT. A MINIMUM OF 32" CLEARANCE.
  2. NO GRASPING OR WRIST MOVEMENT USING LEVER, DOORS, PUSH-PULLS OR PANIC DEVICES, AND SHALL BE OPENABLE WITHOUT USE OF A KEY OR ANY SPECIAL KNOWLEDGE OR EFFORT.
  3. HARDWARE SHALL BE MOUNTED AT 36" TO 42".
  4. DOOR CLOSERS SHALL PROVIDE A MINIMUM OF 3 SECONDS TO MOVE FROM A 70 DEGREE OPEN EFFORT TO OPERATE DOORS.
- INTERIOR DOORS = 5 LBS**  
**EXTERIOR DOORS = 5 LBS**  
**FIRE DOORS = AS REQUIRED BY AHJ**  
**NOT TO EXCEED 15 LBS.**


## 5 CLEAR WIDTH

1/4" = 1'-0"

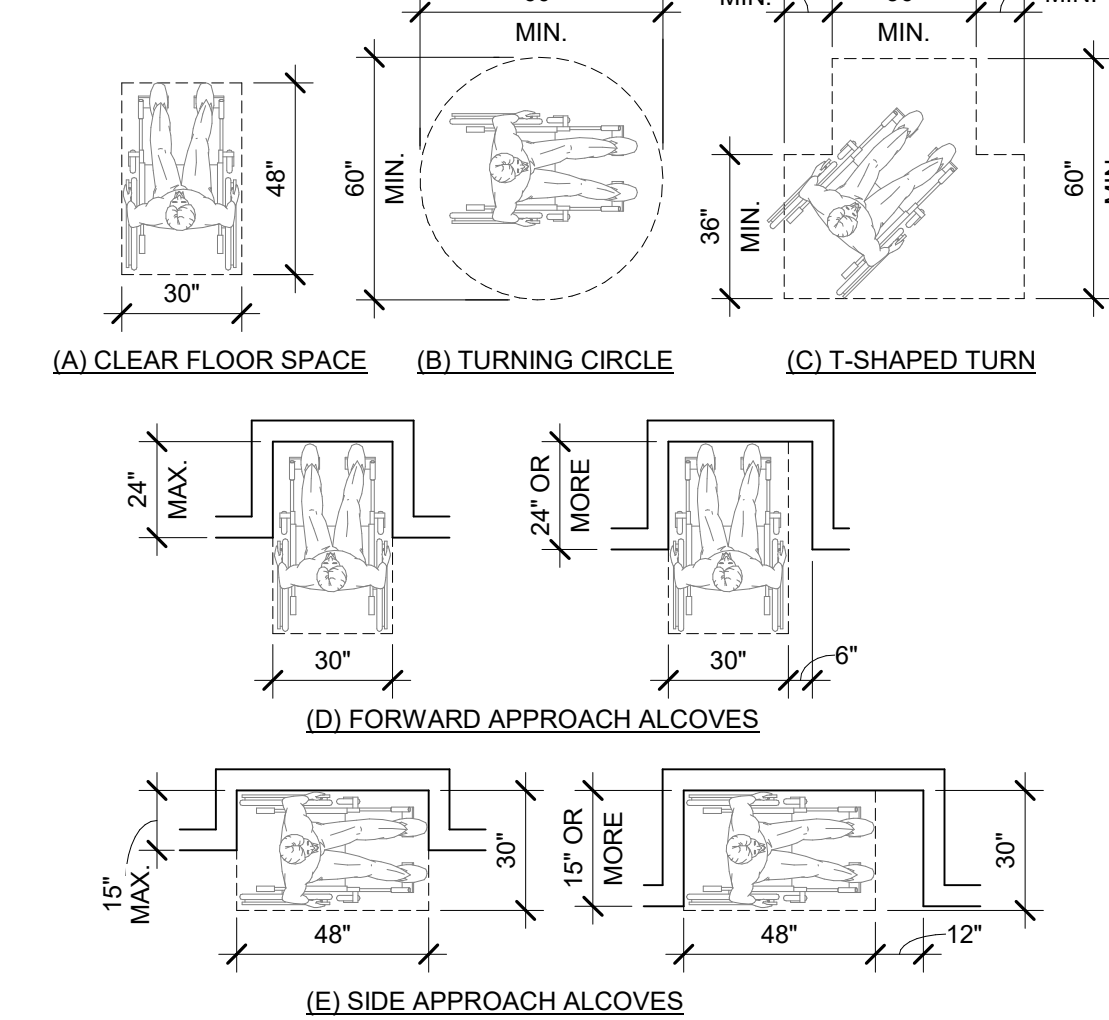





## 9 FLOOR SPACE FOR WHEELCHAIRS

1/4" = 1'-0"

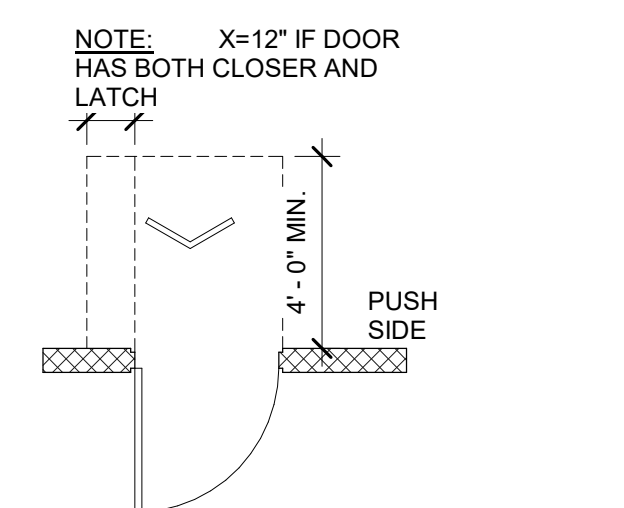

## 12 MANEUVERING CLEARANCES AT DOORS 02

1/4" = 1'-0"

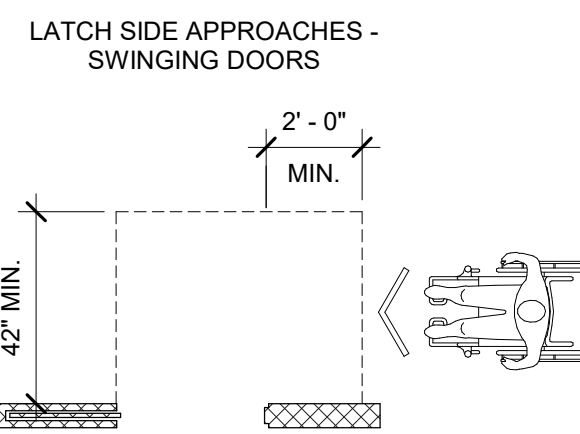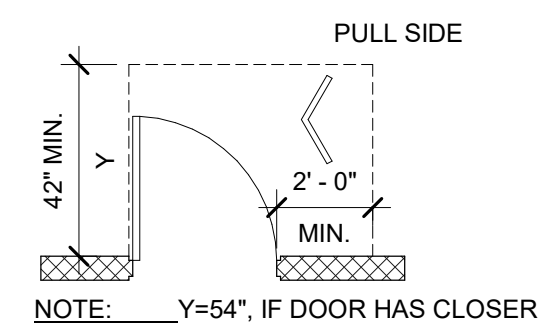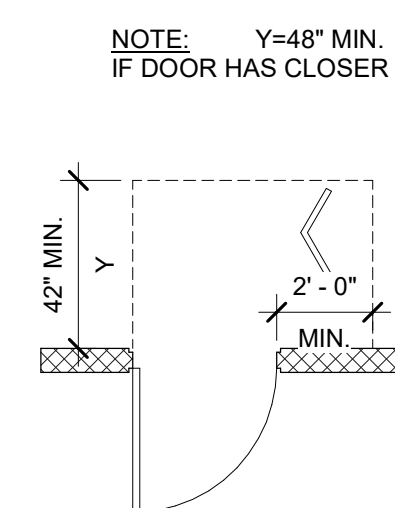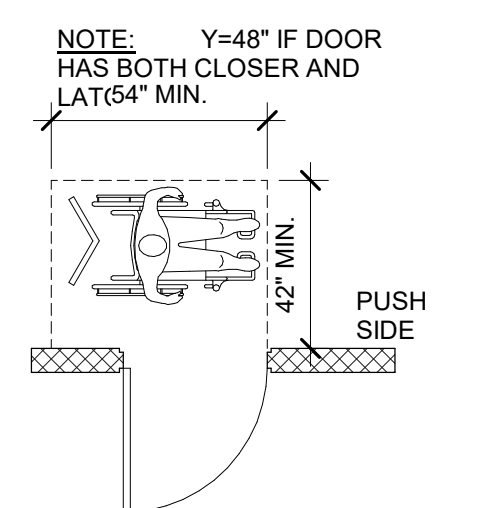

NOTE: ALL DOORS IN ALCOVES SHALL COMPLY WITH THE CLEARANCE FOR FRONT APPROACHES.



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**CONTAINER COFFEE SHOP**  
**PITTSBURGH, PA**  
**79 SOUTH MAIN STREET**

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CRAIG A. SLOCUM, ARCHITECT

## AGENCY SET

PROJECT 19176	DATE 05-07-2020
DRAWN LMV	CHECKED JSG / CAS

REVISED

SHEET TITLE

**STANDARD  
ADA NOTES**

SHEET

**A44**


ORIGINAL SHEET SIZE  
24" x 36"








GENERAL NOTES:

- A. PROVIDE MATERIAL SAMPLES FOR OWNER/ARCHITECT'S APPROVAL.
- B. FINISHES ARE ALSO REQUIRED AT PORTIONS OF UNDERSIDE, INSIDE FACE OF PARAPETS, AND SOFFITS EXPOSED TO PUBLIC VIEW.
- C. THE REFERENCE ELEVATION MARKED WITH  REPRESENTS VERTICAL HEIGHTS RELATIVE TO INTERIOR FLOOR DATUM ASSUMED AT 100'-0", CWI/ CIVIL FOR ACTUAL FLOOR ELEVATION.
- D. ALL MATERIAL SYMBOLS ARE FOR REPRESENTATION ONLY. CONTRACTOR IS RESPONSIBLE FOR DETERMINING PROPER COURSING, ETC.
- E. LOCATION FOR ADDRESS SIGNAGE TO BE INSTALLED AS REQUIRED AND APPROVED BY THE CITY OF PITTSBURGH.
- F. ALL ROOFTOP EQUIPMENT TO BE SCREENED BY WALLS OR EQUIPMENT SCREENS.
- G. COORDINATE LOCATION OF KNOXBOX WITH FIRE MARSHALL.

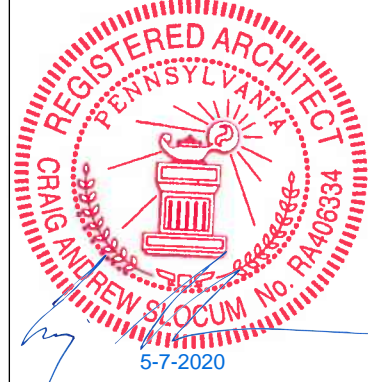

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79 SOUTH MAIN STREET

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CRAIG A. SLOCUM, ARCHITECT

AGENCY SET

PROJECT	DATE
19176	05-07-2020
DRAWN	CHECKED
LMV	JSG / CAS


REVISED

SHEET TITLE


**EXTERIOR  
ELEVATIONS**

SHEET


**A51**  
ORIGINAL SHEET SIZE  
24" x 36"

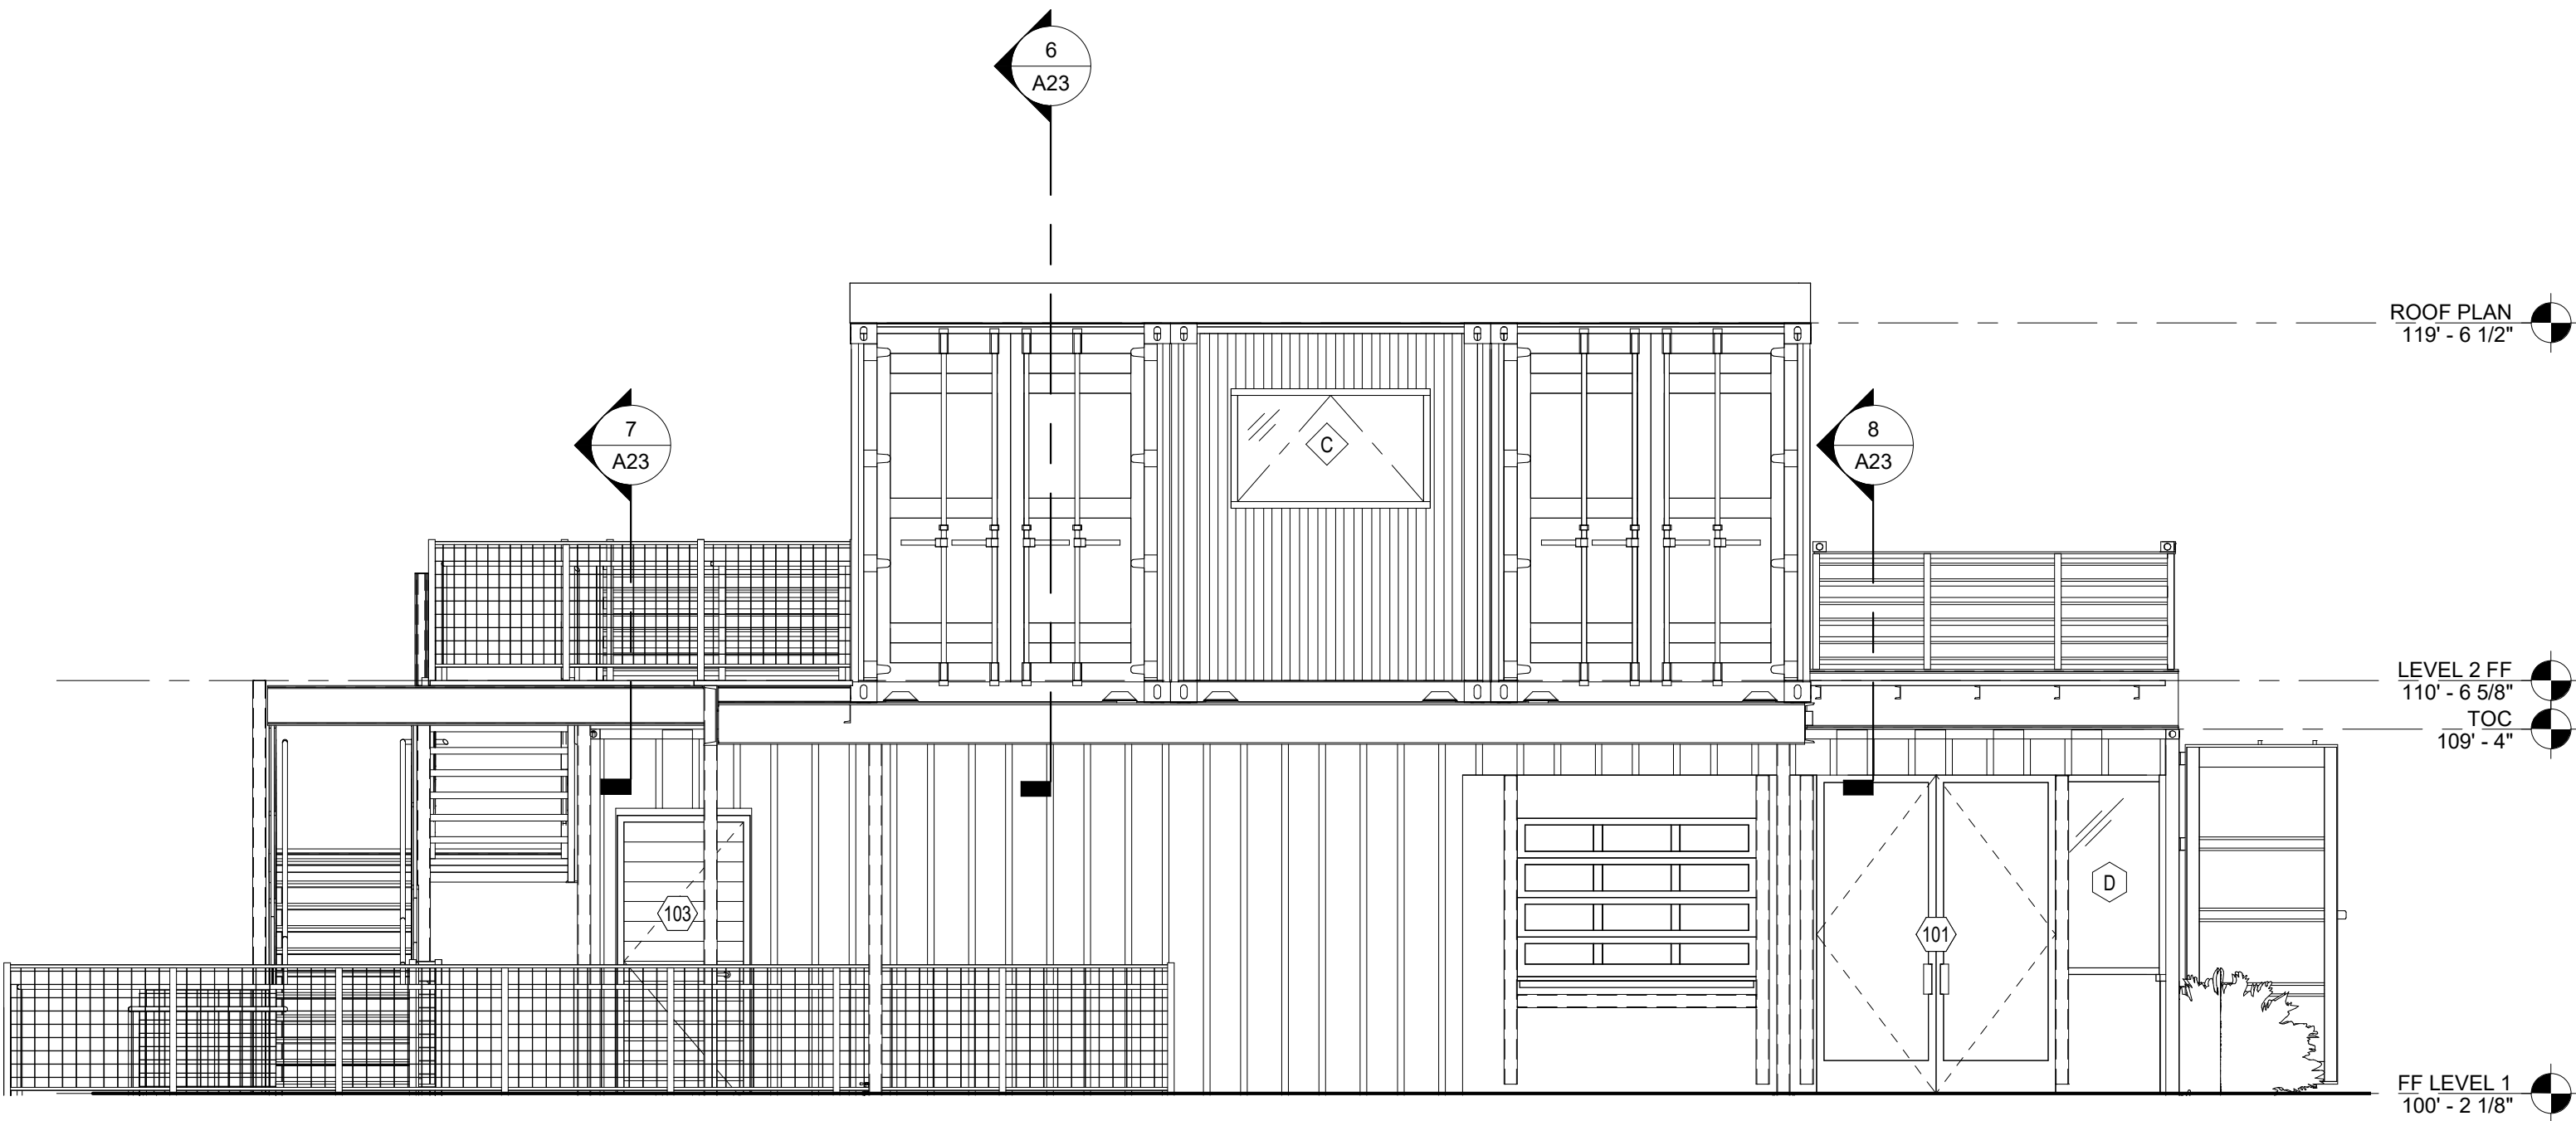

**1** NORTHEAST ELEVATION - STOREFRONT  
1/4" = 1'-0"

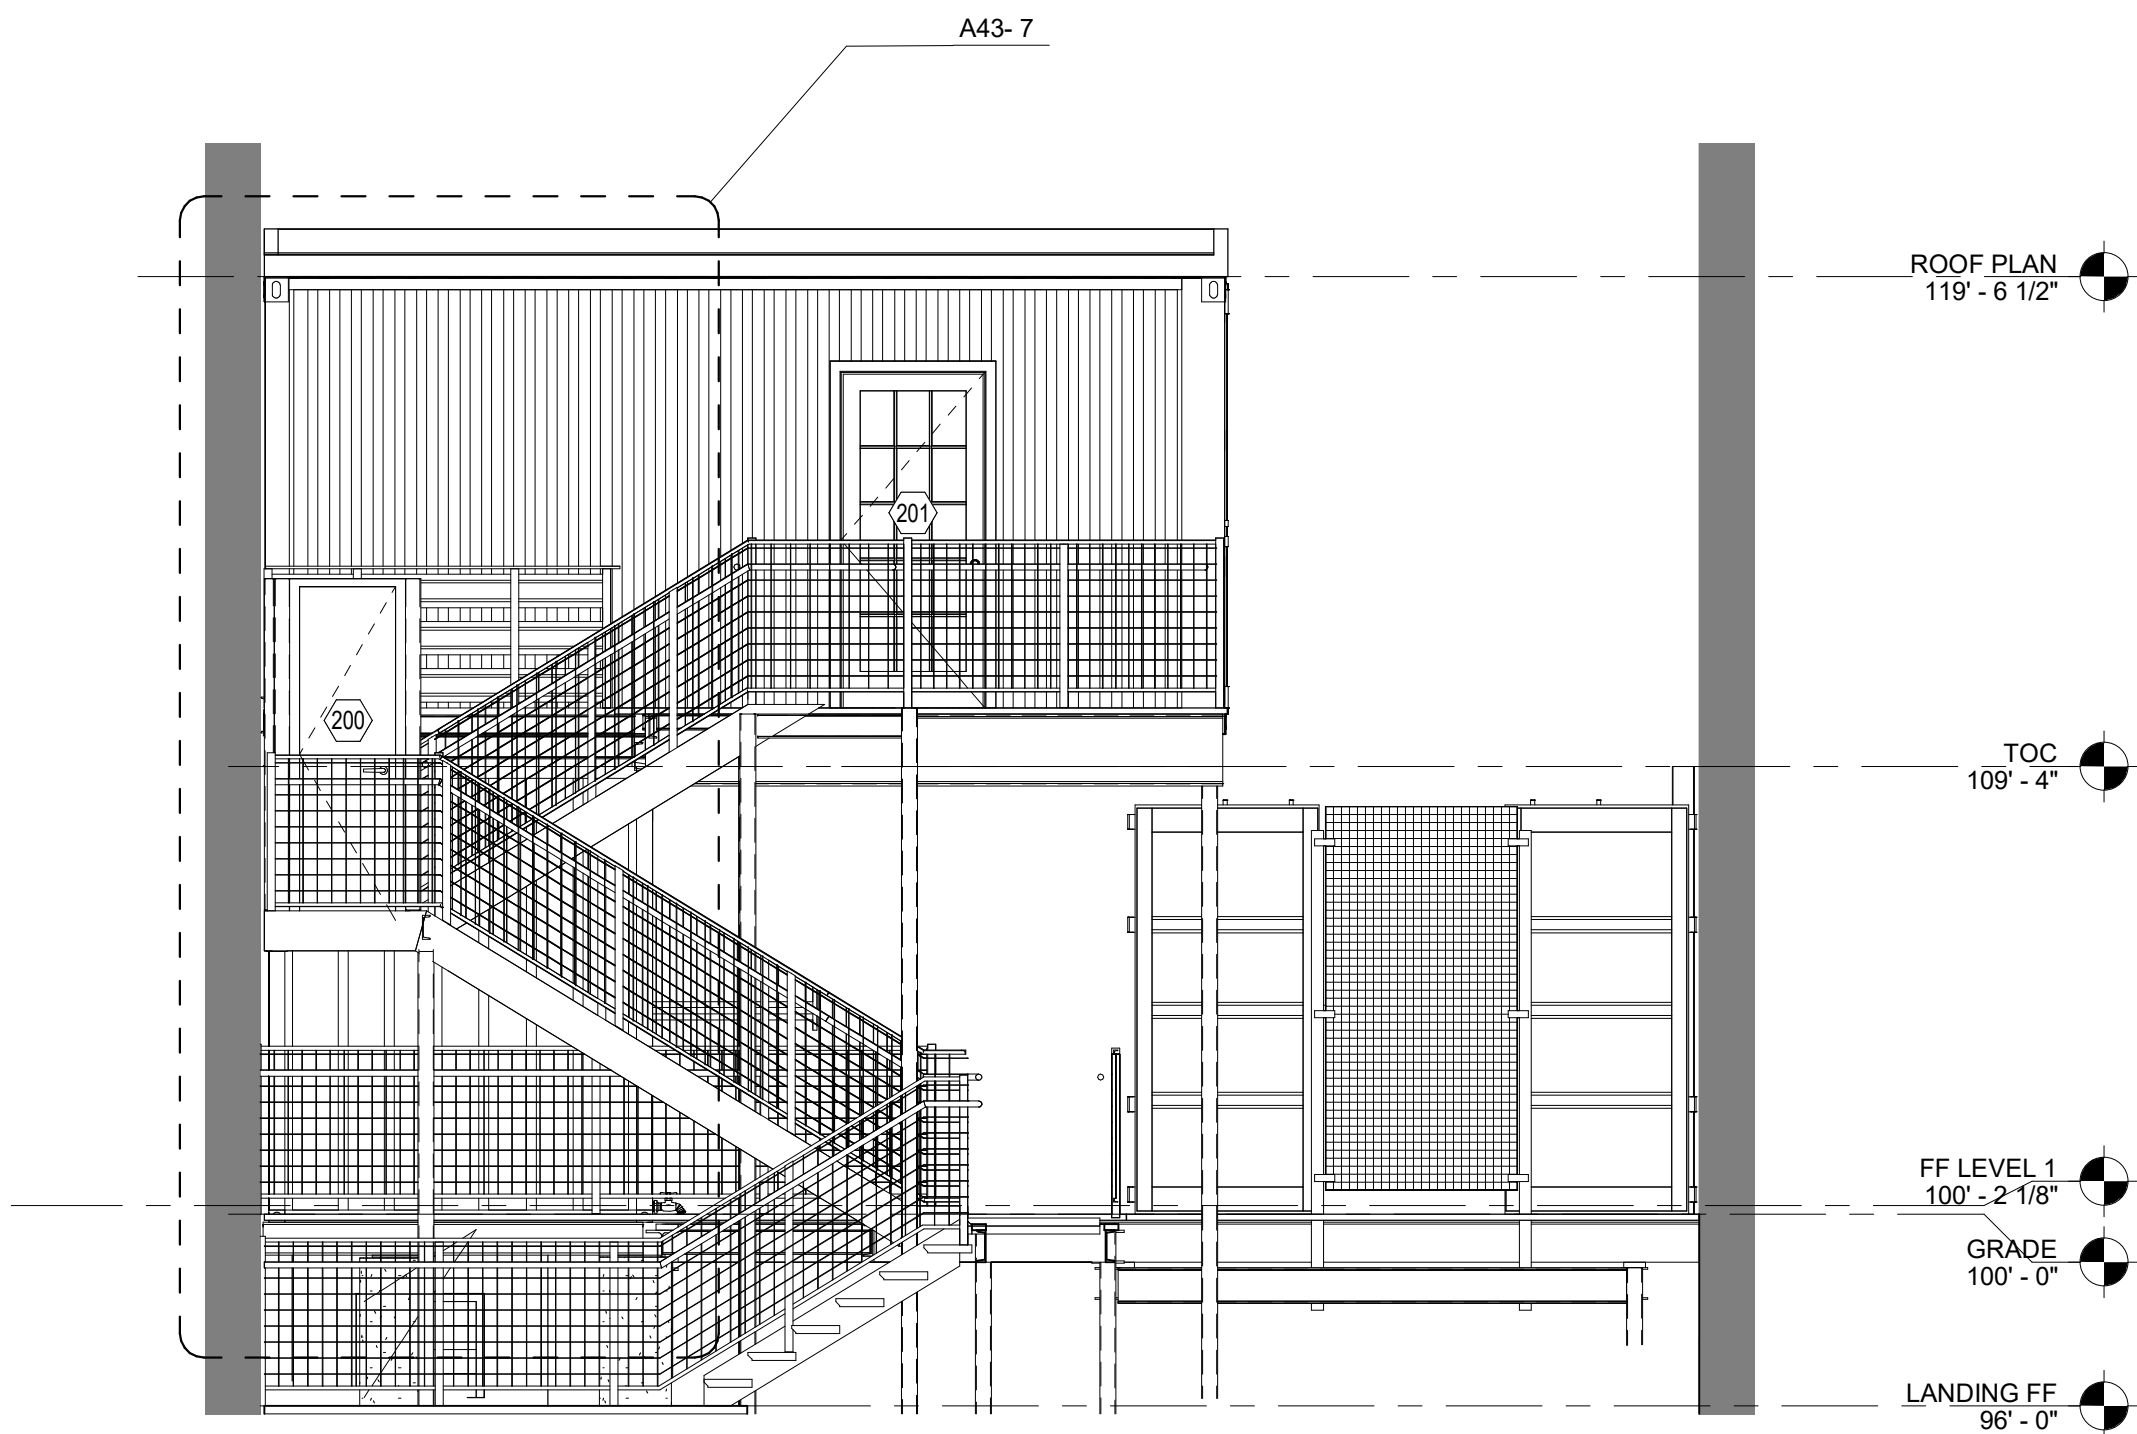


**2** SOUTHWEST ELEVATION - RESIDENTIAL ENTRANCE  
1/4" = 1'-0"

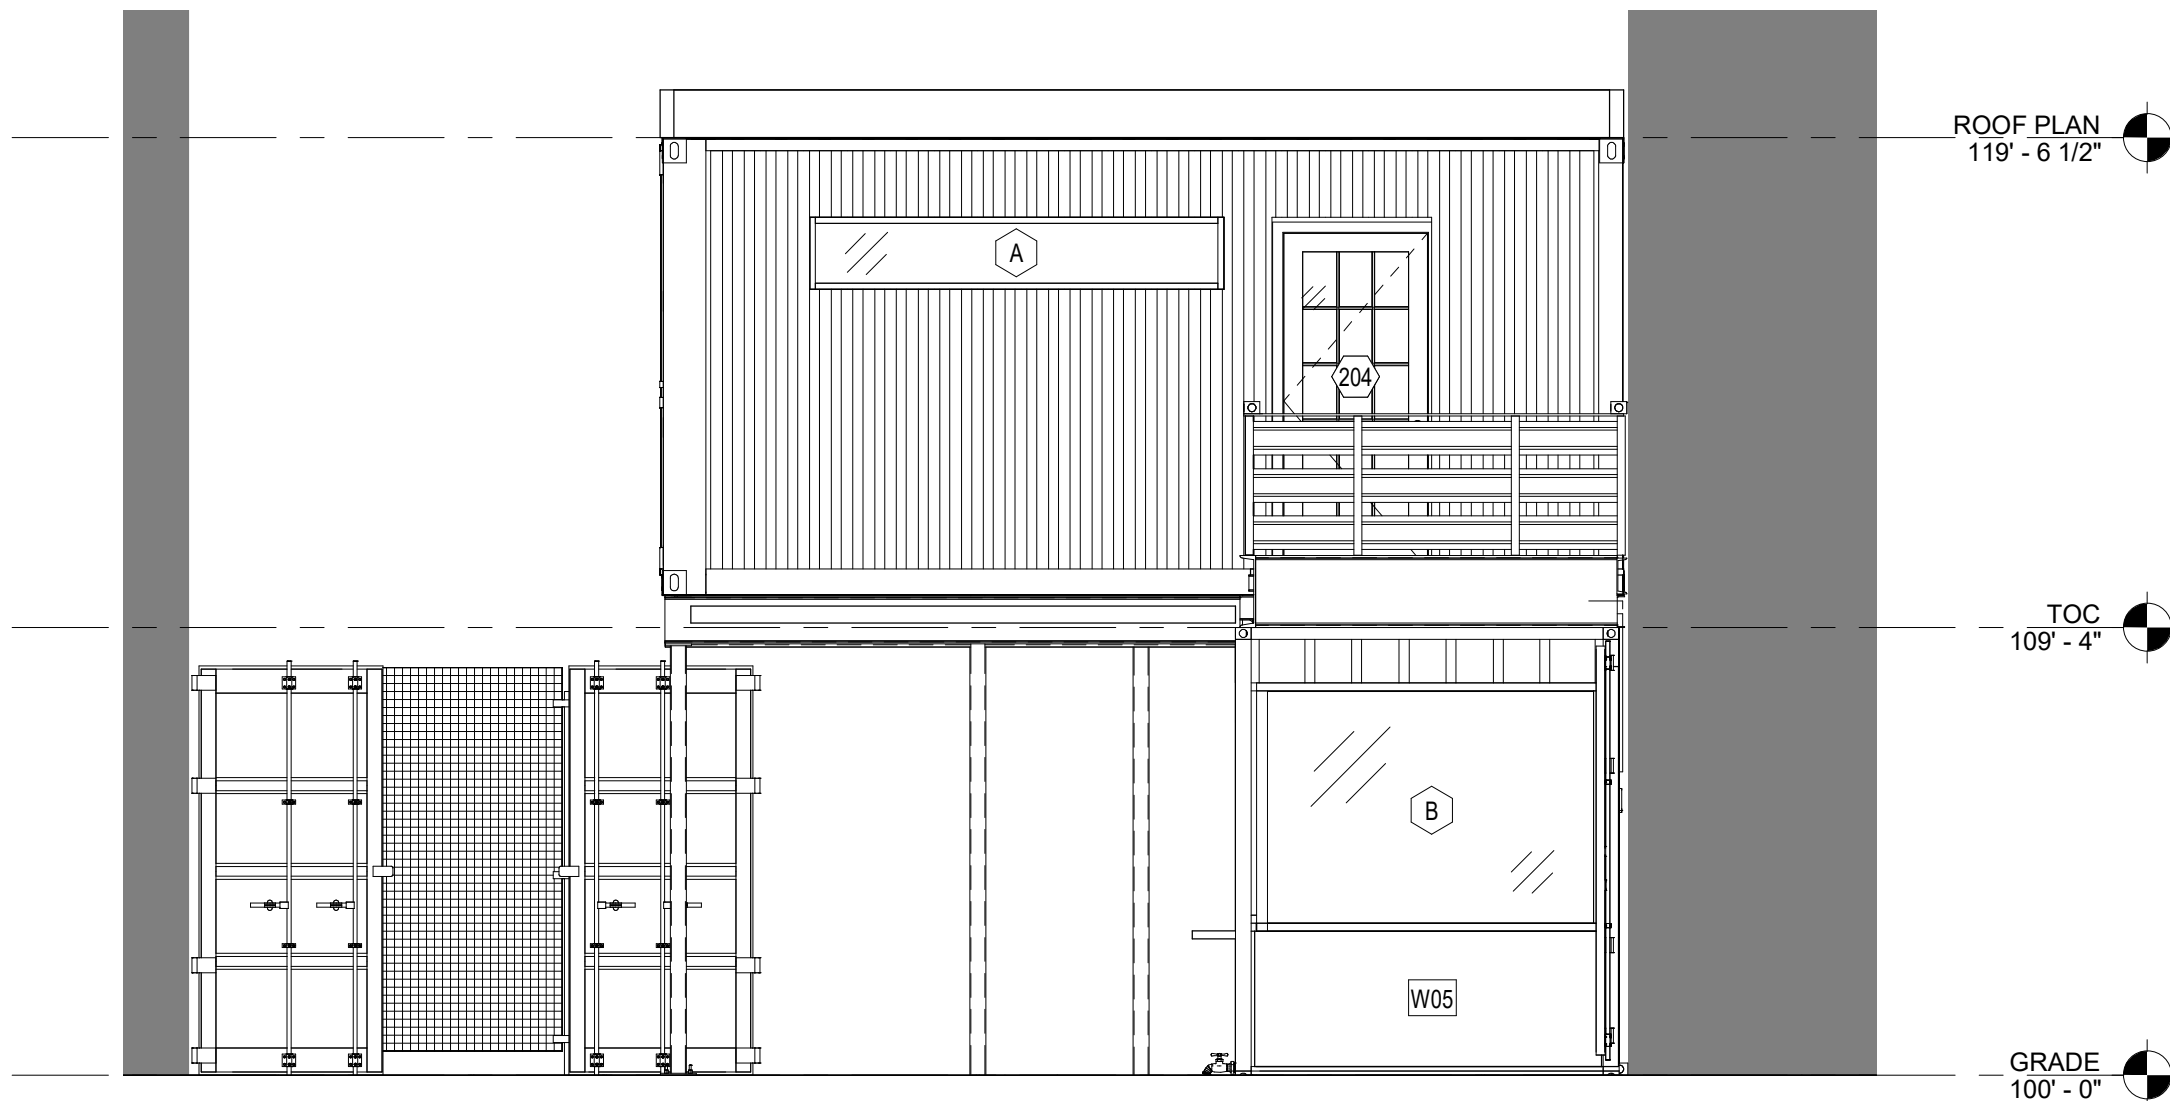


**3** MAIN STREET ELEVATION  
1/4" = 1'-0"




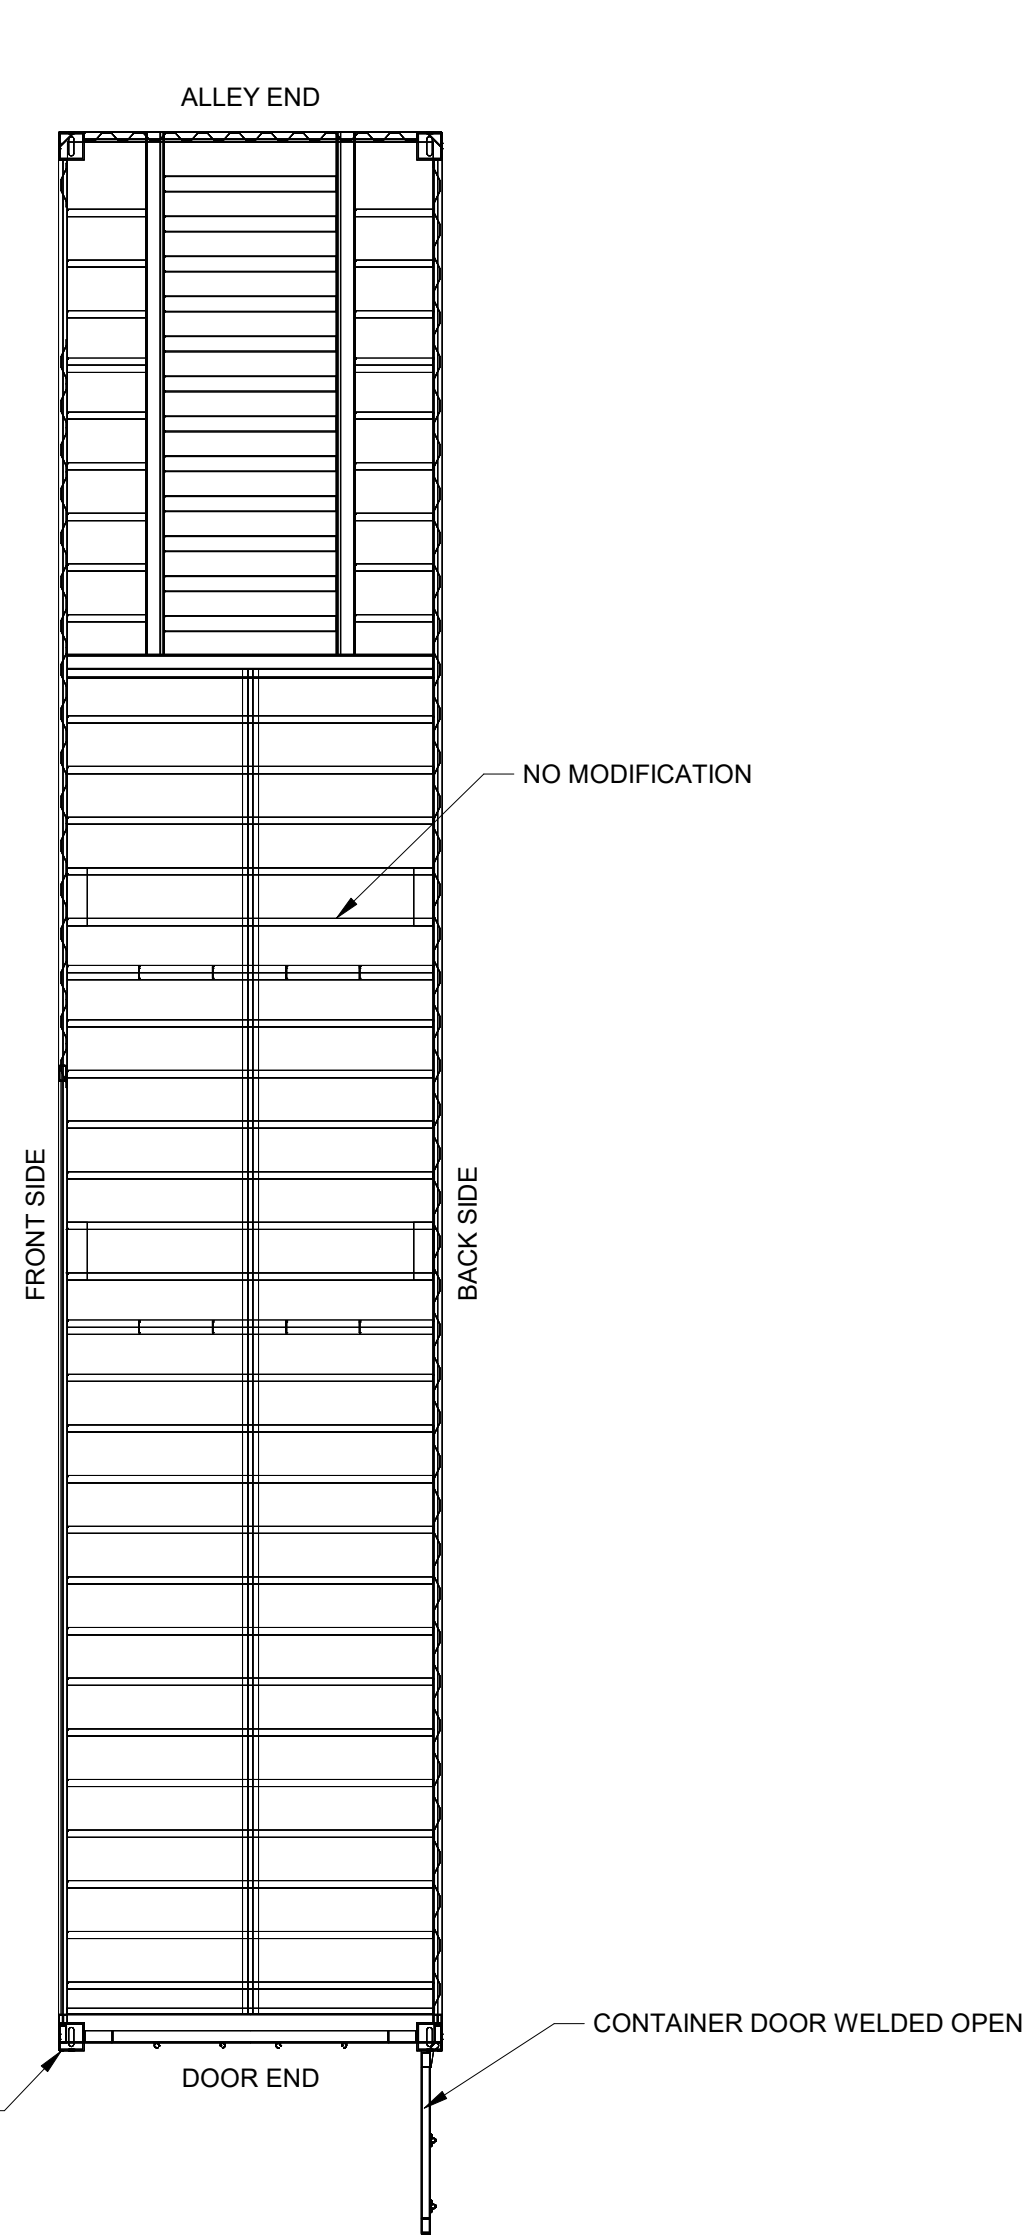


6 COFFEE SHOP CONTAINER BOTTOM  
1/4" = 1'-0"

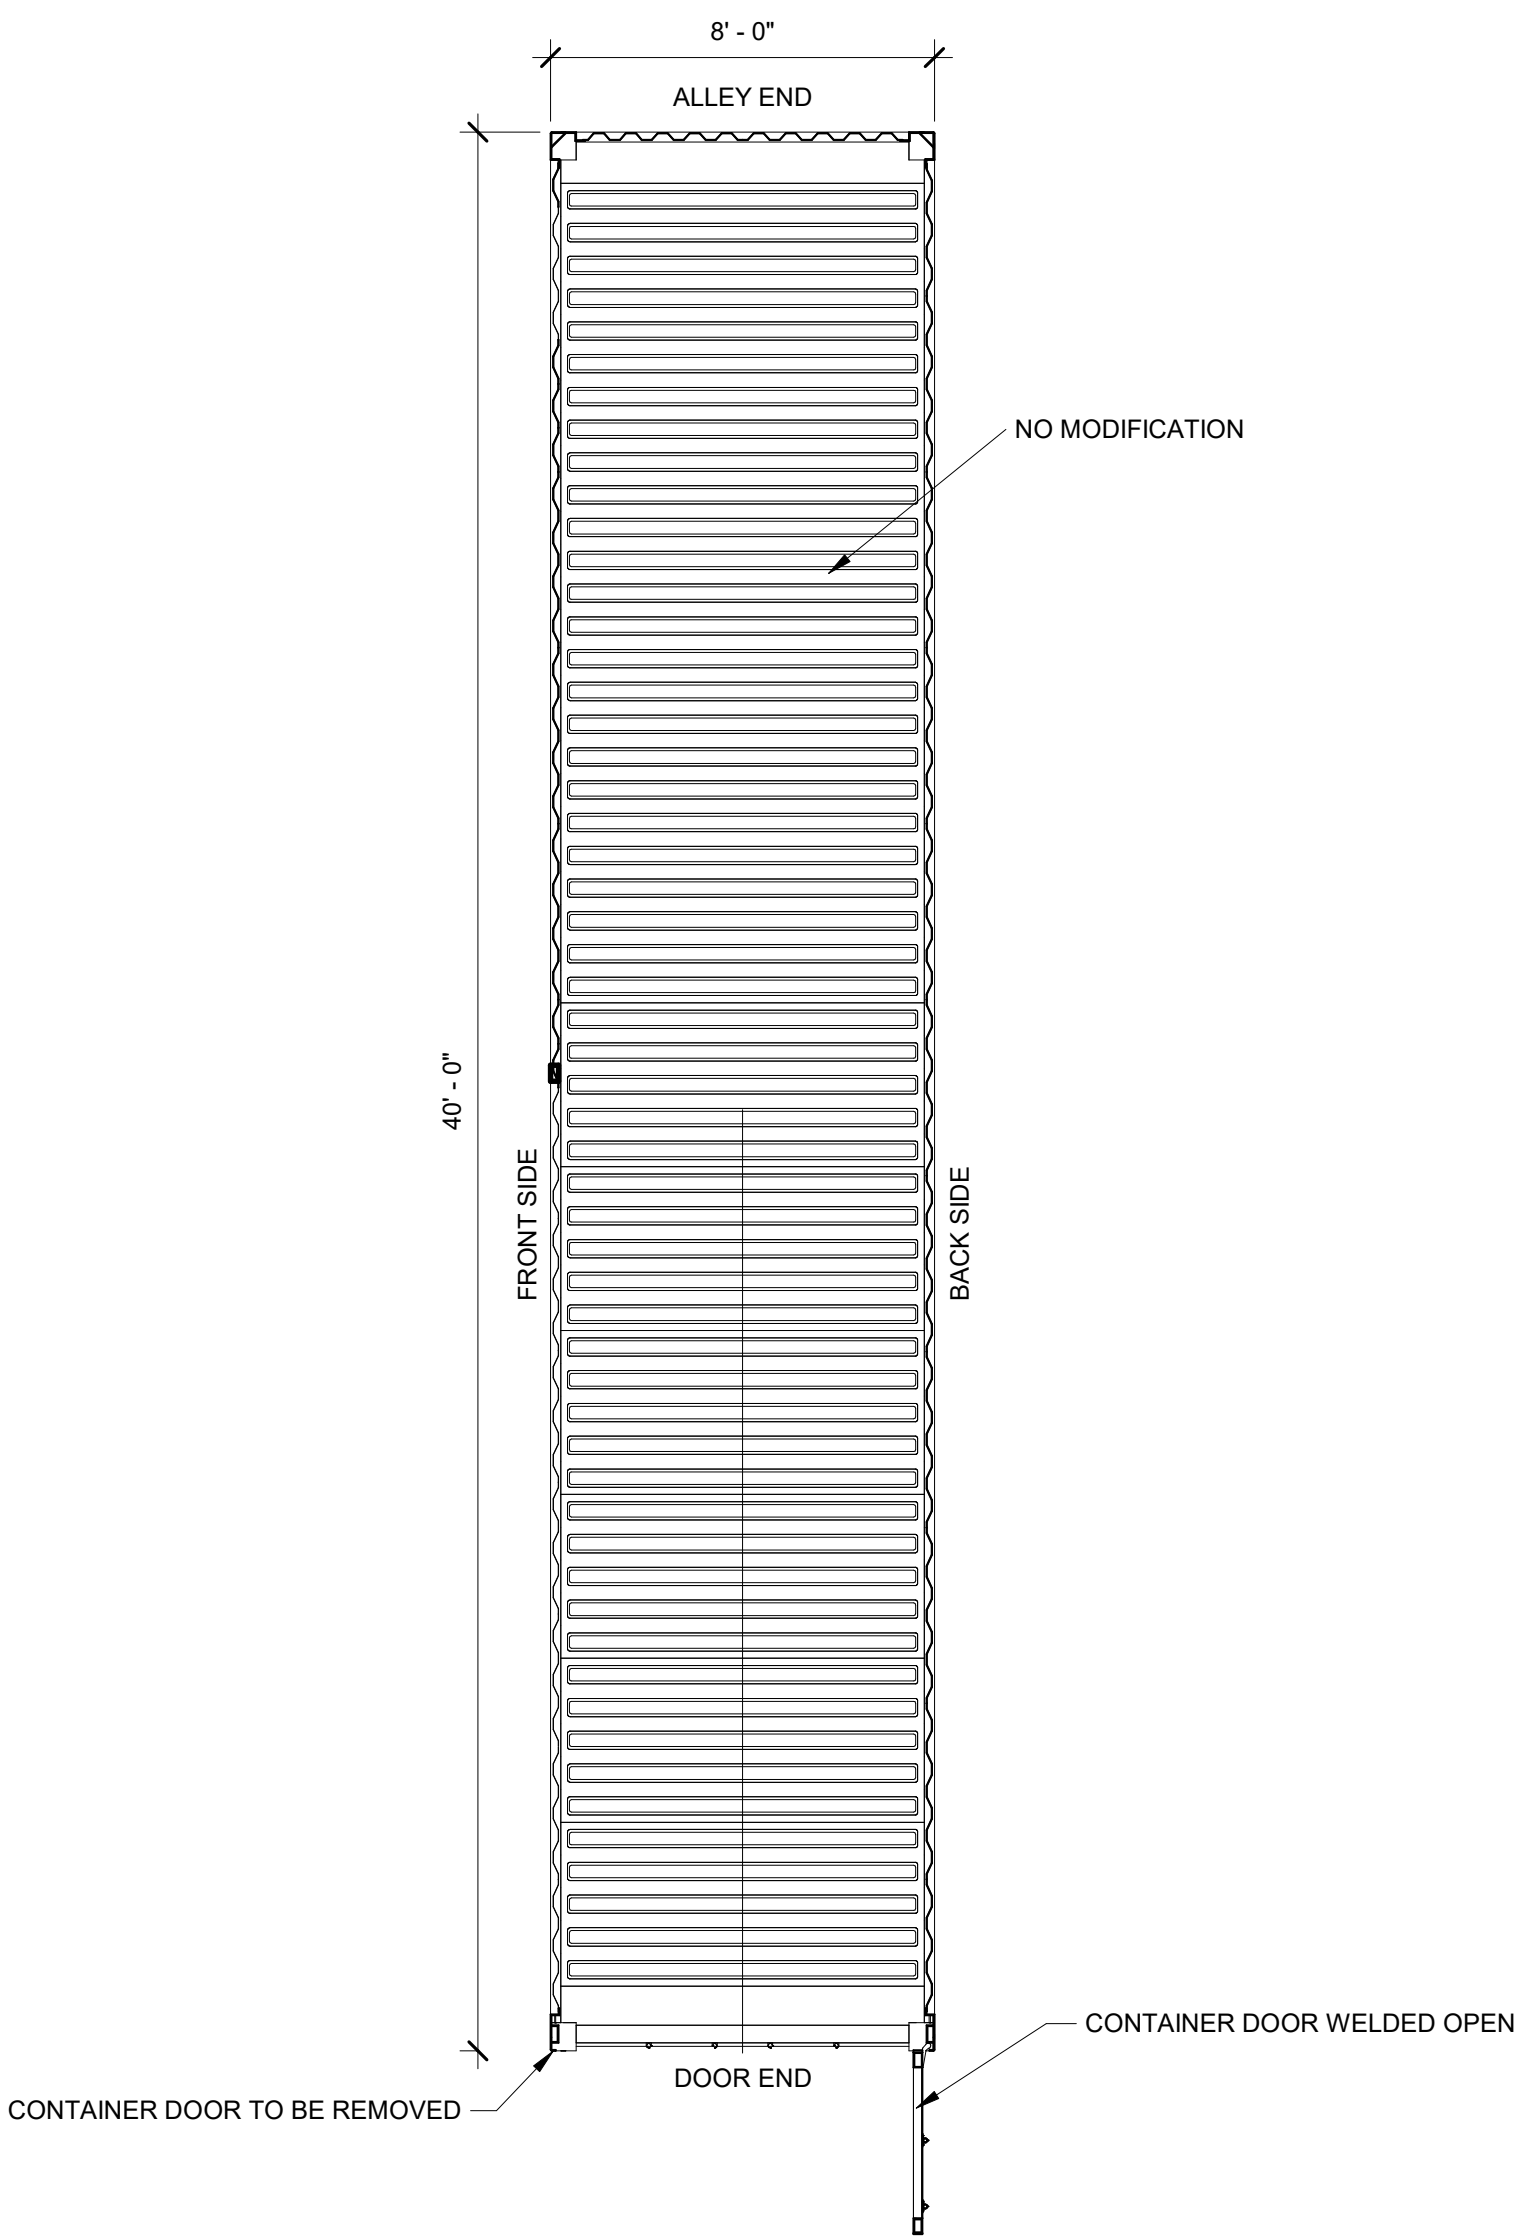


5 COFFEE SHOP CONTAINER ROOF  
1/4" = 1'-0"

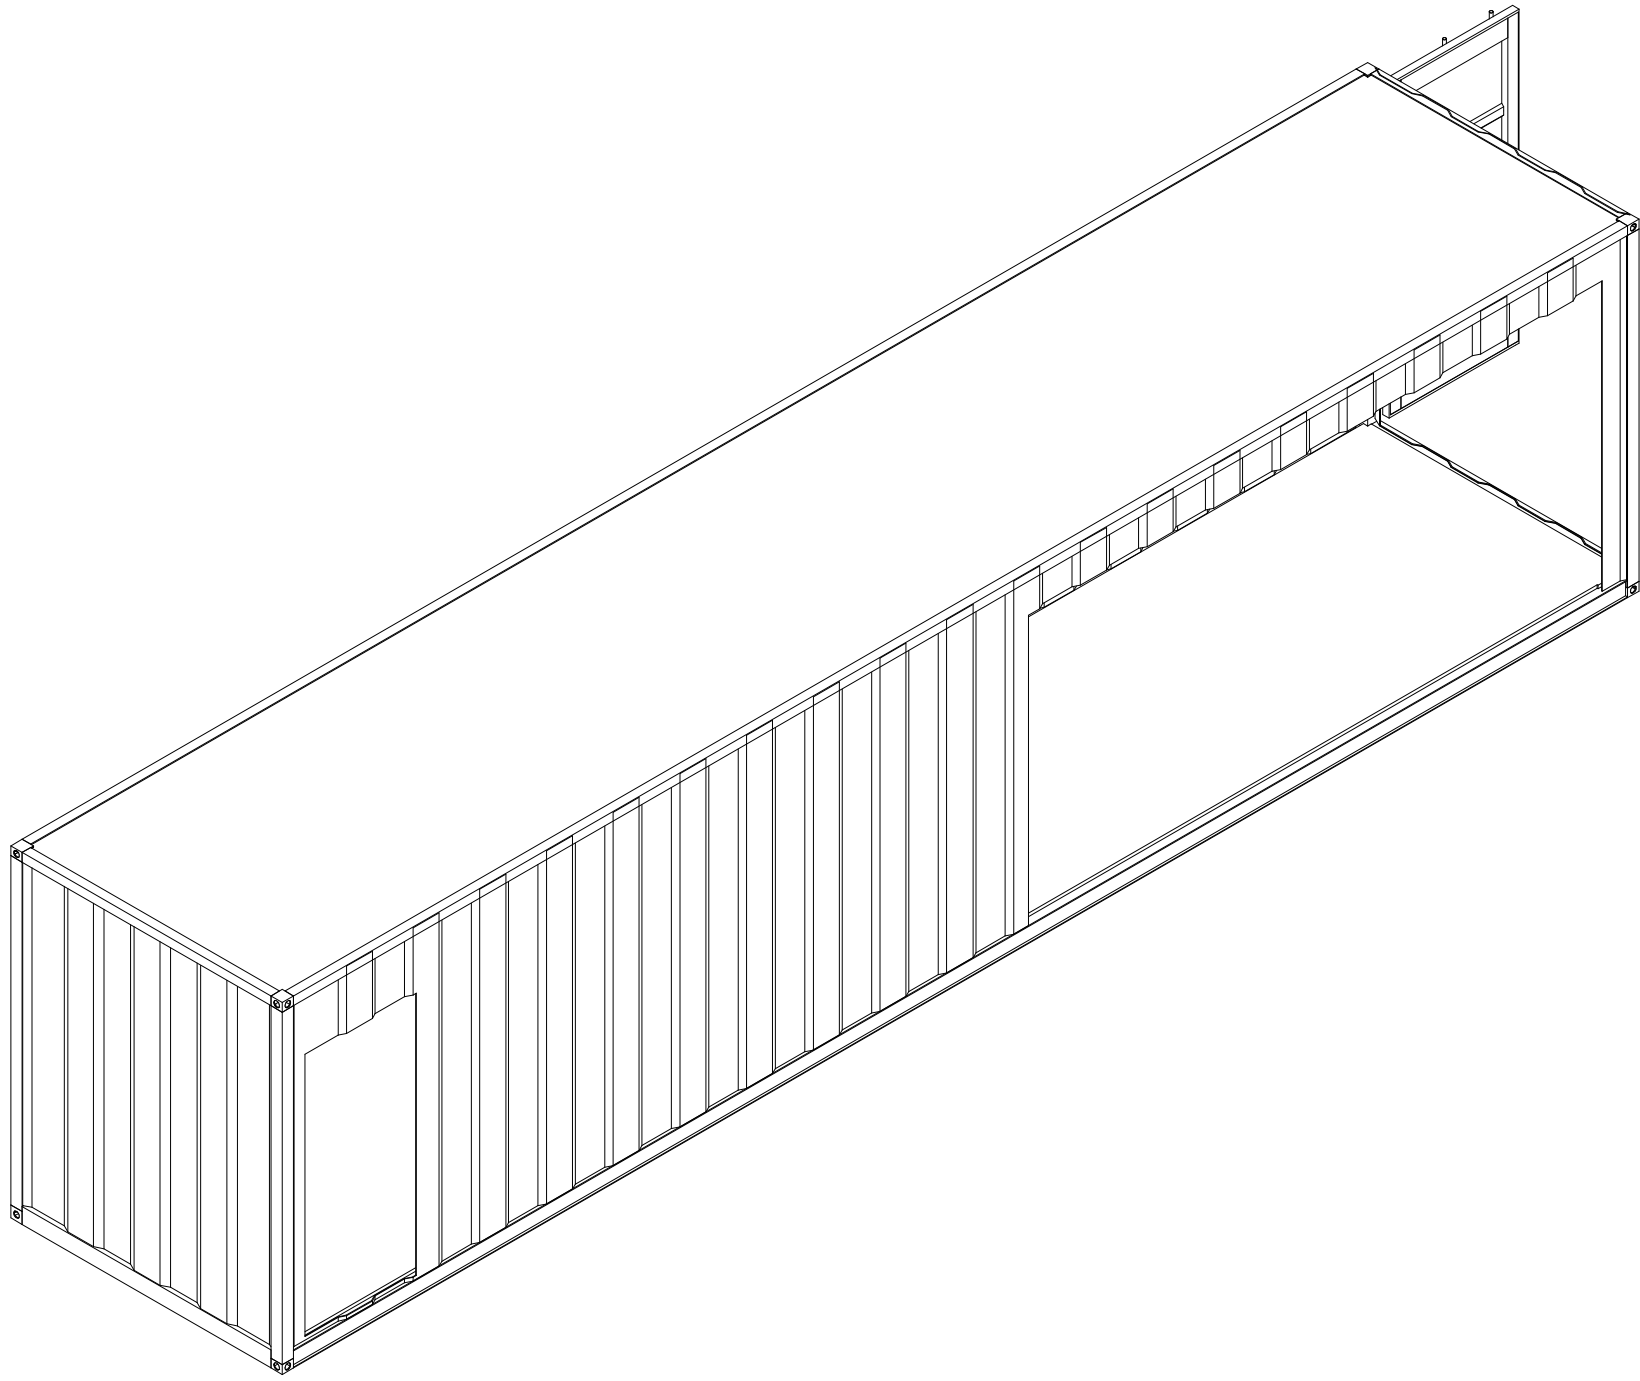


7 3D CONTAINER COFFEE SHOP (1)

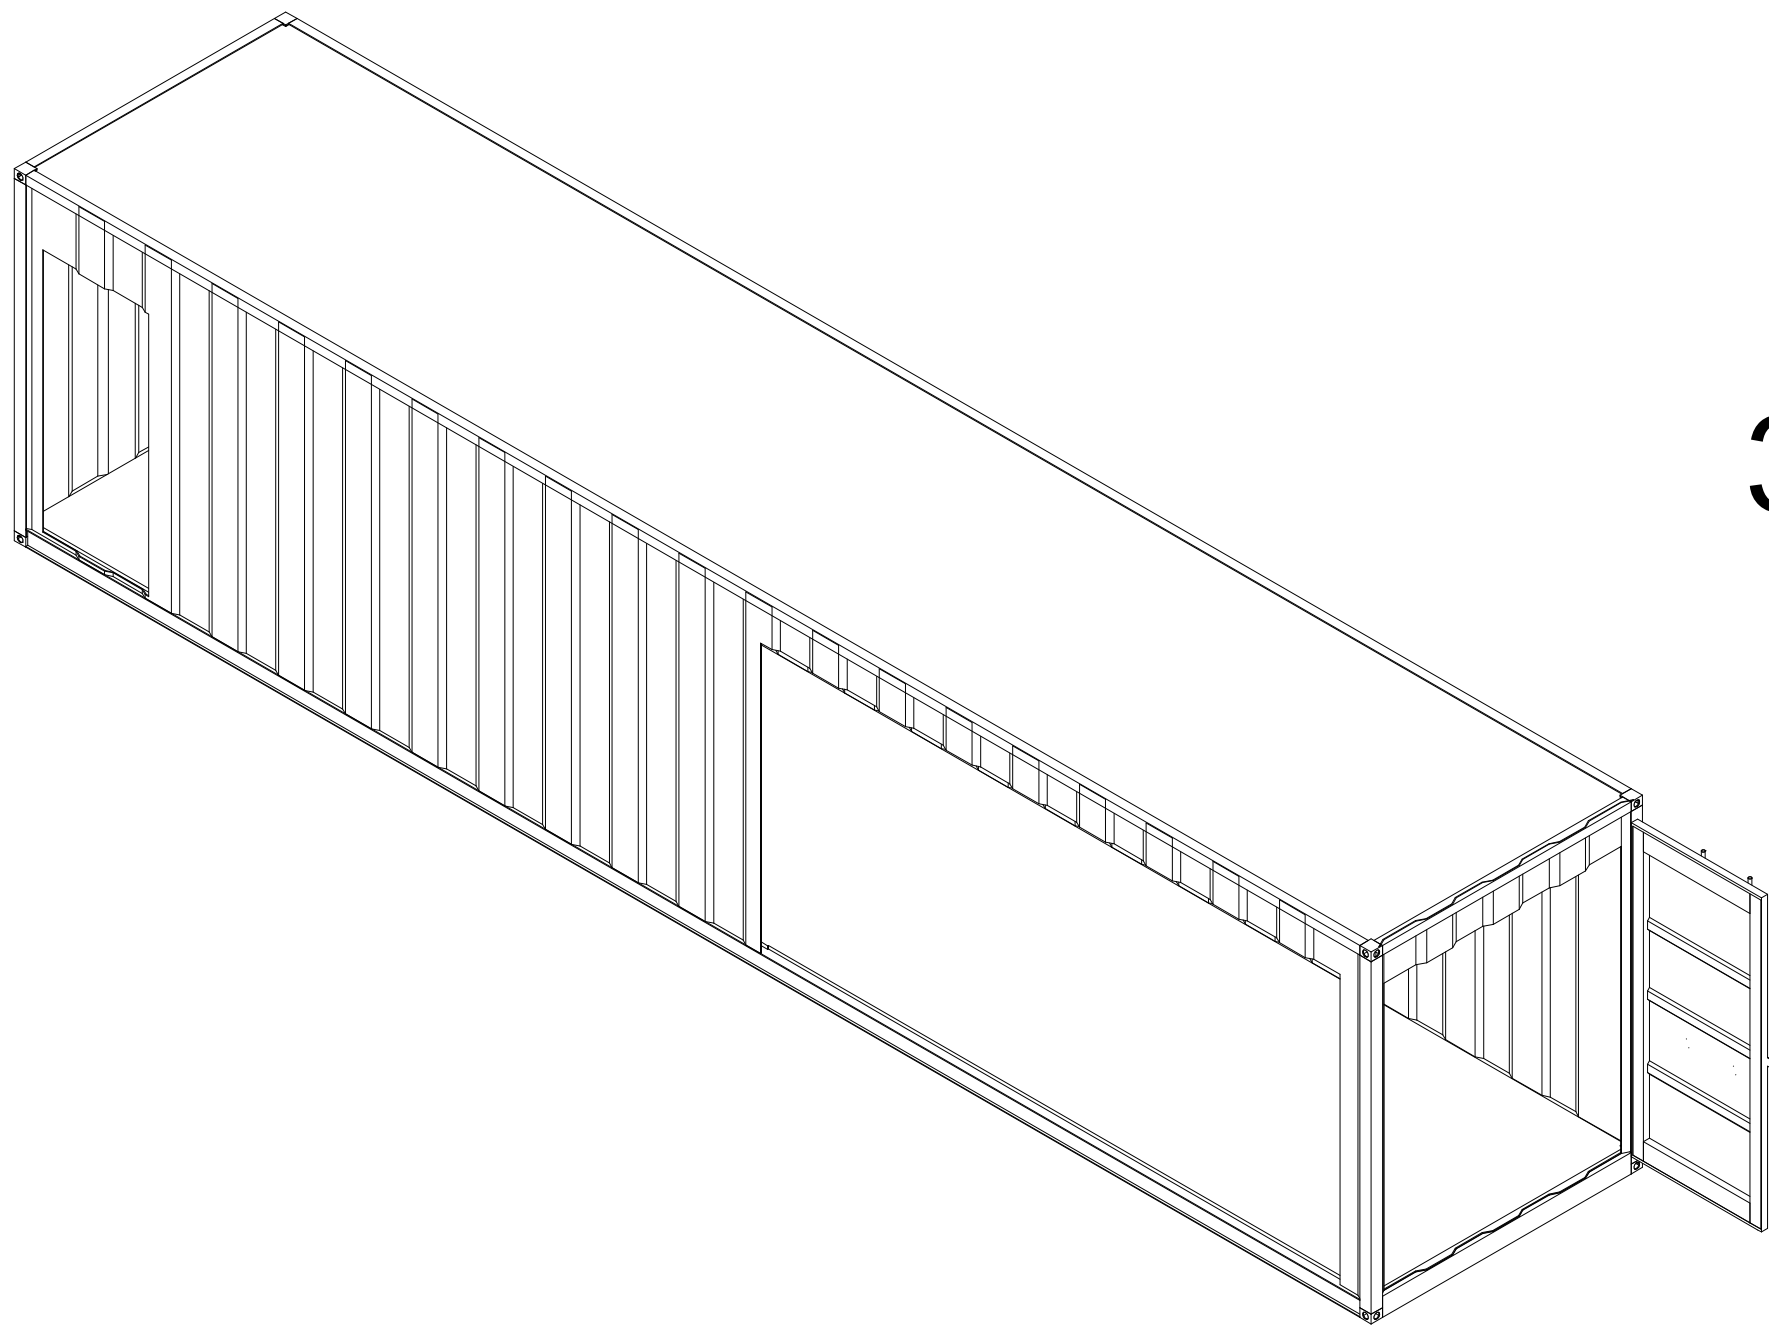


8 3D CONTAINER COFFEE SHOP (2)

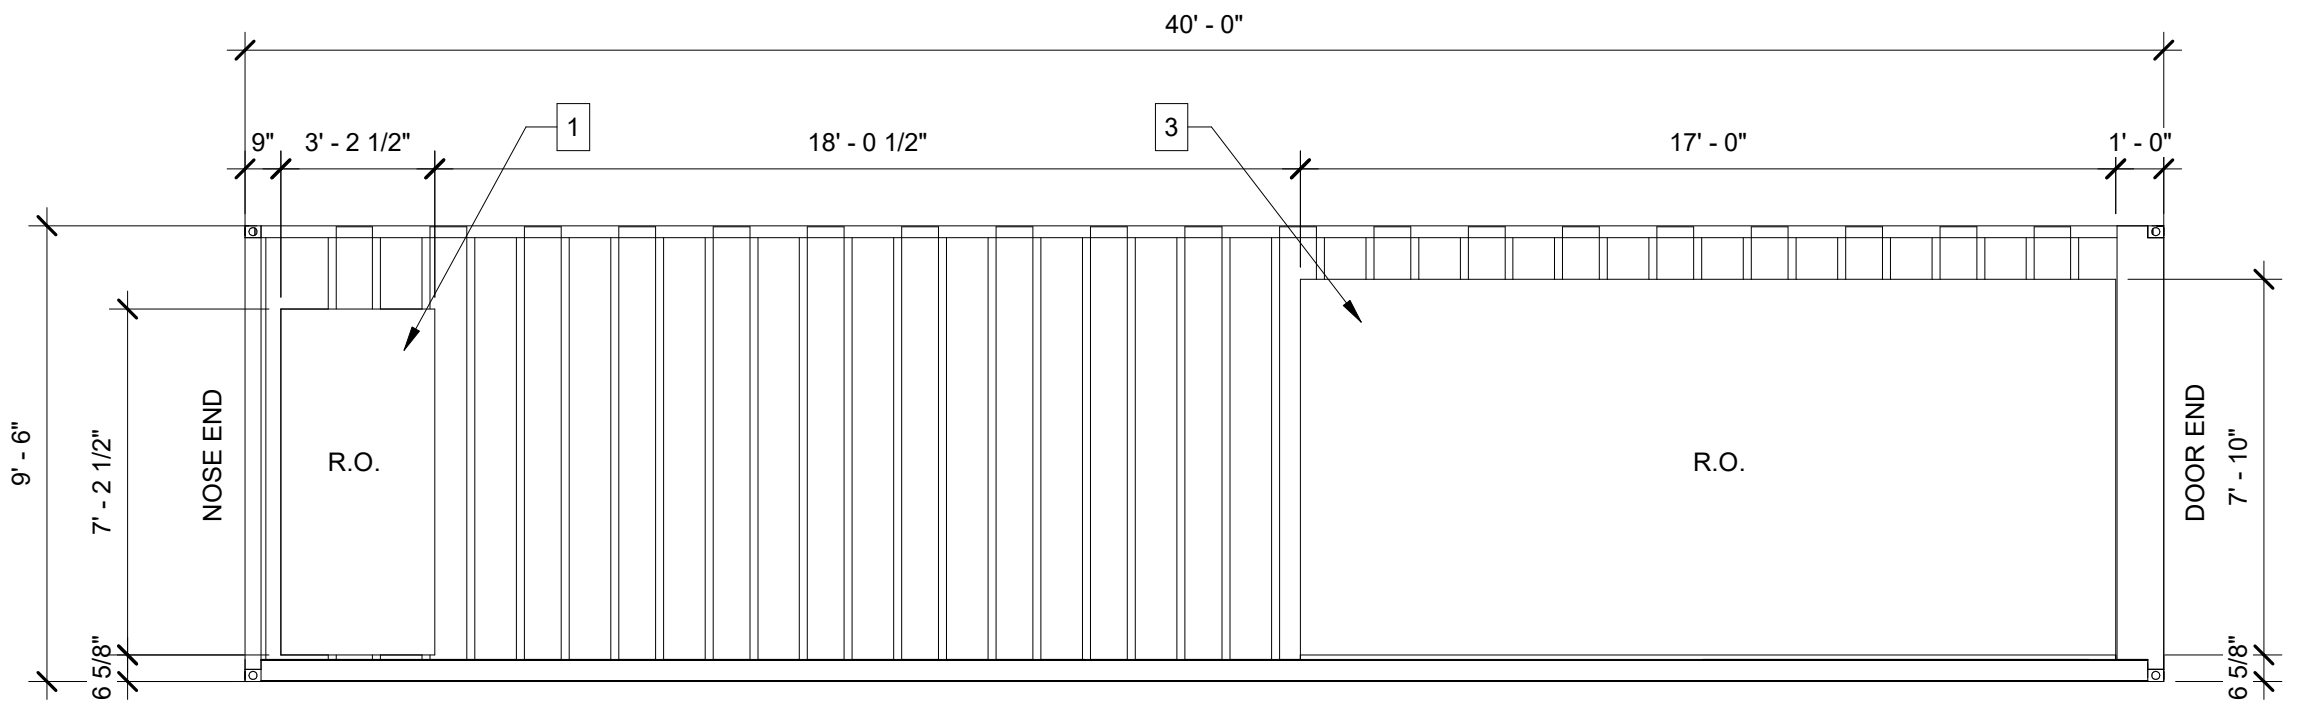


1 COFFEE SHOP CONTAINER FRONT SIDE  
1/4" = 1'-0"

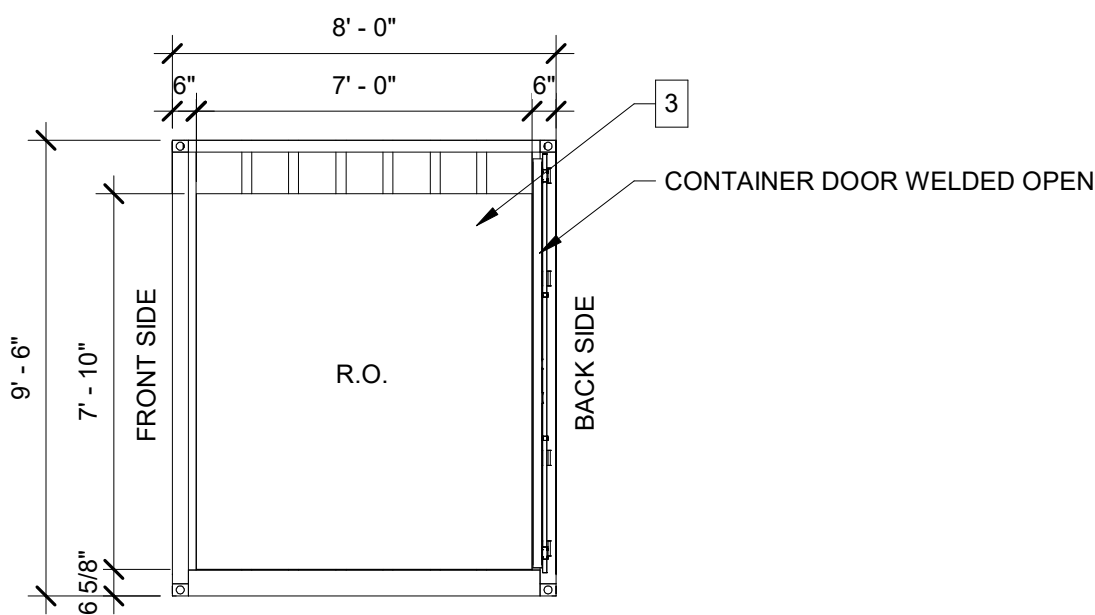

2 COFFEE SHOP CONTAINER ELEVATION DOOR END  
1/4" = 1'-0"

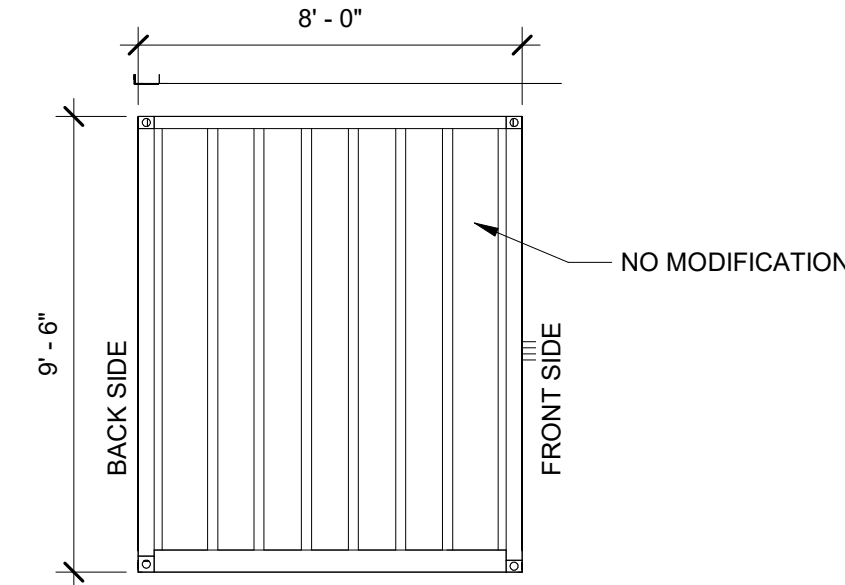

3 COFFEE SHOP CONTAINER NOSE END  
1/4" = 1'-0"

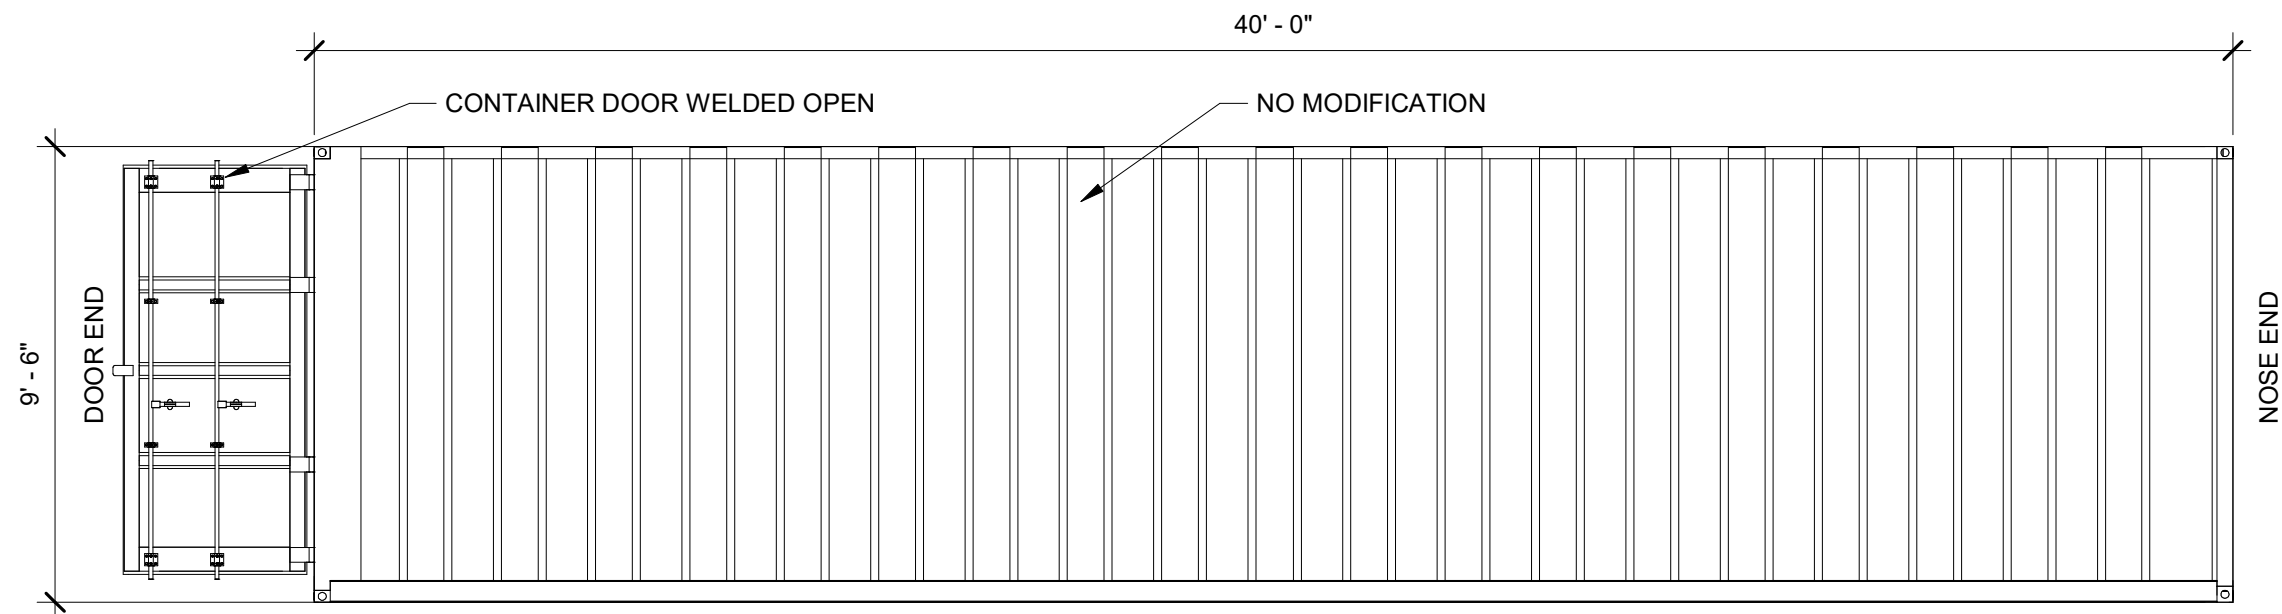


4 COFFEE SHOP BACK SIDE  
1/4" = 1'-0"

### GENERAL CONTAINER NOTES:

- CUT OPENINGS AT FACTORY PRIOR TO LOOSE SHIPMENT.
- DRAWINGS HAVE ADDED 2-1/2" OVERALL VERTICALLY AND 2-1/2" OVERALL HORIZONTALLY TO ALL ROUGH DOOR OPENINGS.
- DRAWINGS HAVE ADDED 3/4" OVERALL VERTICALLY AND 3/4" OVERALL HORIZONTALLY TO ALL ROUGH WINDOW AND STOREFRONT OPENINGS.

### CONTAINER SHEET NOTES:

- DOOR OPENING.
- WINDOW OPENING.
- STOREFRONT OPENING.
- STRUCTURE, RE: STRUCTURAL DRAWINGS.

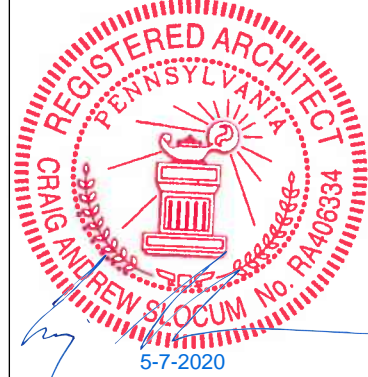

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**CONTAINER COFFEE SHOP**  
**79 SOUTH MAIN STREET**  
**PITTSBURGH, PA**

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CRAIG A. SLOCUM, ARCHITECT

### AGENCY SET

PROJECT 19176	DATE 05-07-2020
DRAWN LMV	CHECKED JSG / CAS


REVISED

SHEET **COFFEE SHOP CONTAINER CUTOUTS**


SHEET

**A52**  
ORIGINAL SHEET SIZE  
24" x 36"




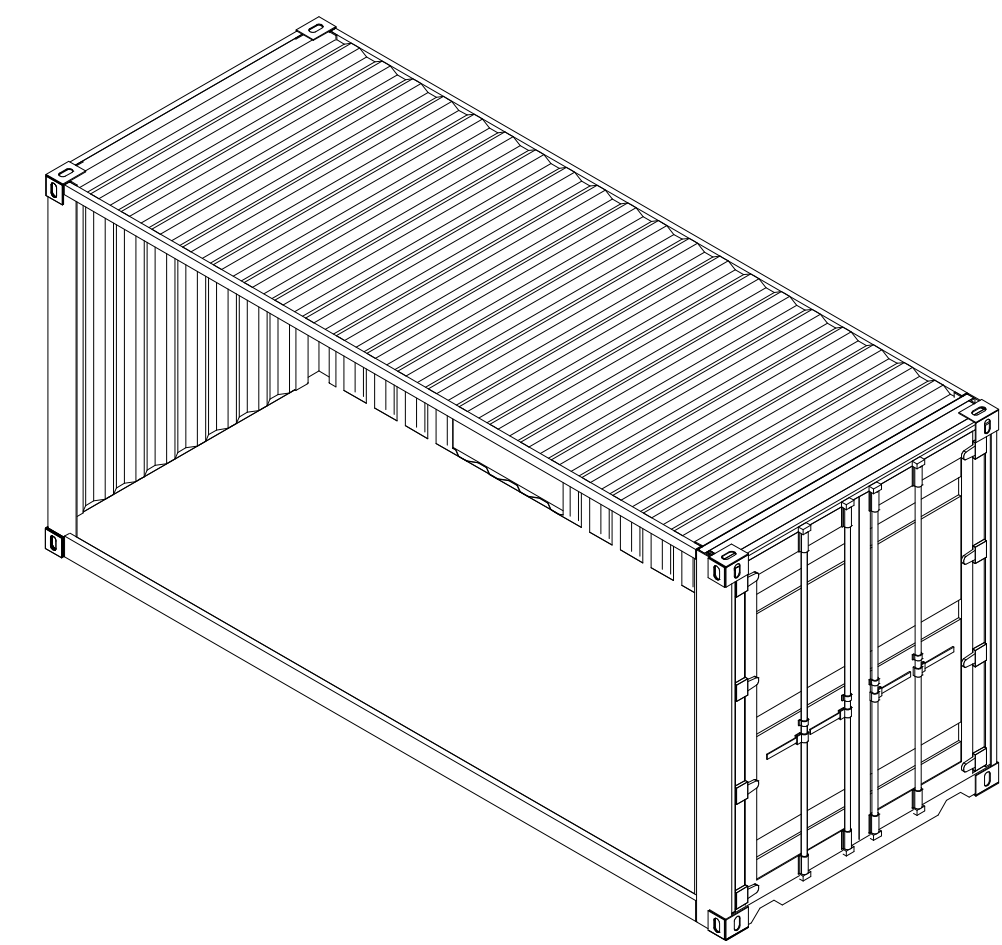


8 3D CONTAINER 1 (1)

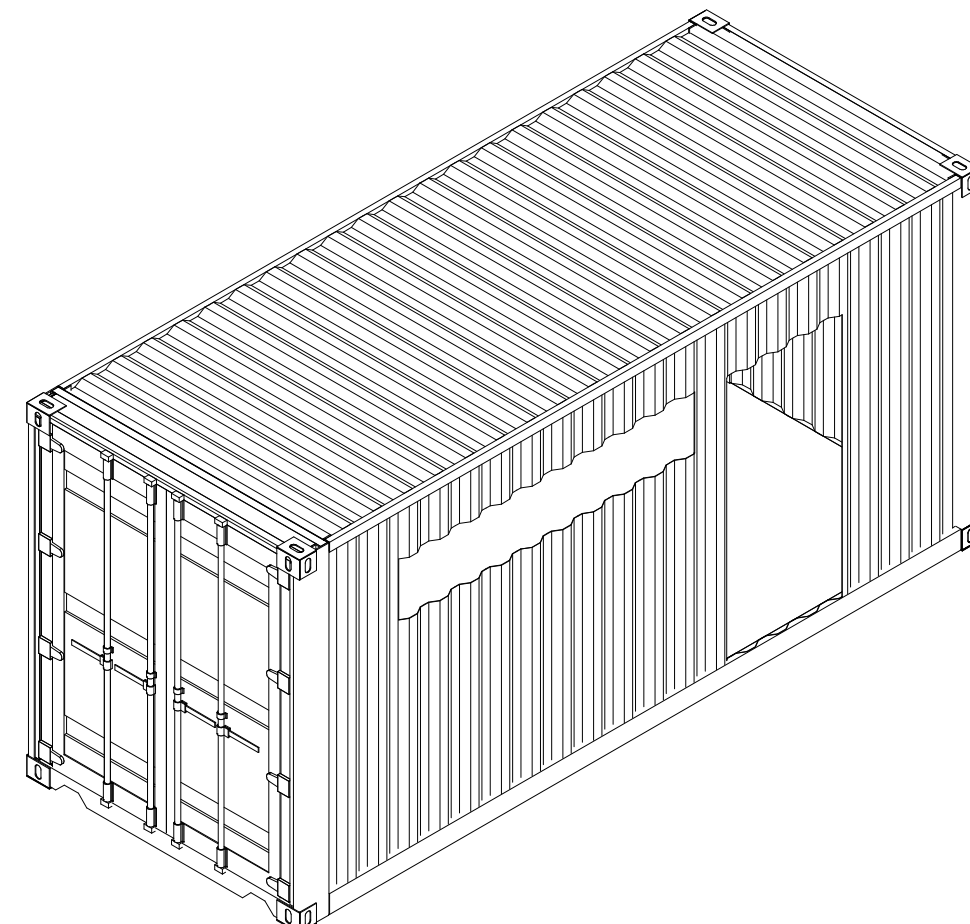


9 3D CONTAINER 1 (2)

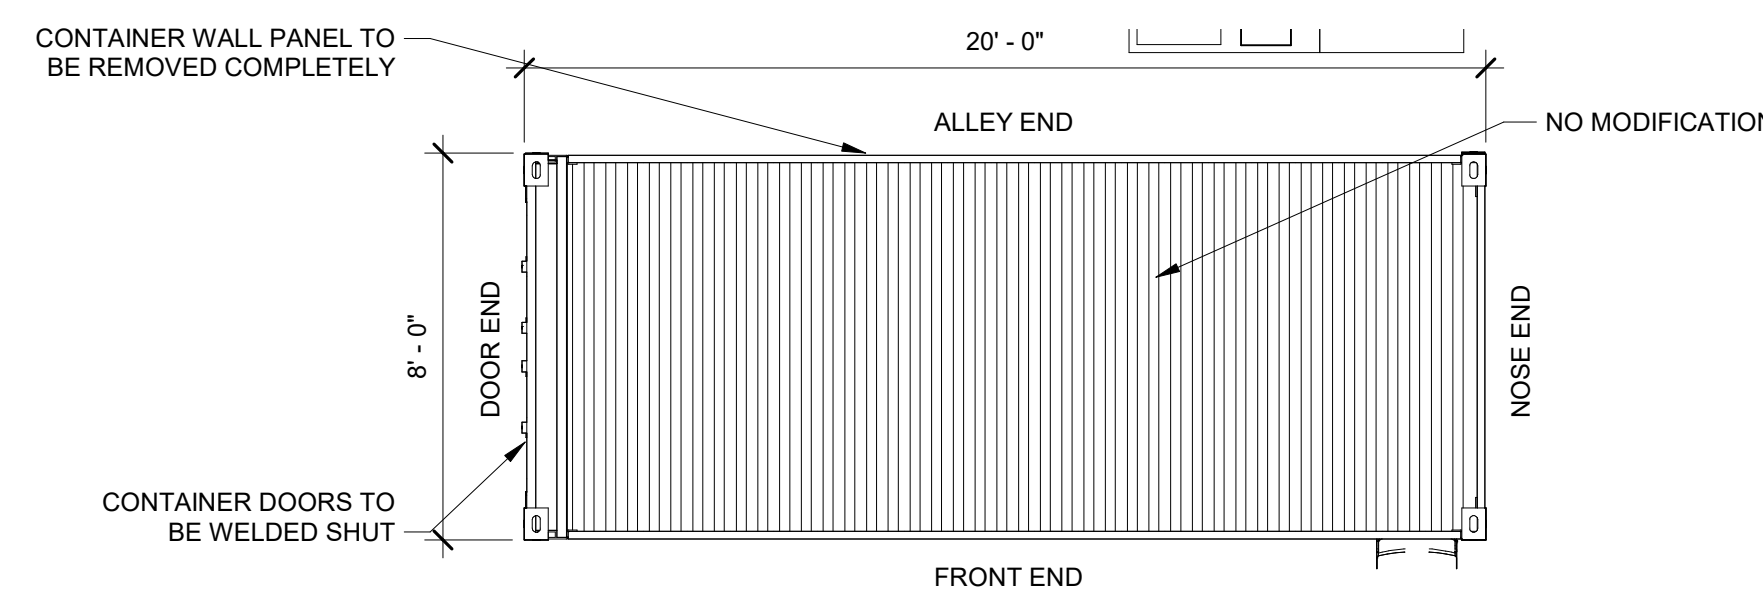


5 APARTMENT CONTAINER 1 ROOF  
1/4" = 1'-0"

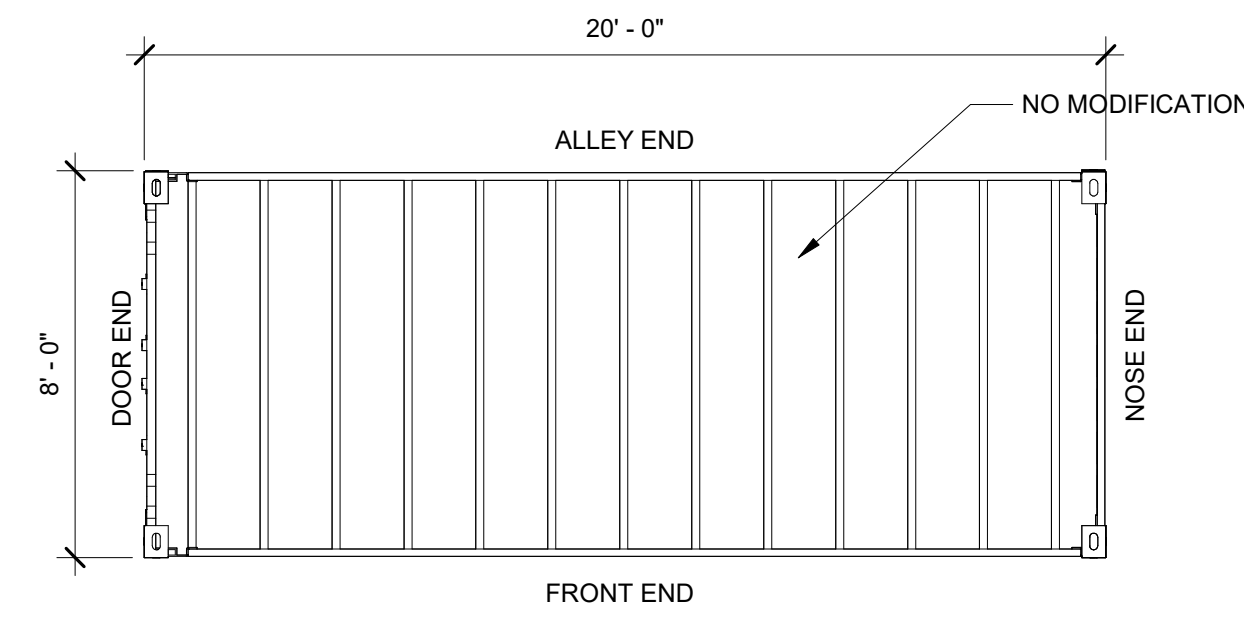


6 APARTMENT CONTAINER 1 BOTTOM  
1/4" = 1'-0"

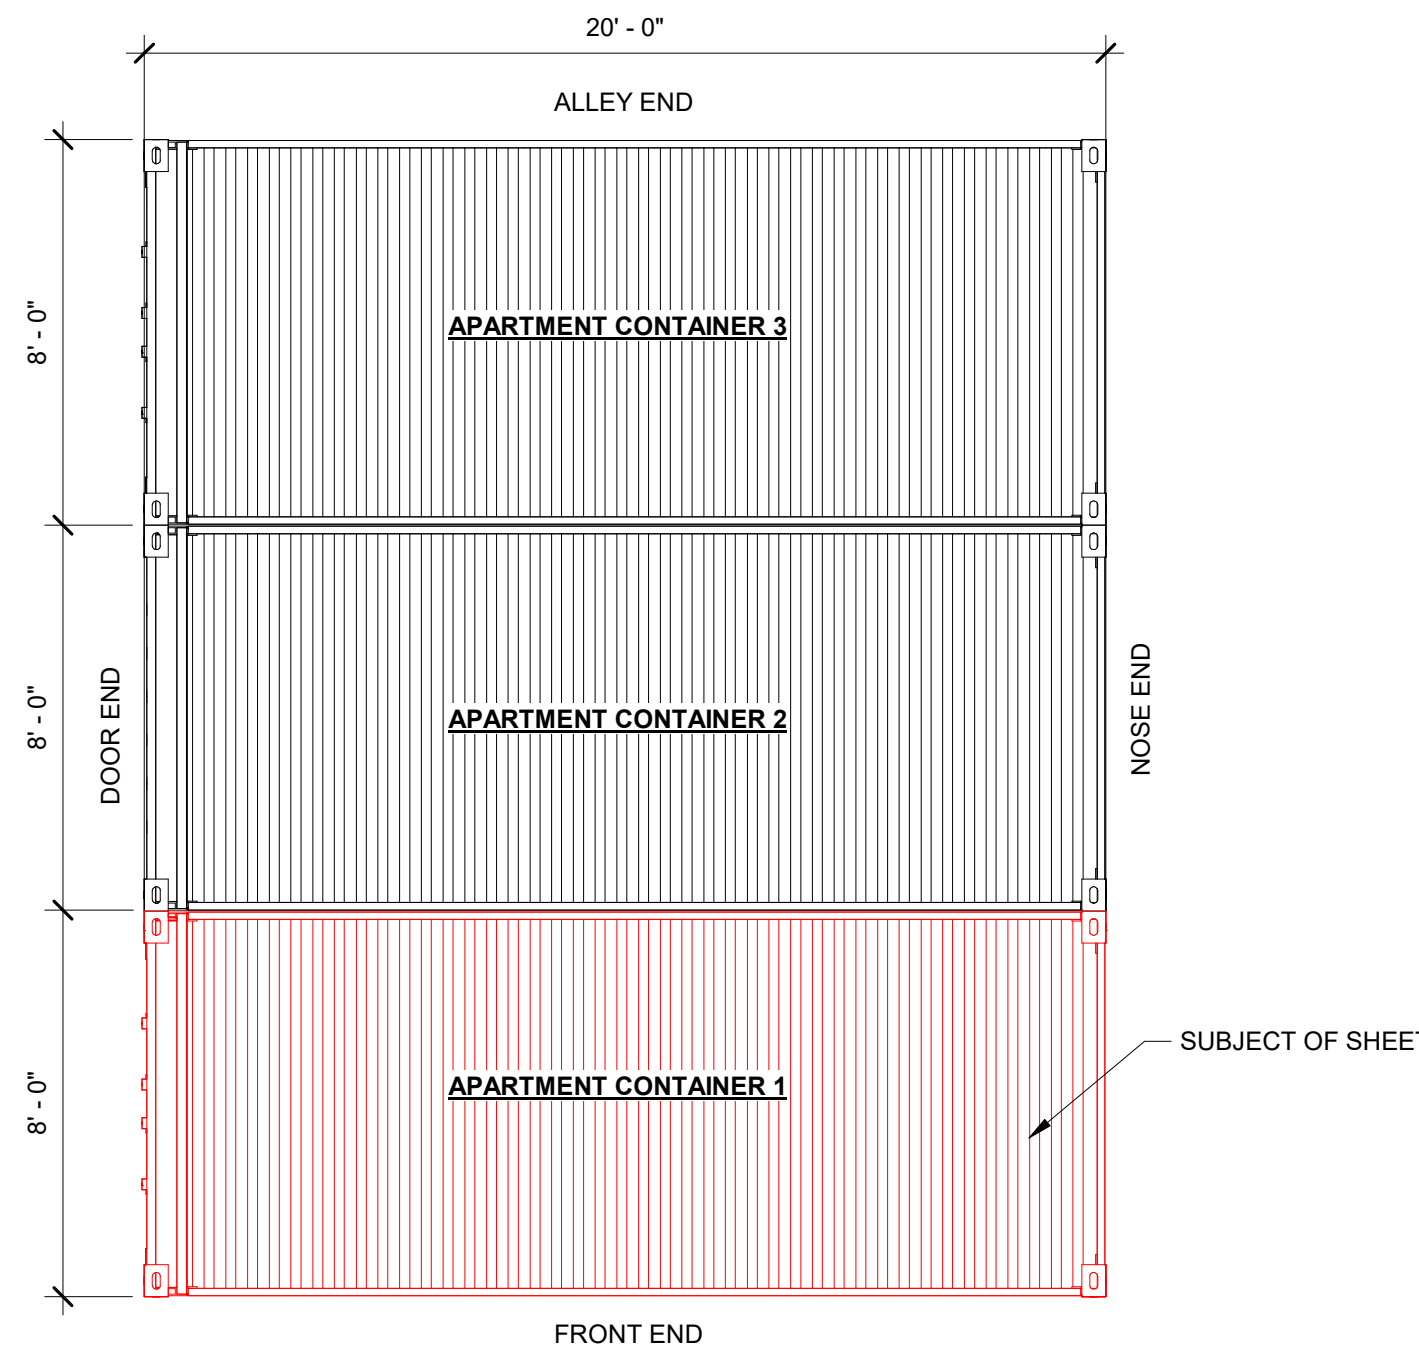


7 APARTMENT CONTAINER KEY PLAN  
1/4" = 1'-0"

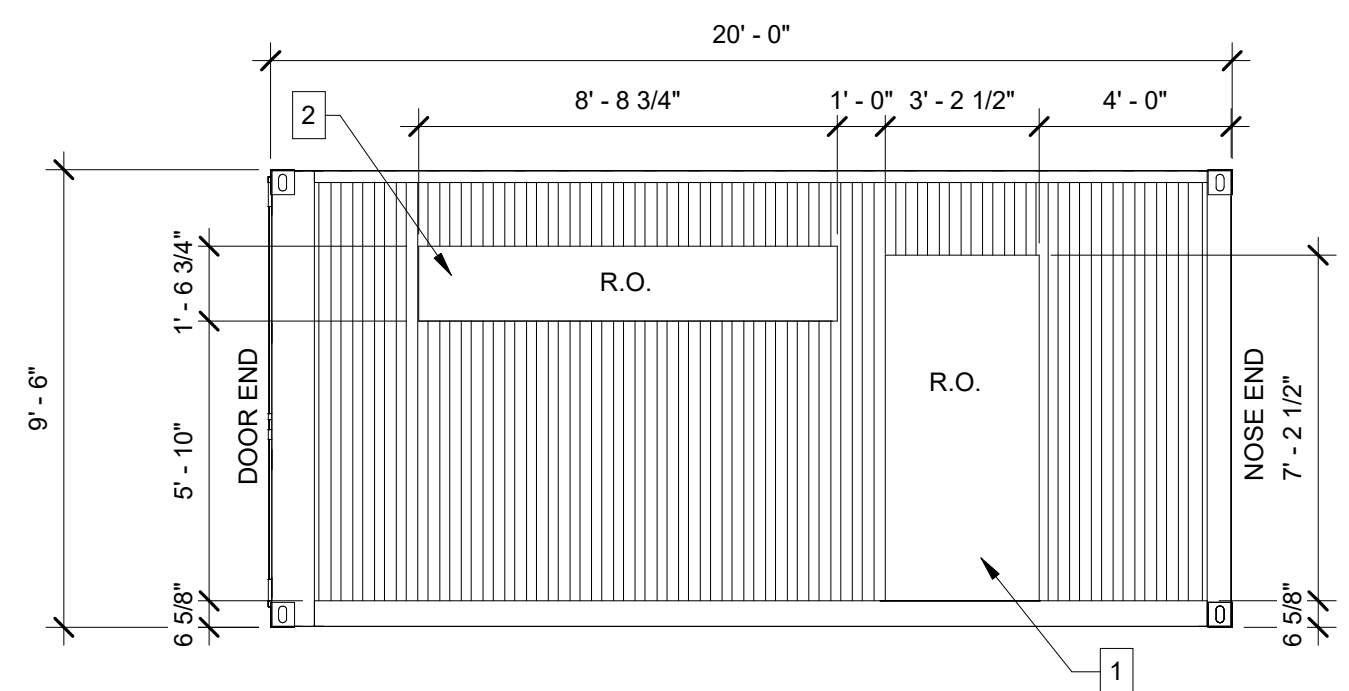


1 APARTMENT CONTAINER 1 FRONT END  
1/4" = 1'-0"

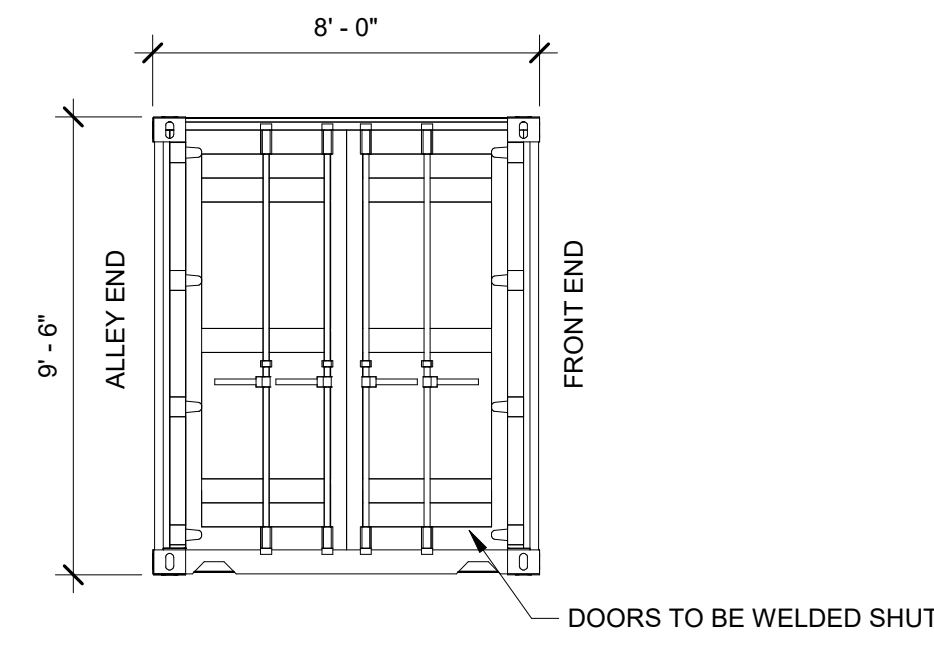

2 APARTMENT CONTAINER 1 DOOR END  
1/4" = 1'-0"

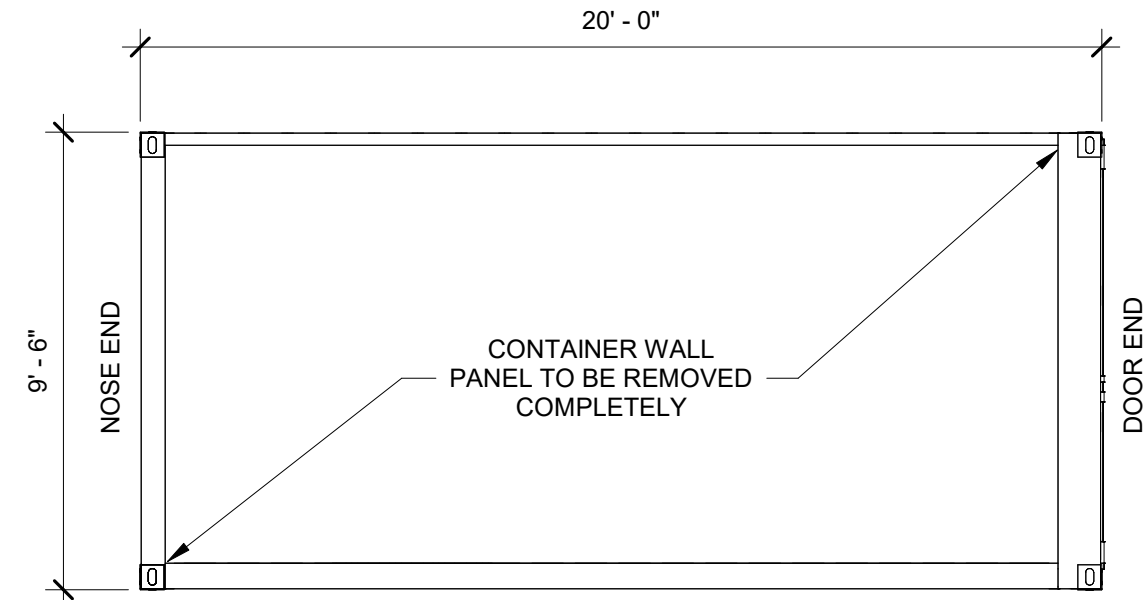

3 APARTMENT CONTAINER 1 ALLEY END  
1/4" = 1'-0"

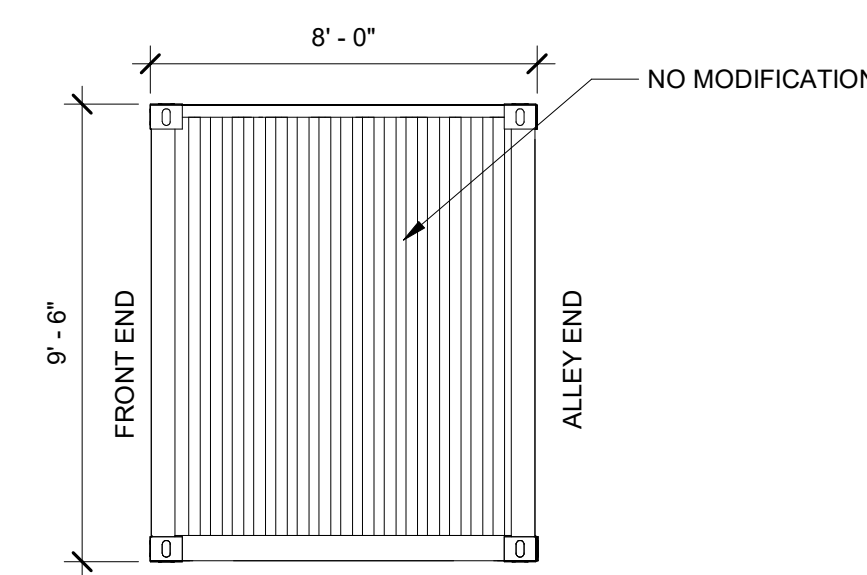

4 APARTMENT CONTAINER 1 BACK END  
1/4" = 1'-0"

GENERAL  
CONTAINER NOTES:

A. CUT OPENINGS AT FACTORY PRIOR TO LOOSE SHIPMENT.

B. DRAWINGS HAVE ADDED 2-1/2" OVERALL VERTICALLY AND 2-1/2" OVERALL HORIZONTALLY TO ALL ROUGH DOOR OPENINGS.

C. DRAWINGS HAVE ADDED 3/4" OVERALL VERTICALLY AND 3/4" OVERALL HORIZONTALLY TO ALL ROUGH WINDOW AND STOREFRONT OPENINGS.

CONTAINER SHEET  
NOTES:

1. DOOR OPENING.

2. WINDOW OPENING.

3. STOREFRONT OPENING.

4. STRUCTURE, RE: STRUCTURAL DRAWINGS.

REGISTERED ARCHITECT  
PENNSYLVANIA  
CRAIG A. SLOCUM No. 00448334  
5-7-2020

CRAIG A. SLOCUM, ARCHITECT  
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CRAIG A. SLOCUM, ARCHITECT

AGENCY SET

PROJECT  
19176

DATE  
05-07-2020

DRAWN  
LMV

CHECKED  
JSG / CAS

REVISED


APARTMENT  
CONTAINER 1  
CUTOUTS

SHEET

A53  
ORIGINAL SHEET SIZE  
24" x 36"

5/26/2020 10:02:55 AM




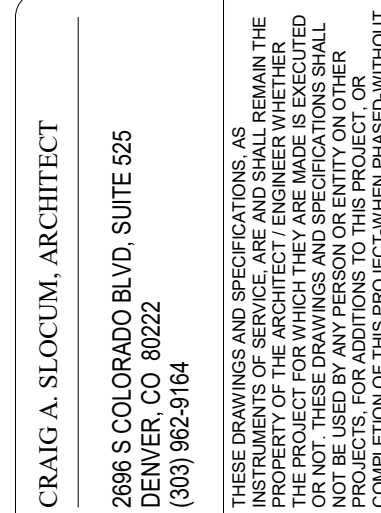

- A. CUT OPENINGS AT FACTORY PRIOR TO LOOSE SHIPMENT.
- B. DRAWINGS HAVE ADDED 2-1/2" OVERALL VERTICALLY AND 2-1/2" OVERALL HORIZONTALLY TO ALL ROUGH DOOR OPENINGS.
- C. DRAWINGS HAVE ADDED 3/4" OVERALL VERTICALLY AND 3/4" OVERALL HORIZONTALLY TO ALL ROUGH WINDOW AND STOREFRONT OPENINGS.

1. DOOR OPENING.
2. WINDOW OPENING.
3. STOREFRONT OPENING.
4. STRUCTURE, RE: STRUCTURAL DRAWINGS

1. DOOR OPENING.
2. WINDOW OPENING.
3. STOREFRONT OPENING.
4. STRUCTURE, RE: STRUCTURAL DRAWINGS

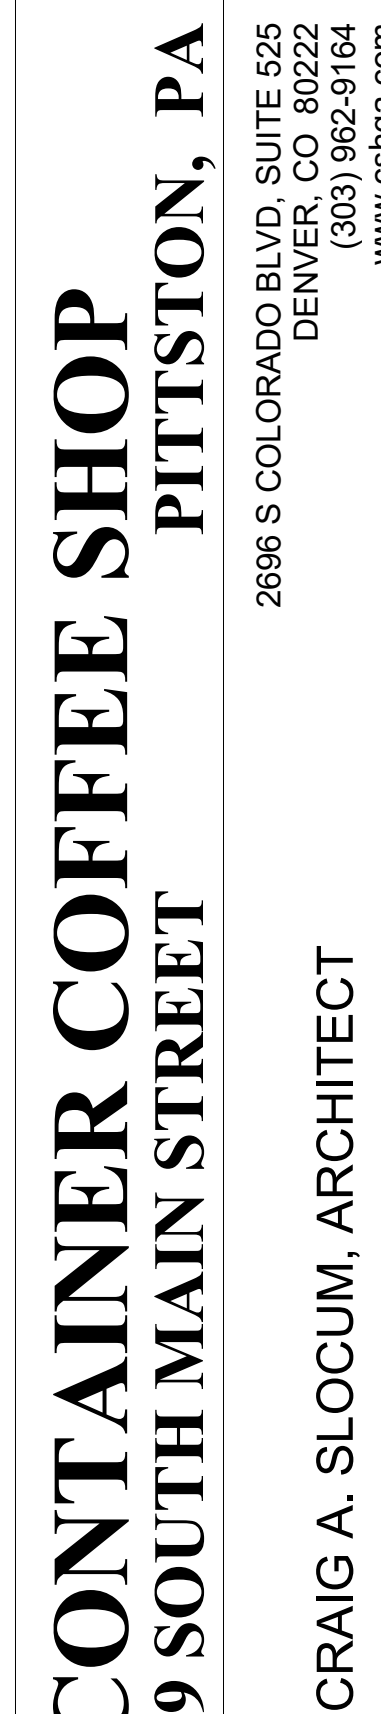


PROJECT 19176	DATE 05-07-202
DRAWN LMV	CHECKED JSG / CAS

## SHEET


**A54**  
ORIGINAL SHEET SIZE  
24" x 36"






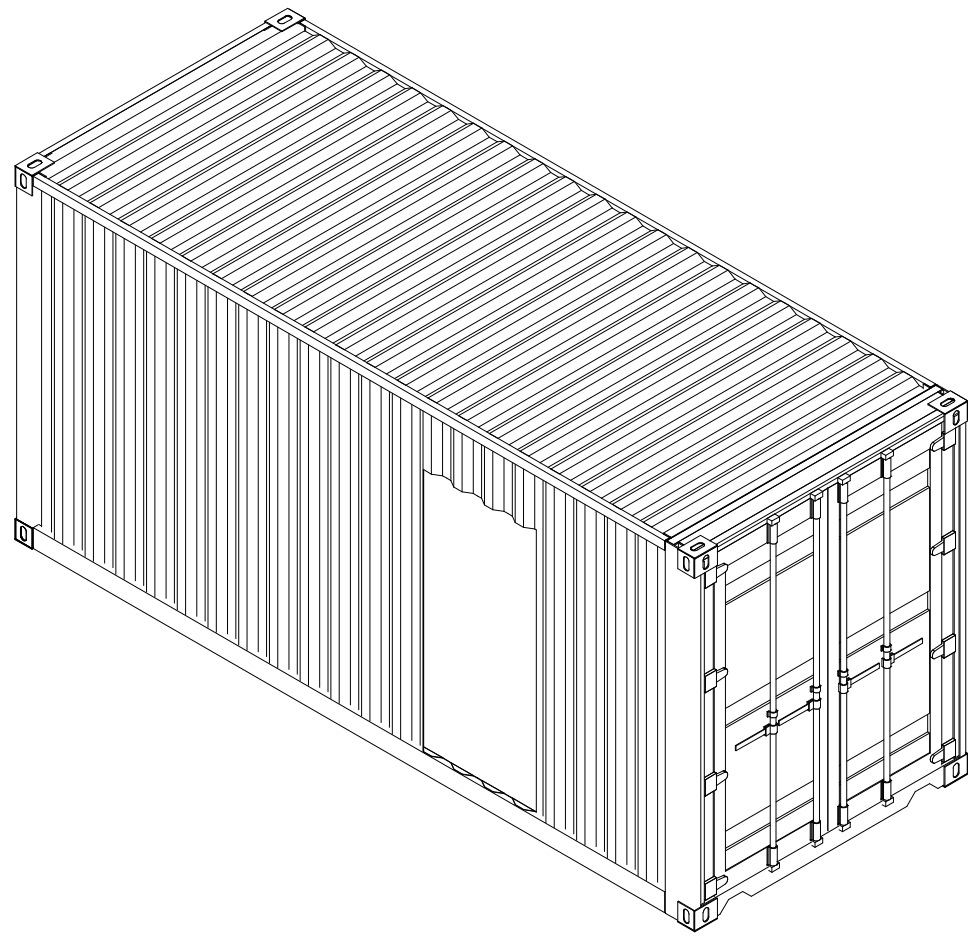


8 3D CONTAINER 3 (1)

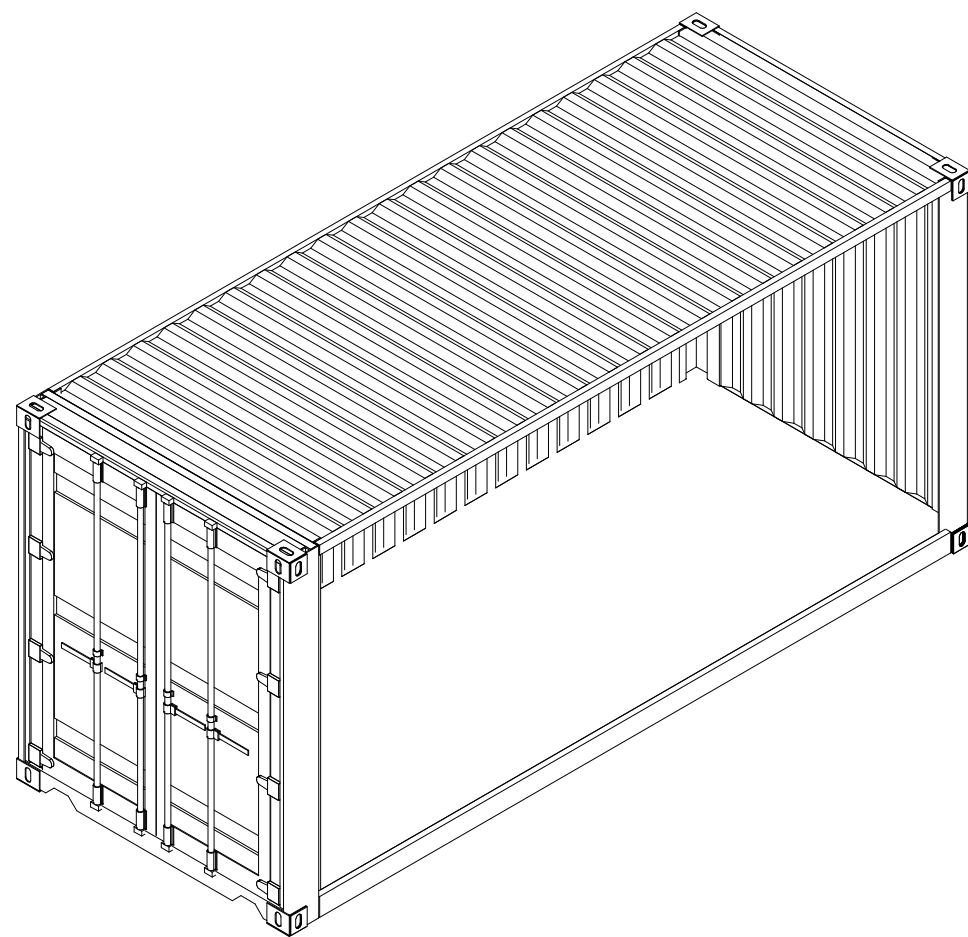


9 3D CONTAINER 3 (2)

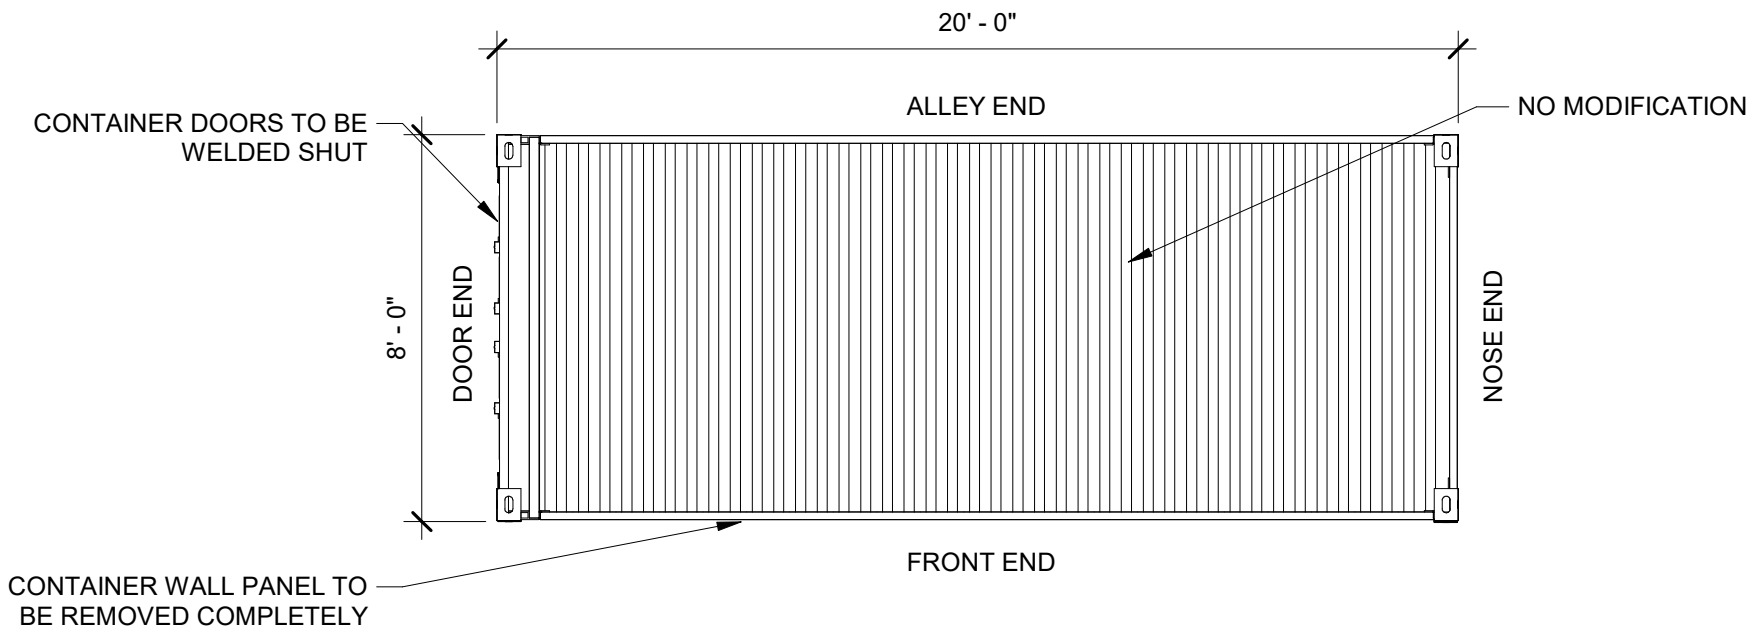


5 APARTMENT CONTAINER 3 ROOF  
1/4" = 1'-0"

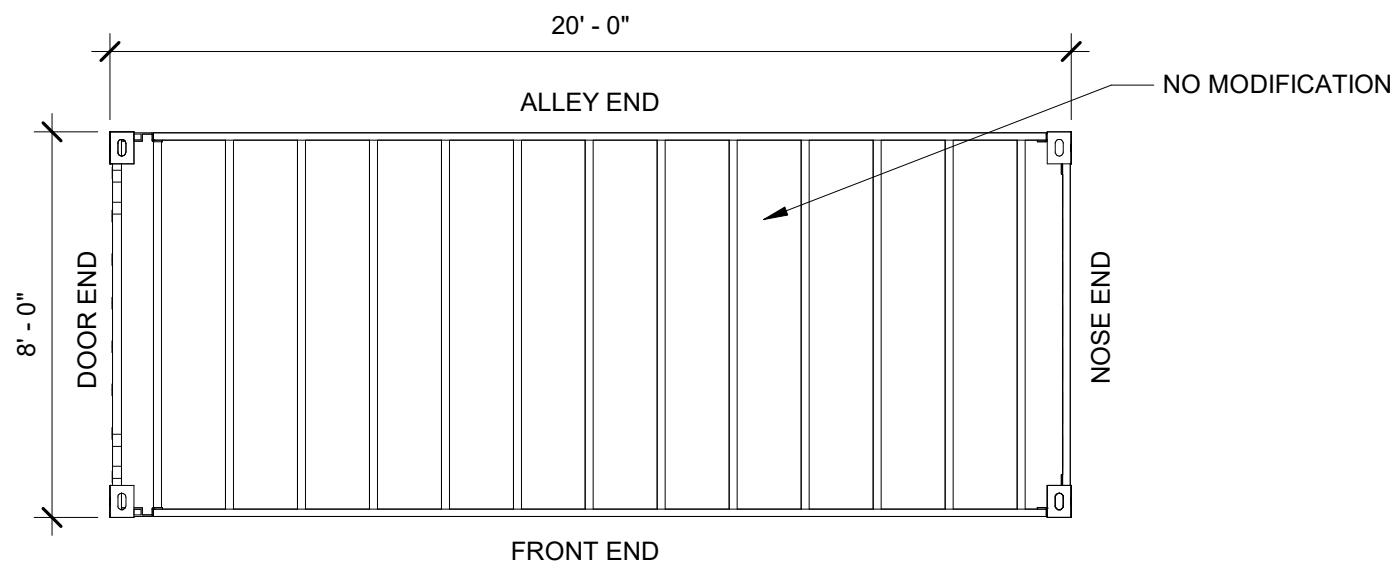


6 APARTMENT CONTAINER 3 BOTTOM  
1/4" = 1'-0"

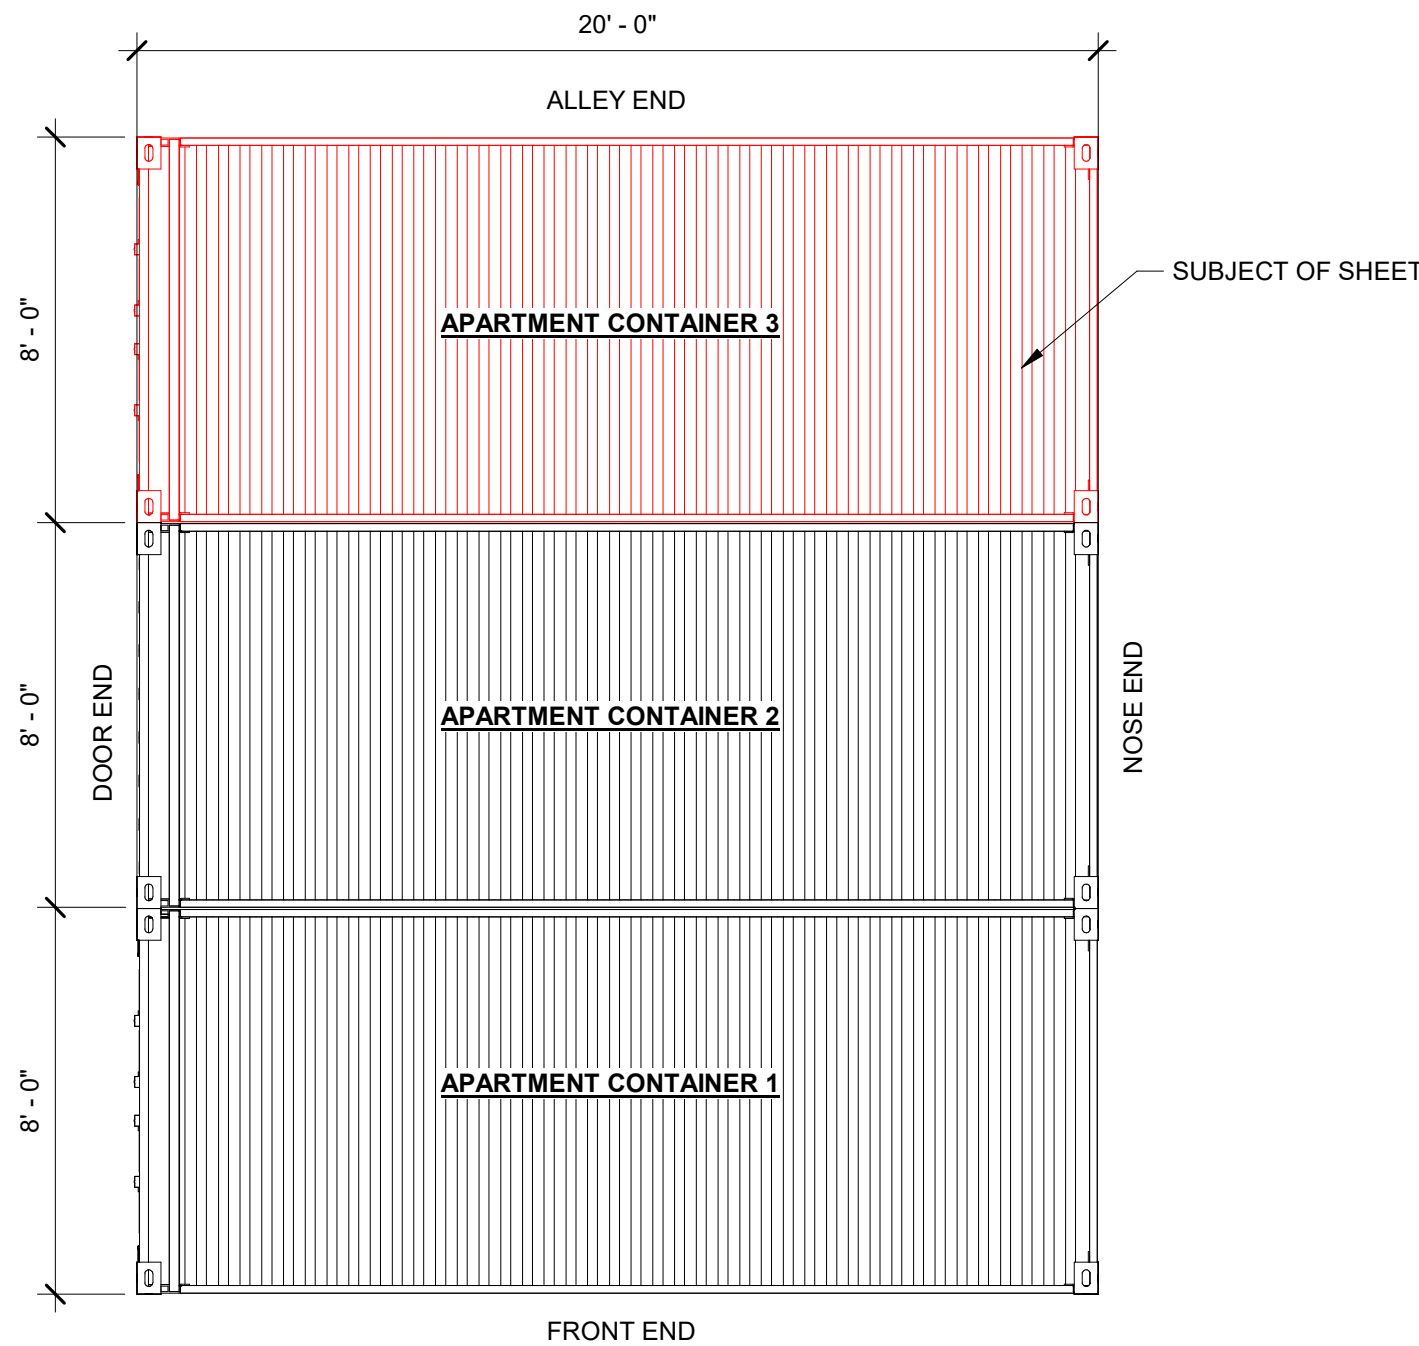


7 APARTMENT CONTAINER 3 KEY PLAN  
1/4" = 1'-0"

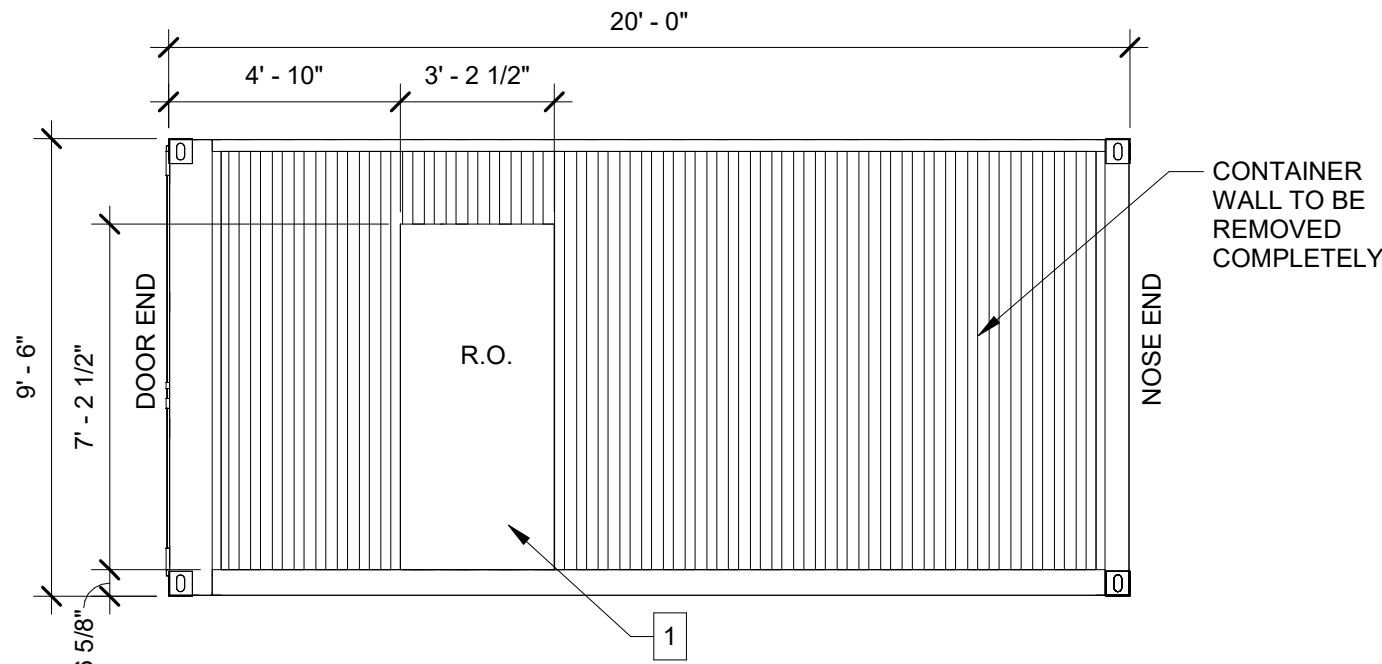


1 APARTMENT CONTAINER 3 FRONT END  
1/4" = 1'-0"

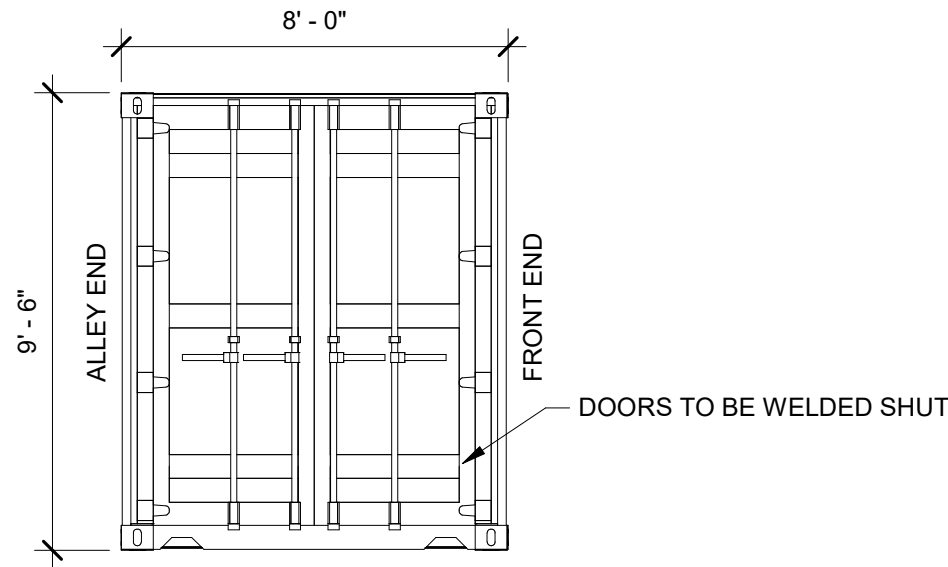

2 APARTMENT CONTAINER 3 DOOR END  
1/4" = 1'-0"

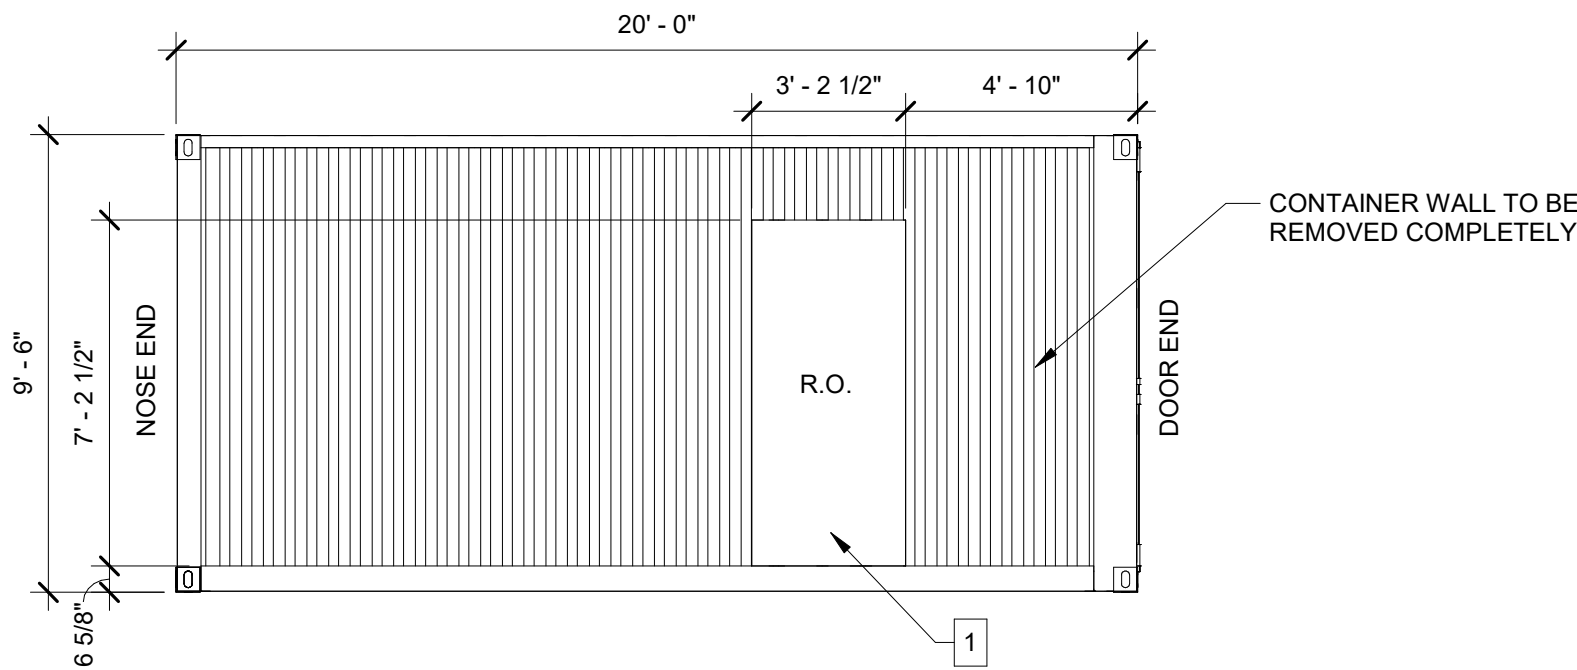

3 APARTMENT CONTAINER 3 ALLEY END  
1/4" = 1'-0"

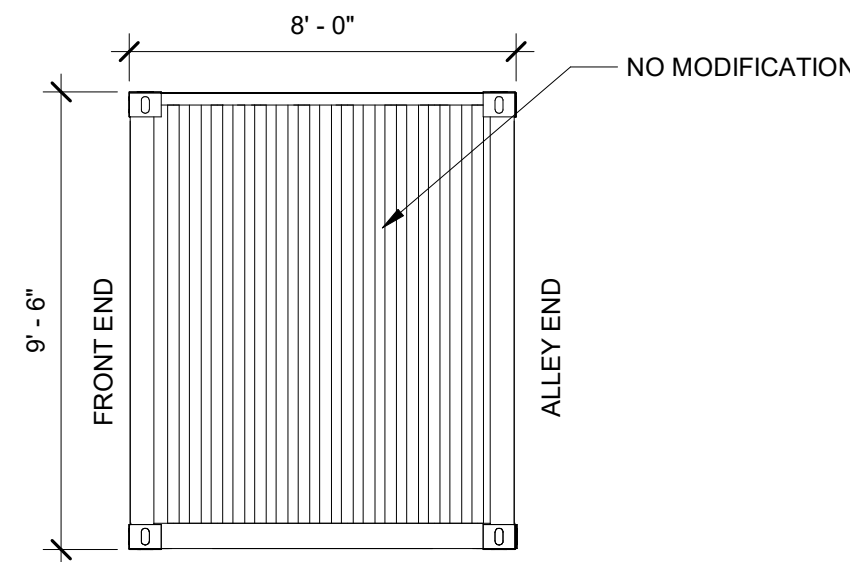

4 APARTMENT CONTAINER 3 BACK END  
1/4" = 1'-0"

GENERAL  
CONTAINER NOTES:

- A. CUT OPENINGS AT FACTORY PRIOR TO LOOSE SHIPMENT.
- B. DRAWINGS HAVE ADDED 2-1/2" OVERALL VERTICALLY AND 2-1/2" OVERALL HORIZONTALLY TO ALL ROUGH DOOR OPENINGS.
- C. DRAWINGS HAVE ADDED 3/4" OVERALL VERTICALLY AND 3/4" OVERALL HORIZONTALLY TO ALL ROUGH WINDOW AND STOREFRONT OPENINGS.

CONTAINER SHEET  
NOTES: #

- 1. DOOR OPENING.
- 2. WINDOW OPENING.
- 3. STOREFRONT OPENING.
- 4. STRUCTURE, RE: STRUCTURAL DRAWINGS.



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AGENCY SET

PROJECT	DATE
19176	05-07-2020
DRAWN	CHECKED
LMV	JSG / CAS


REVISED

APARTMENT  
CONTAINER 3  
CUTOUTS


SHEET

A55  
ORIGINAL SHEET SIZE  
24" x 36"




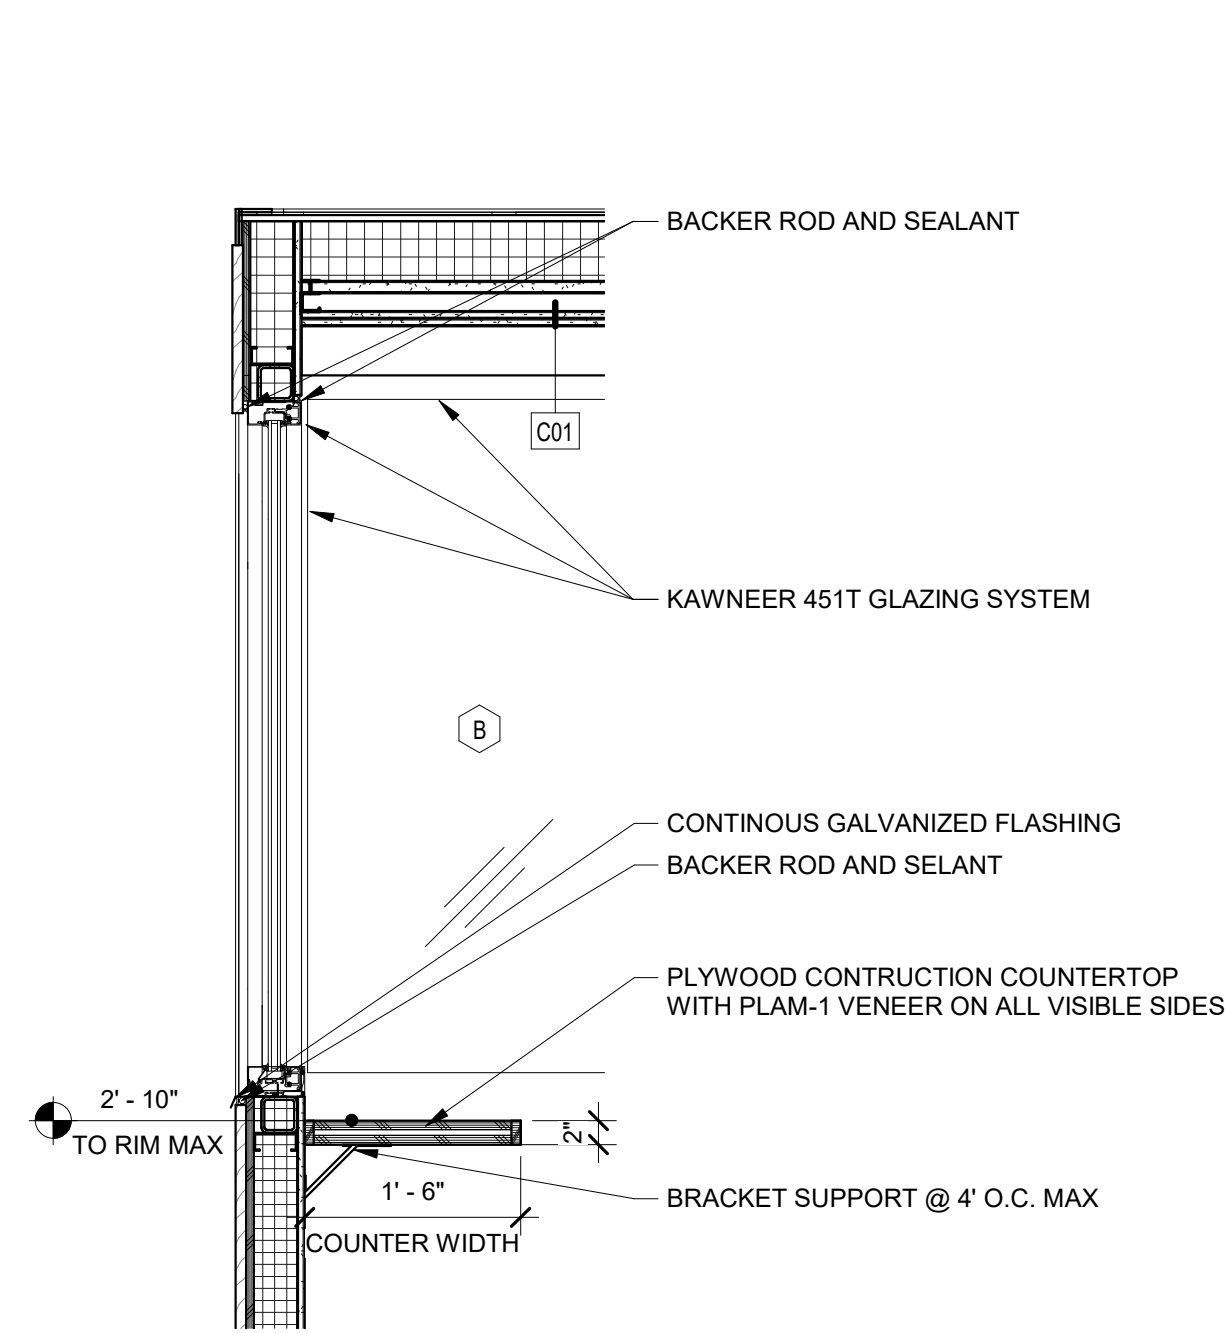


5 FRONT WINDOW SECTION  
3/4" = 1'-0"

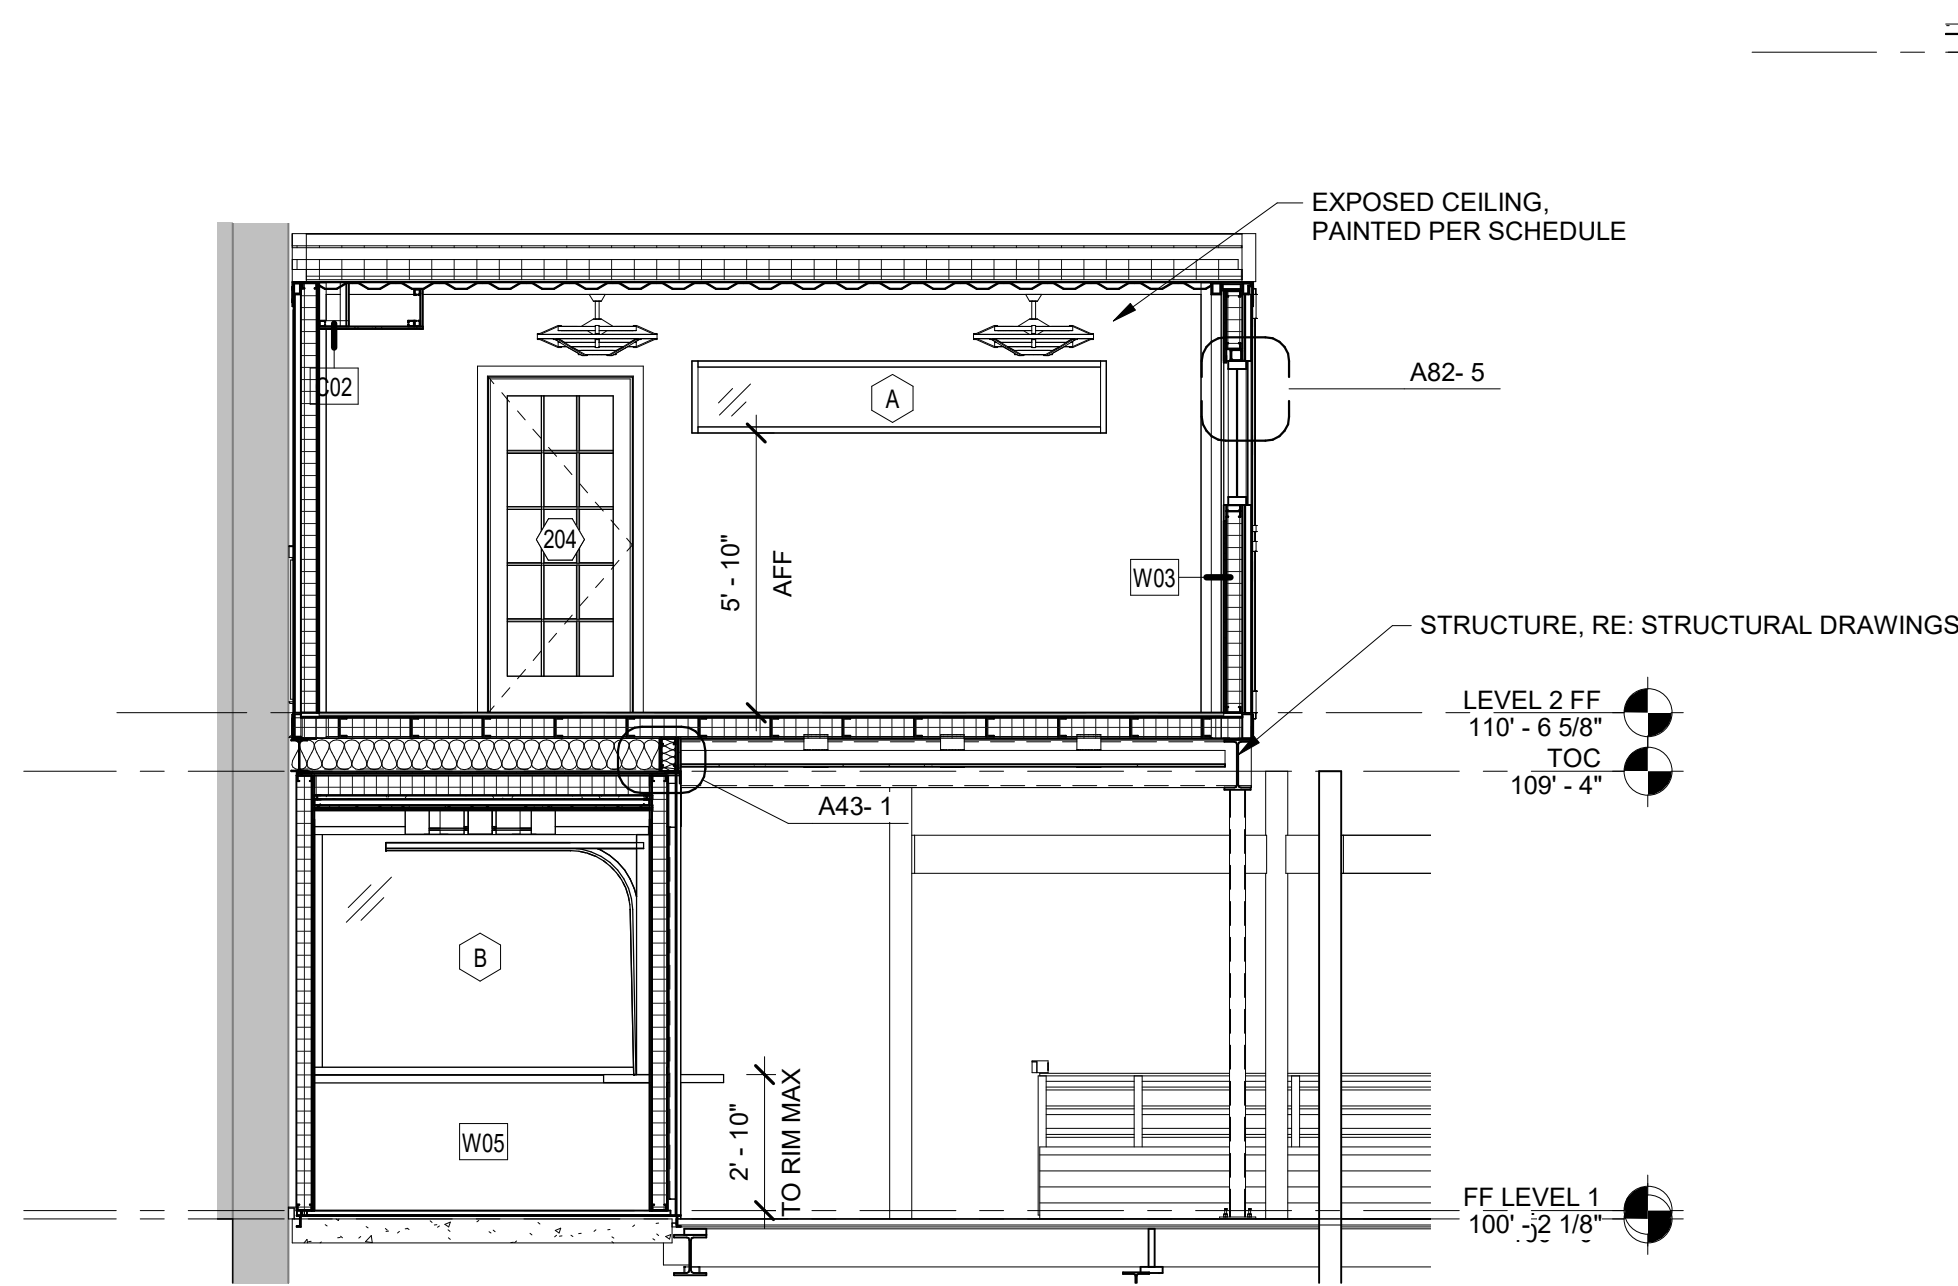


4 FULL BUILDING SHORT SECTION  
1/4" = 1'-0"

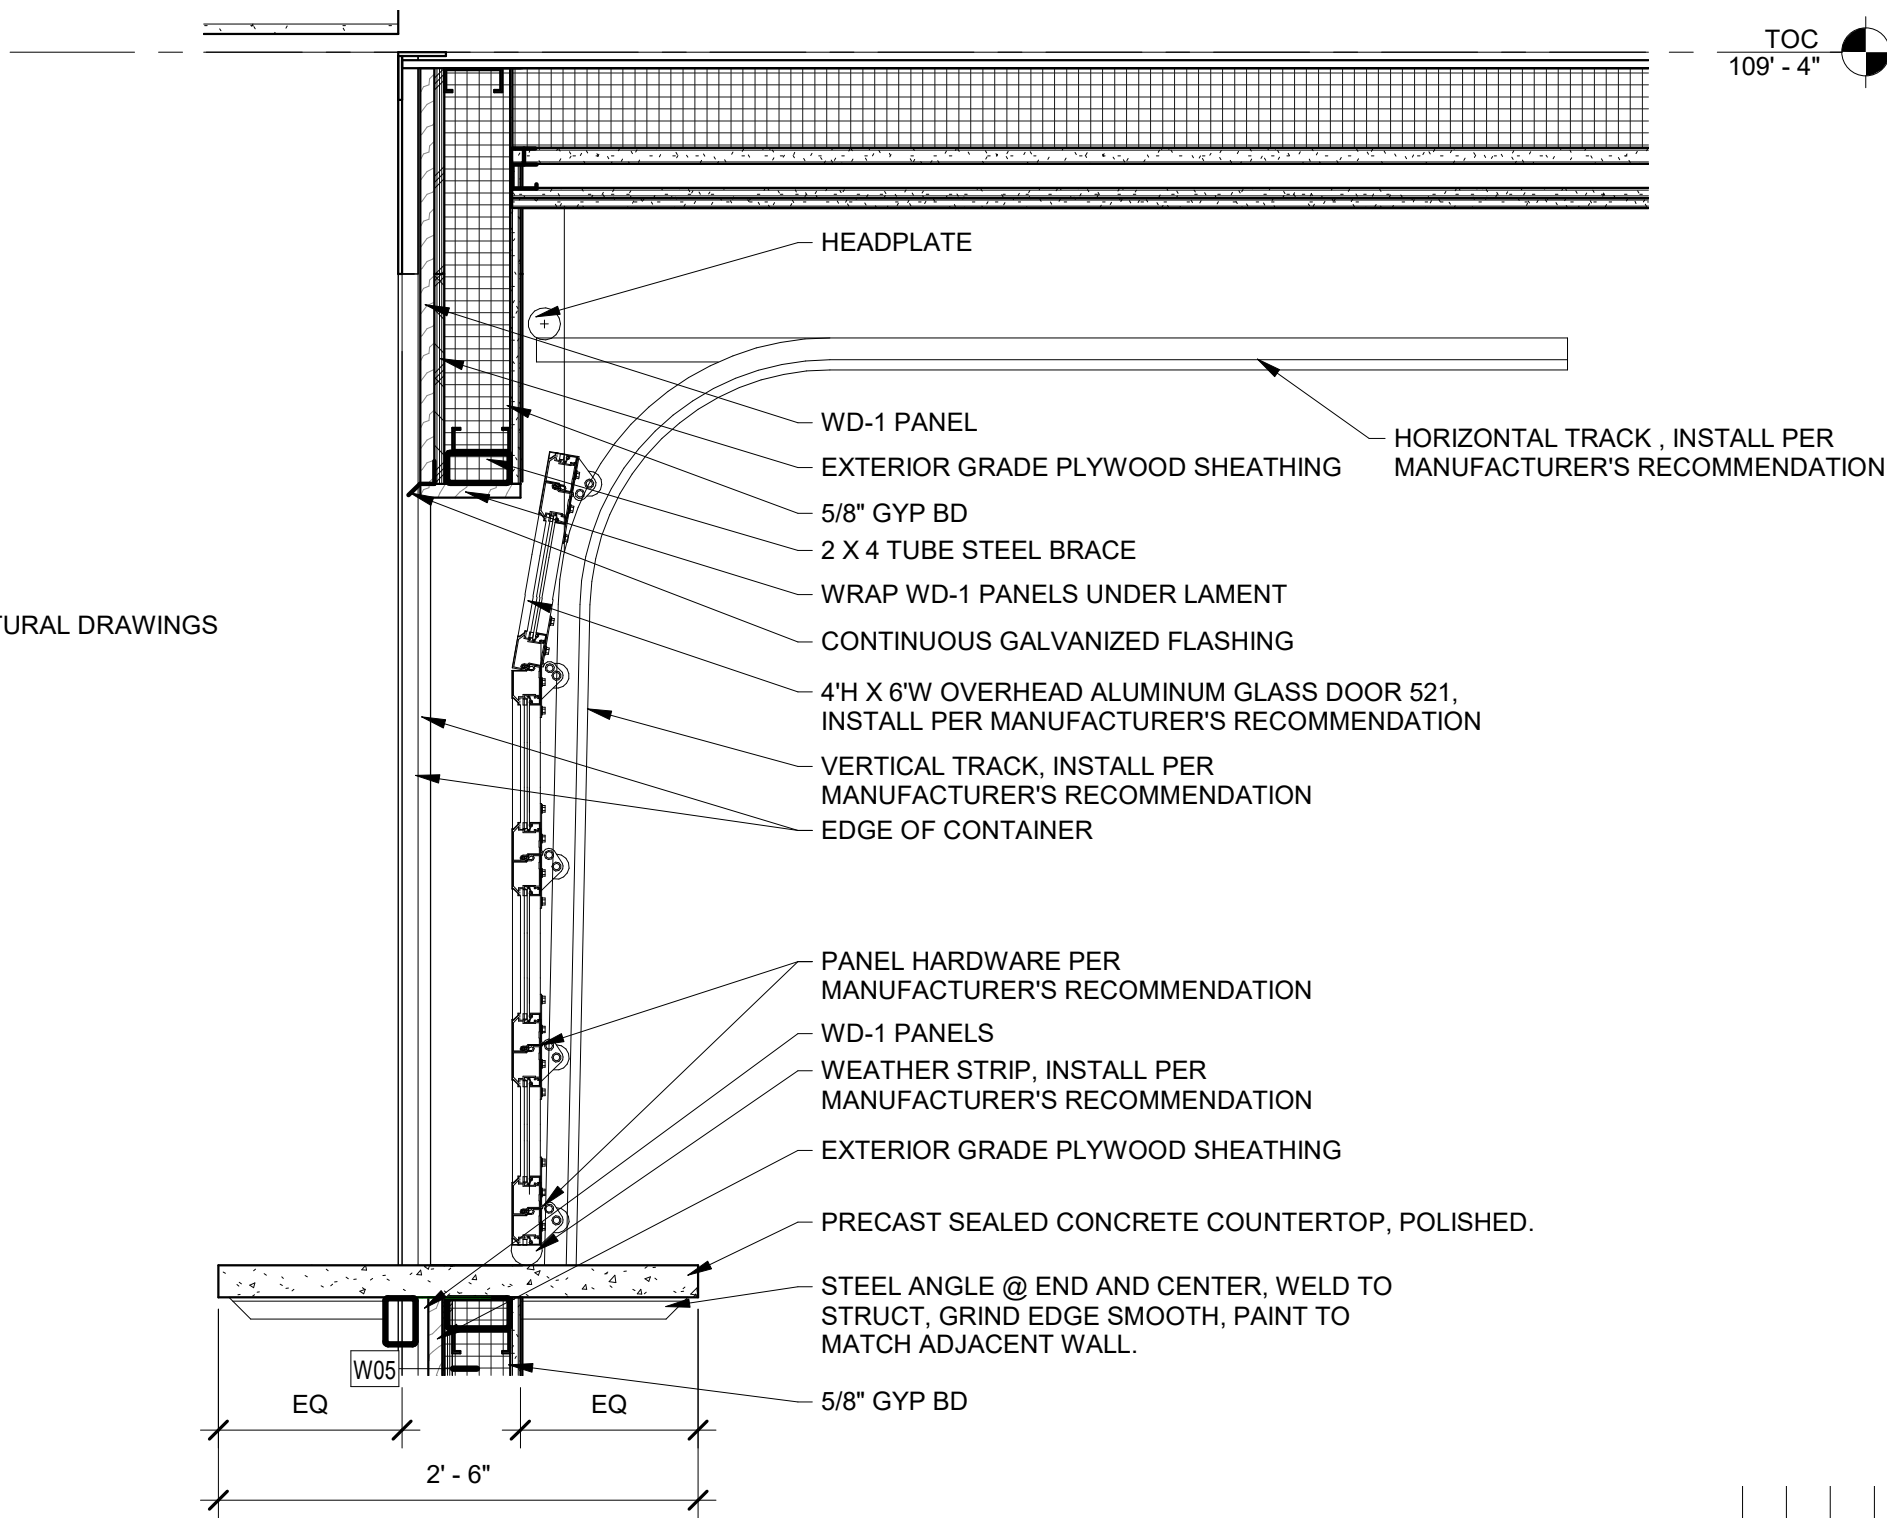

3 OVERHEAD DOOR SECTION  
1" = 1'-0"

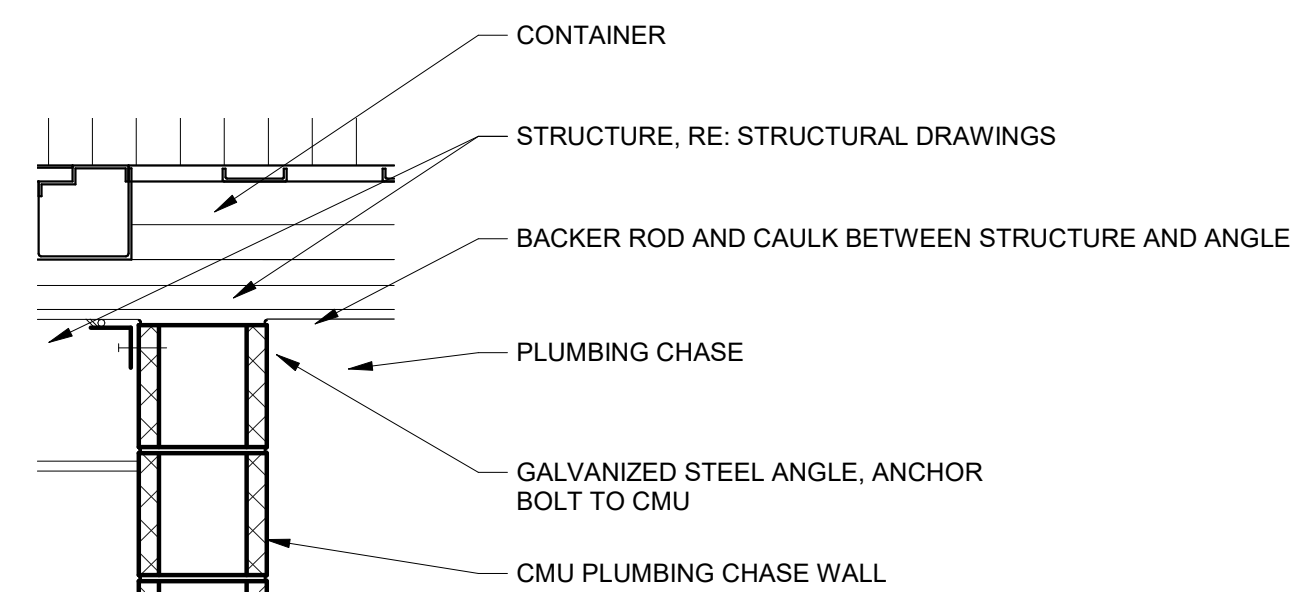


2 TOP OF PLUMBING CHASE WALL  
1" = 1'-0"

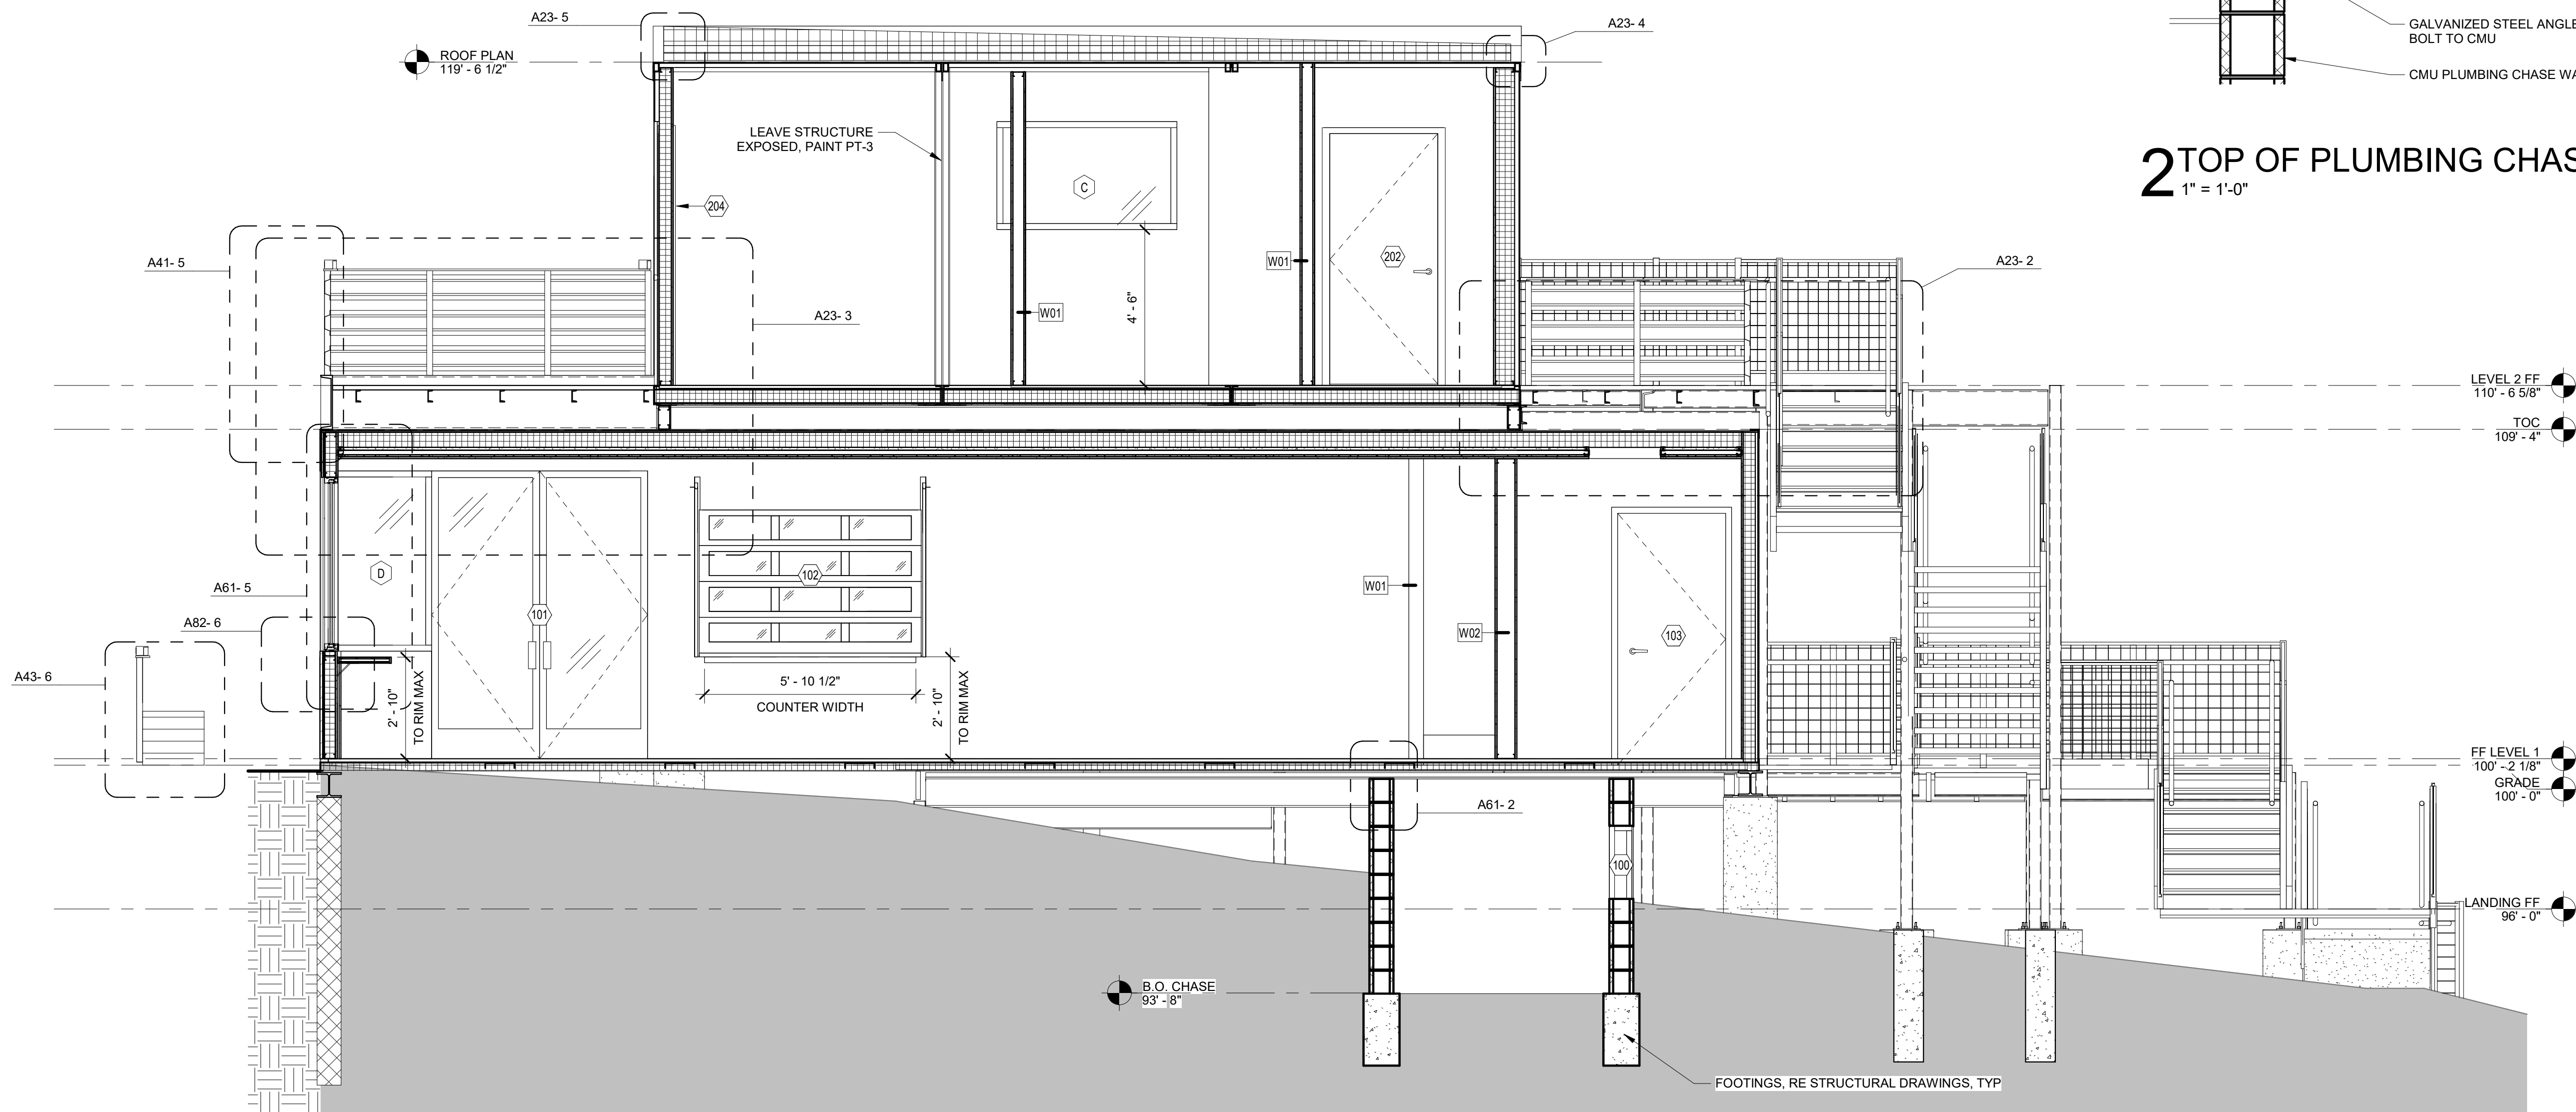

1 FULL BUILDING LONG SECTION  
3/8" = 1'-0"

## GENERAL NOTES:

- MAINTAIN THE INTEGRITY OF ALL REMAINING BUILDING SYSTEMS AND RATINGS. REPAIR ANY DAMAGE DONE TO SURROUNDING AREAS/CONSTRUCTION DURING DEMOLITION.
- ALL EXISTING CONDITIONS ARE NOT INDICATED ON THE DRAWINGS. CONTRACTOR SHALL CAREFULLY EXAMINE THE EXISTING INSTALLATION AND ALL PROJECT DRAWINGS TO BECOME FAMILIAR WITH THE SCOPE OF WORK.
- CLEAN CONSTRUCTION DEBRIS AND DUST DAILY BEYOND CONSTRUCTION LIMITS.
- VERIFY ALL DIMENSIONS IN FIELD.
- REFER TO ELECTRICAL AND MECHANICAL DRAWINGS FOR SCOPE OF ELECTRICAL AND MECHANICAL WORK.
- CONTRACTOR SHALL PATCH AND REPAIR ANY DAMAGE OR PENETRATIONS AT ALL ELEMENTS TO REMAIN (INCLUDING BUT NOT LIMITED TO WALLS, CEILINGS FLOORS, ETC.) CAUSED BY DEMOLITION ACTIVITIES OR REMOVAL OF ELECTRICAL, MECHANICAL, AND ARCHITECTURAL ELEMENTS. REPLACE ITEMS NOT REPAIRABLE TO ORIGINAL STATE. EXISTING FINISH MATERIALS, INCLUDING CEILING, TRIM, ETC. SHALL BE PROTECTED AND RETAINED, UNLESS OTHERWISE NOTED.
- DEMOLITION NOT SHOWN ON SECTIONS REFER TO DEMOLITION PLANS FOR SCOPE OF DEMOLITION WORK.
- FURNITURE AND EQUIPMENT SHOWN FOR REFERENCE ONLY, RE: FURNITURE PLAN.

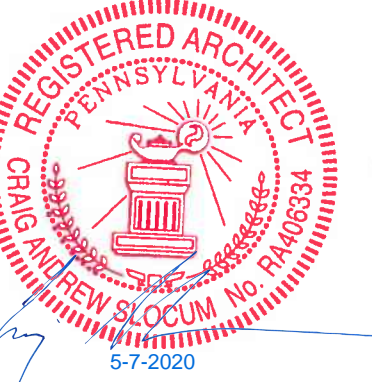

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## AGENCY SET

PROJECT	DATE
19176	05-07-2020
DRAWN	CHECKED
LMV	JSG / CAS

REVISED

SHEET TITLE


**BUILDING  
SECTIONS**

SHEET

**A61**

ORIGINAL SHEET SIZE  
24" x 36"



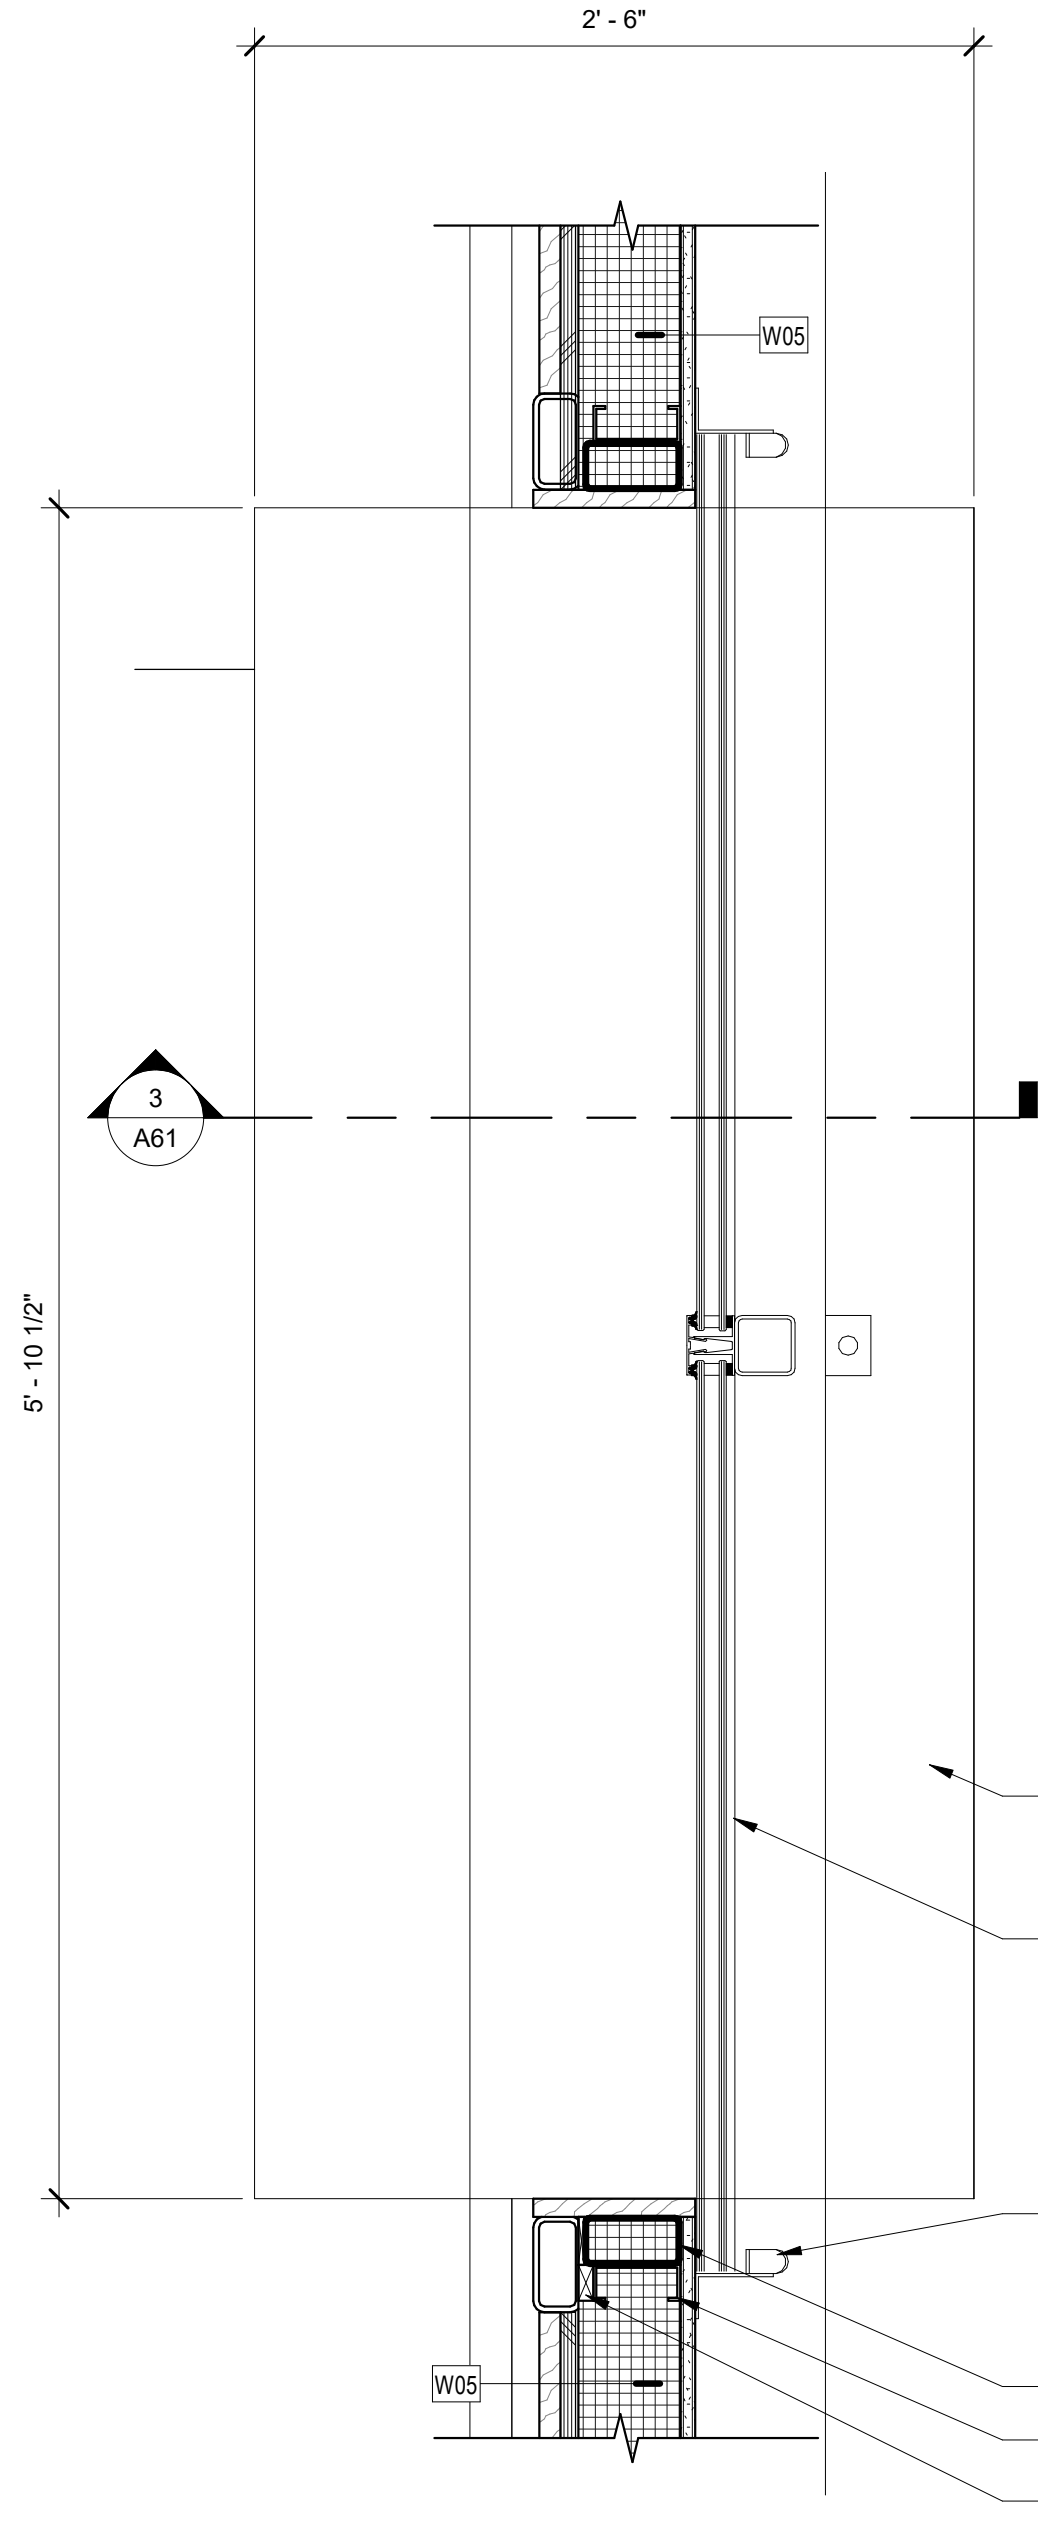

4 OVERHEAD DOOR PLAN  
1 1/2" = 1'-0"

## HG Door Hardware Group

### Hardware Group 01 - Apartment Entry

- 3 ea. Hinge, Iron Black
- 1 ea. Kwikset Signature Halifax x Square Rose Iron Black Single Cylinder Deadbolt Entry Door Interior Handle Halifax #966HFL SQT 514
- 1 ea. Kwikset Signature San Clemente Iron Black Smartkey Single Cylinder Deadbolt Entry Door Exterior Handle #816SC 514 SMT
- 3 ea. Door Silencer
- 1 ea. Continuous Weather Stripping
- 1 ea. Peep Hole, Iron Black
- 1 ea. Wall Door Stop, Iron Black

### Hardware Group 02 - Apartment Restroom

- 3 ea. Hinge
- 1 ea. Kwikset Primo Iron Black Privacy Door Knob Single Pack #730PSK RDT 514
- 3 ea. Door Silencer
- 1 ea. Wall Door Stop, Iron Black

### Hardware Group 03 - Coffee Shop Entry

- 2 ea. Kawneer Top Offset Pivot
- 2 ea. Kawneer Bottom Offset Pivot
- 2 ea. Kawneer Adams Rite MS 2180 Two-Point Flushbolt
- 2 ea. Adams Right 4510 Dead Latch
- 1 ea. Kawneer Double Keyed Cylinder
- 1 ea. Weather Stripping
- 3 ea. Door Silencer
- 2 ea. Overhead Closer with Stop, Aluminum
- 1 ea. Kawneer Pulls
- 1 ea. Sign to say "Door to Remain Unlocked During Business Hours"
- 2 ea. Push Plate to match hardware with engraved "PUSH"
- 1 ea. Double Key Cylinder Lock
- 1 ea. Flush Bolt

### Hardware Group 04 - Coffee Shop Restroom

- 3 ea. Hinge
- 1 ea. Schlage FE595 Plymouth Satin Chrome 1-Cylinder Lighted Keypad #FE595CS PLY
- 1 ea. Hinge Pin Stop
- 1 ea. Continuous Weather Strip

### Hardware Group 05 - Security Gate

- 3 ea. Hinge
- 1 ea. Entry Function Lockset with Cypher

### Hardware Group 06 - Access Door

- 1 ea. Medium Duty Padlock Hasp
- 1 ea. Medium Duty Padlock


### Hardware Group 07 - Apartment Closet Door

- 2 ea. Sliding Door Finger Pull
- 2 ea. Sliding Door Track


## 8 DOOR SCHEDULE

RE: A21-1

NUMBER	TYPE	FRAME TYPE	DOOR			DOOR FINISH	COMMENTS	HARDWARE SET
			WIDTH	HEIGHT	THICKNESS			
100	08	02	2' - 4"	2' - 0"	1 3/4"	-		06
101	01	01	6' - 0"	8' - 0"	1"	PT-9		03
102	05	PER MANUFACTURER	0"	0"	0"	PT-9		PER MANUFACTURER
103	04	02	3' - 0"	7' - 0"	1 3/4"	PT-9		04
201	02	02	3' - 0"	7' - 0"	1 3/8"	PT-9		01
202	03	02	3' - 0"	7' - 0"	1 3/4"	PT-9		02
203	07	02	4' - 0"	6' - 8"	1 3/8"	PT-9		07
204	02	02	3' - 0"	7' - 0"	1 3/8"	PT-9		01

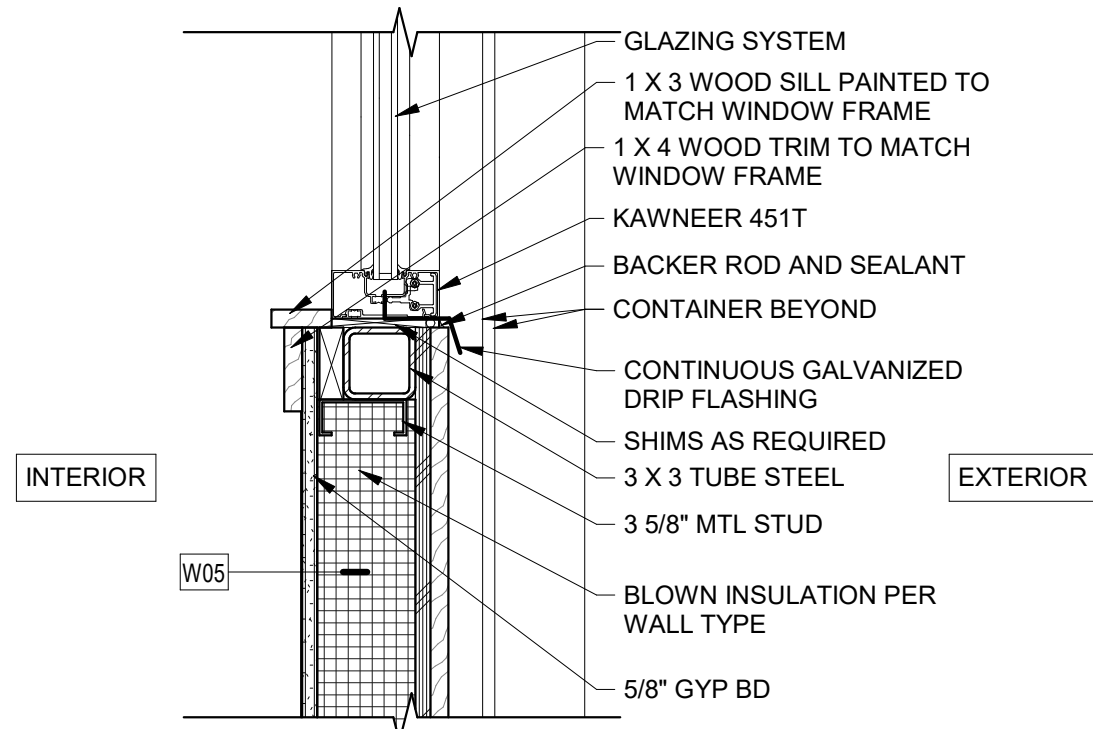


6 TYP. WINDOW SILL DETAIL  
1 1/2" = 1'-0"

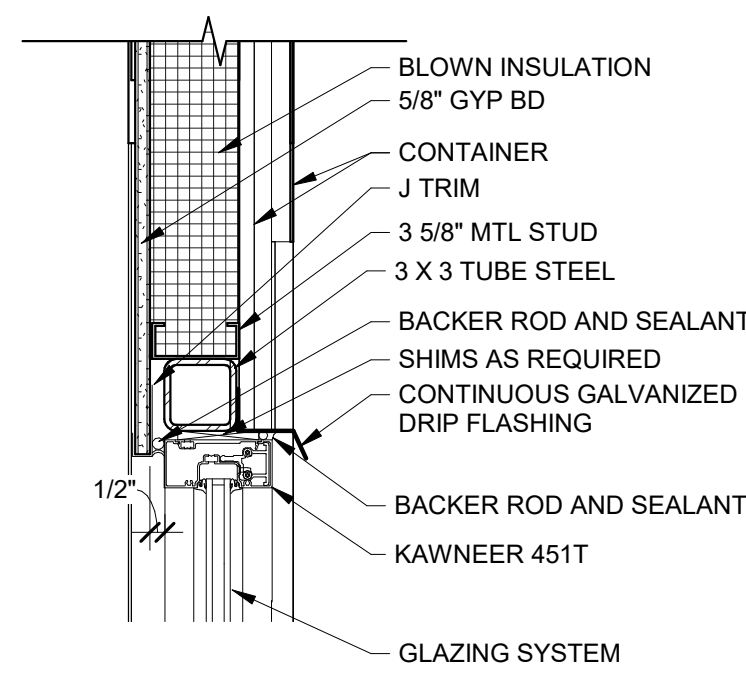

5 TYP. WINDOW HEAD DETAIL  
1 1/2" = 1'-0"

## 3 WINDOW TYPES

1/4" = 1'-0"

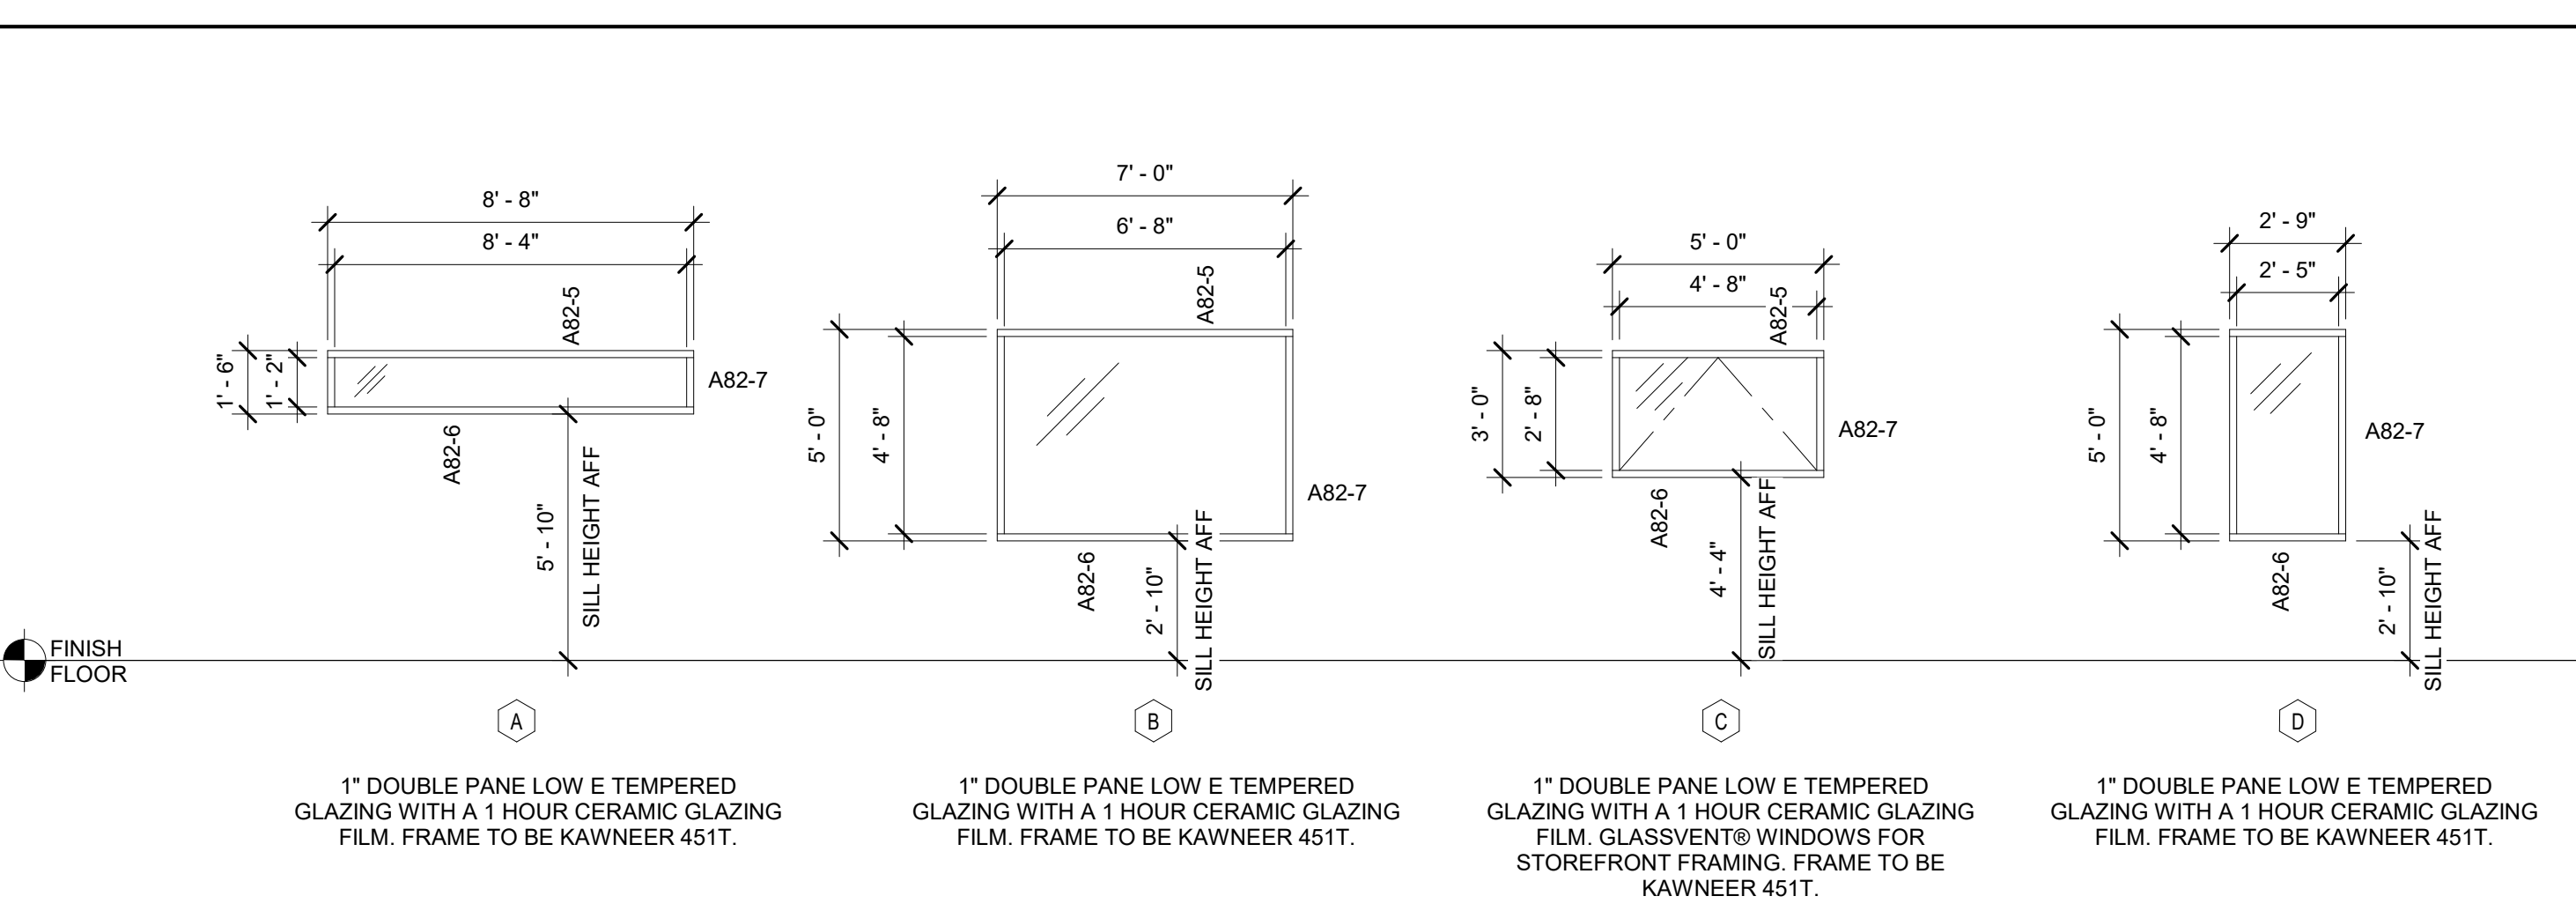

## DOOR GENERAL NOTES:

- VERIFY ROUGH OPENING IN FIELD.
- INSTALL DOORS AND FRAMES PER MANUFACTURER'S REQUIREMENTS.
- ALL EXITS SHALL BE OPENABLE FROM THE INSIDE WITHOUT THE USE OF A KEY OR ANY SPECIAL KNOWLEDGE OR EFFORT.
- FOR HARDWARE SETS, RE: SPECIFICATIONS, DIVISION 087100 DOOR HARDWARE.

## WINDOW GENERAL NOTES:

- ALL MATERIALS TO BE INSTALLED PER MANUFACTURER'S SPECIFICATIONS AND RECOMMENDATIONS.
- ROUGH OPENINGS INCLUDE SHIM SPACE WITH SEALANT JOINT ON ALL SIDES.
- DIMENSIONS REFLECT DESIGN INTENT. GENERAL CONTRACTOR IS RESPONSIBLE FOR FIELD MEASUREMENT OF ALL ROUGH OPENINGS PRIOR TO INSTALLATION OF WINDOWS.
- RE: FLOOR PLAN AND EXTERIOR ELEVATIONS FOR WINDOW LOCATIONS.

## MATERIAL LEGEND:

MATERIAL	GLASS
GL	GLASS
MFR.	MANUFACTURER
WD	WOOD
ALUM	ALUMINUM
GALV	GALVANIZED METAL
SS	STAINLESS STEEL
STL	STEEL

## GLAZING LEGEND:

### GLASS DESIGNATION

ALL GLASS TO BE 1" INSULATED GLASS, LOW-E, TEMPERED SAFETY GLASS WITH 1 HOUR CERAMIC FILM TO COMPLY WITH FIRE SEPERATION REQUIREMENTS.

### U VAULE REQUIREMENTS:

FIXED FENESTRATION : 0.38

OPERABLE FENESTRATION: 0.45

ENTRANCE DOORS: 0.77


SHGC REQUIREMENTS: (PF < 2)

SEW: 0.40

NORTH: 0.53



## 2 FRAME TYPES

1/4" = 1'-0"

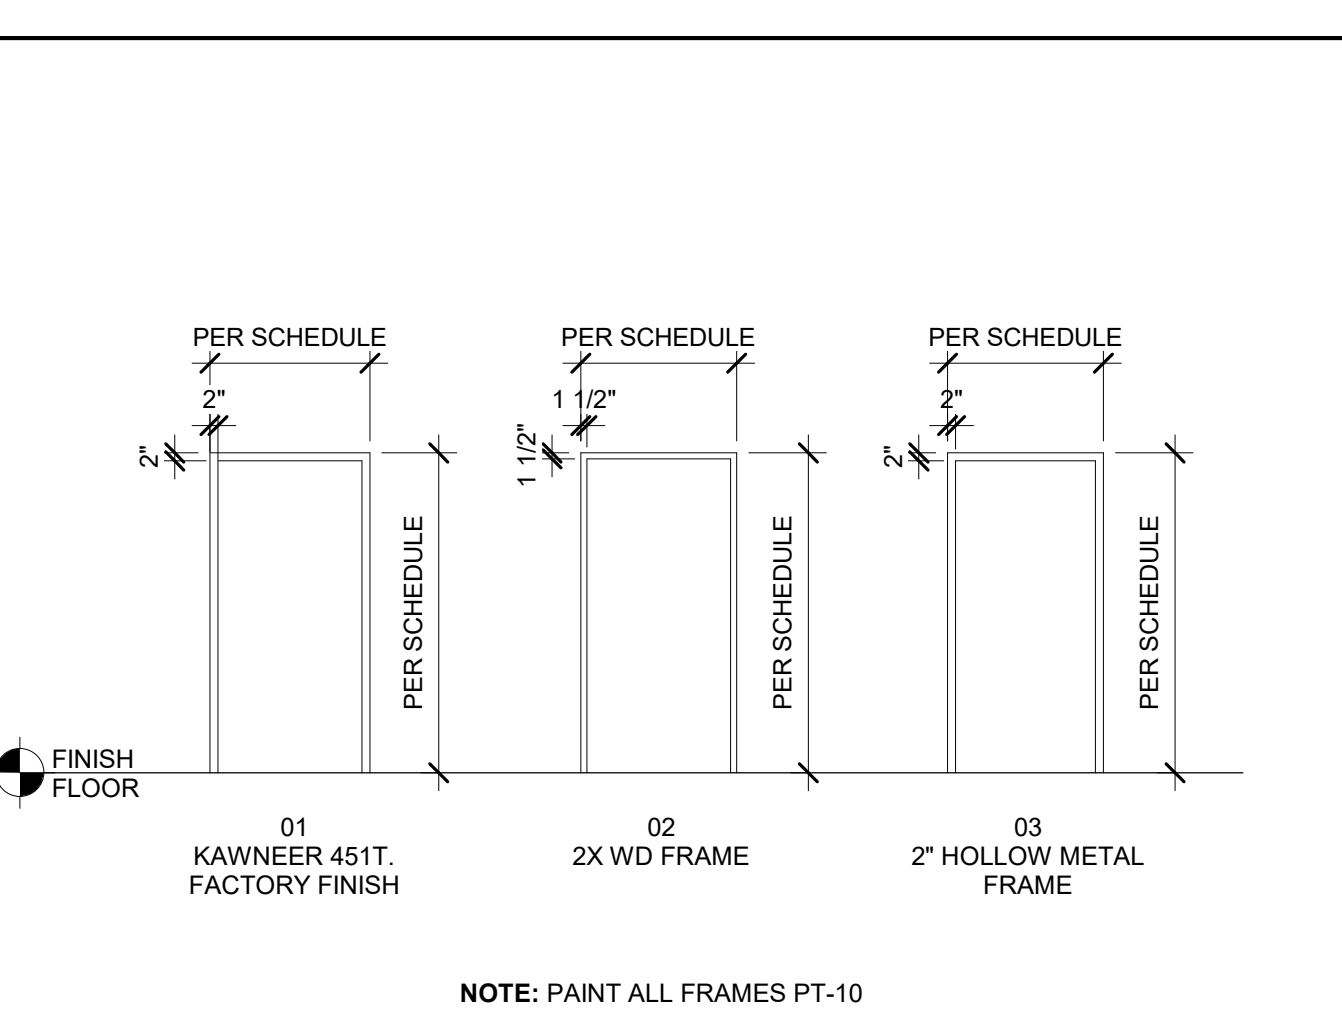


## 1 DOOR TYPES

1/4" = 1'-0"

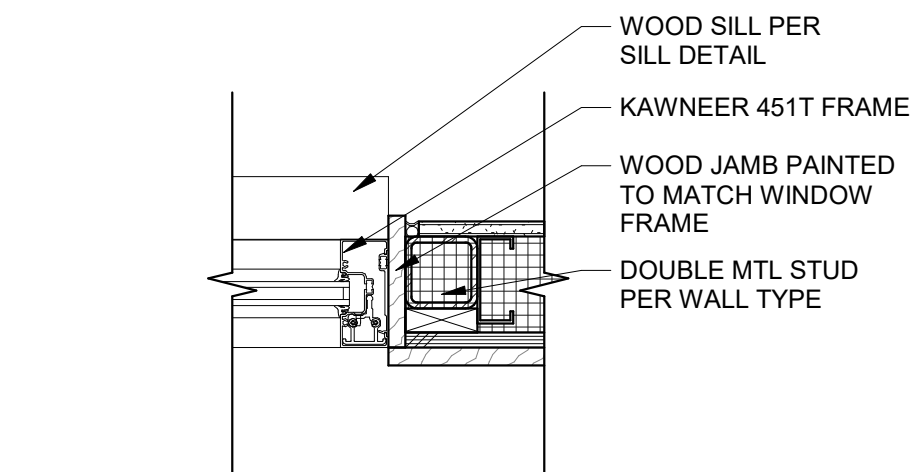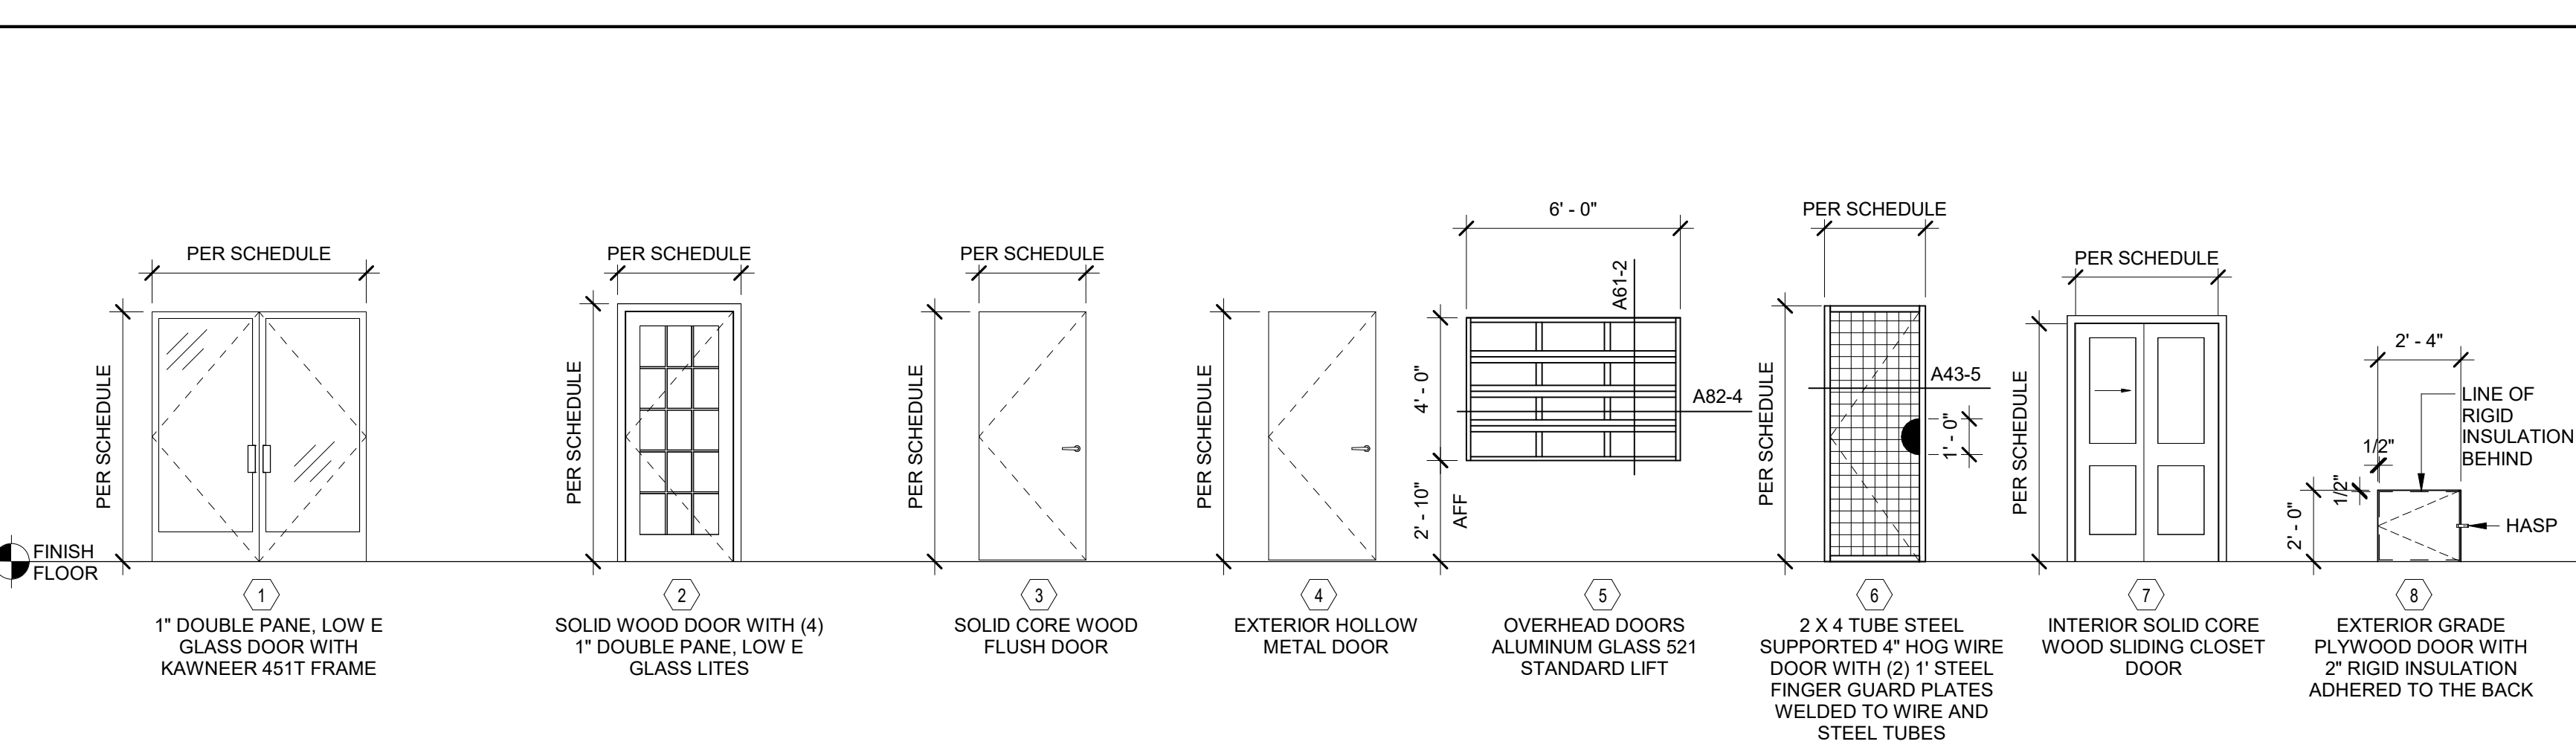

7 TYP. WINDOW JAMB DETAIL  
1 1/2" = 1'-0"

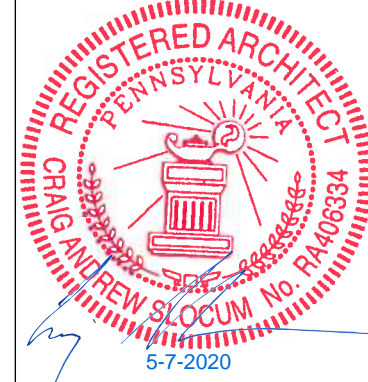

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CONTAINER COFFEE SHOP  
79 SOUTH MAIN STREET  
PITTSBURGH, PA

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CRAIG A. SLOCUM, ARCHITECT

## AGENCY SET

PROJECT 19176	DATE 05-07-2020
DRAWN LMV	CHECKED JSG / CAS

REVISED

## DOOR & WINDOW SCHEDULES

SHEET

A82

ORIGINAL SHEET SIZE  
24" x 36"



Material Legend - Finishes for Pricing Purposes Only. Specific Finishes TBD								
Flooring, Base & Transitions								
Code	Material	Manufacturer	Pattern / Style	Color	Finish	Size	Description	Notes
CPT	Broadloom Carpet	Shaw Floors	Just a Hint E9641	Nickel 00510				
LVT	Luxury Vinyl Tile	Armstrong	Derry Oak LVT	Foggy Gray A6767		7.2" x 48"		Stagger end joints by 6"
WD-1	Yellow Pine	RE: STRUCTURAL						
FF-1	Floor Finish	Minwax	Ultimate Floor Finish		Semi-Gloss		Existing Wood Container Floor	Fill holes and sand to provide smooth surface. Apply 2-3 coats of Floor Finish
FT-1	Glazed Ceramic Tile	Lowes	Chilo	Gray		12" x 12"		
Walls & Doors								
Code	Material	Manufacturer	Pattern / Style	Color	Finish	Size	Description	Notes
PT-1	Apartment Interior Accent Paint	Sherwin Williams	Acier	SW 9170	Eggshell			
PT-2	Apartment Interior Main Paint	Sherwin Williams	Mindful Gray	SW 7016	Eggshell			
PT-3	Apartment Interior Ceiling Paint	Sherwin Williams	Snowbound	SW 7004	Eggshell			
PT-4	Apartment Exterior Grade Paint	Sherwin Williams			Satin			
PT-5	Coffee Shop Interior Accent Paint	Sherwin Williams	TBD by Vendor	TBD by Vendor	Semi-Gloss			
PT-6	Coffee Shop Interior Main Paint	Sherwin Williams	TBD by Vendor	TBD by Vendor	Semi-Gloss			
PT-7	Coffee Shop Interior Ceiling Paint	Sherwin Williams	White to go with vendor colors		Semi-Gloss			
PT-8	Coffee Shop Exterior Grade...	Sherwin Williams	High Reflective White	SW 7757	Glossy			
PT-9	Coffee Shop Exterior Grade Paint	Sherwin Williams			Satin			
PT-10	Exterior Grade Frame Paint	Sherwin Williams			Statin			
B-1	Wood Base	Roppe	Poplar, Straight	White		1 x 4		
B-2	Rubber Base	Roppe	TBD by Vendor	TBD by Vendor		4" Coved		
T-1	Glazed Ceramic Tile	Modern Dimensions	Arctic White	0190		2 1/8" X 8 1/2"	Or approved equal.	Bullnose trim @ top row, cove base @ bottom row
T-2	Glazed Ceramic Tile	Modern Dimensions	Arctic White	0190		4 1/4" x 12 3/4"	Or approved equal.	Bullnose trim @ top row, cove base @ bottom row
Counters & Partition Materials								
Code	Material	Manufacturer	Color / Pattern	Finish	Thickness	Location		Notes
CONC	Sealed Precast Concrete			SEMI-GLOSS	2"	Coffee Shop Customer Counters		Counters @ Sectional Door & Front Window
PLAM 1	Plastic Laminat	TBD AFTER VENDOR SELECTION				Coffee Shop	Checkout Counter	
SS-1	Solid Surface					Apartment	Kitchen Counter	

Room Finish Schedule									
Room Number	Room Name	Floor Finish	Base	N/E Wall	S Wall	E Wall	W Wall	Counter	Comments
101	COFFEE SHOP	FF-1	B-2	PT-6	PT-6	PT-6	PT-6	PLAM-2	SEE PLAN FOR ACCENT WALLS
102	TOILET	FT-1	T-2	T-2 / PT-6	T-2 / PT-6	T-2 / PT-6	T-2 / PT-6		4' TILE WAINSCOT
201	DINING	LVT	B-1	PT-2	PT-2	PT-2	PT-2		
202	BATHROOM	LVT	T-1	T-1 / PT-2	T-1 / PT-2	T-1 / PT-2	T-1 / PT-2	SS-1	4' TILE WAINSCOT
203	KITCHEN	LVT	B-1	PT-2	PT-2	PT-2	PT-2	PLAM-1	
204	BEDROOM	CPT	B-1	PT-2	PT-2	PT-2	PT-2		
205	LIVING	CPT	B-1	PT-2	PT-2	PT-2	PT-2		

LEGEND:

LVT - ARMSTRONG FLOORING  
DERRY OAK LVT - FOGGY GRAY A6767

CPT - SHAW FLOORS BROADLOOM CARPET  
JUST A HINT II (E9641) - NICKEL (00510)

ENTRANCE MAT SYSTEM,  
RE: FLOORING AND WALL BASE SCHEDULE I81

NATURAL CONCRETE FLOORING,  
RE: FLOORING AND WALL BASE SCHEDULE I81

F

FLOORING DESIGNATION,  
RE: FLOORING & WALL BASE SCHEDULE I81

B

WALL BASE DESIGNATION,  
RE: FLOORING & WALL BASE SCHEDULE I81

00 00-01

SHEET NOTE, RE: SHEET NOTES LIST ON CURRENT PAGE

XX

WALL FINISH/BASE DESIGNATION, RE: FINISH SCHEDULE I81

WOOD GRAIN DESIGNATION, RE: FINISH SCHEDULE I81

GENERAL NOTES:

A. DIMENSION IS NOT SHOWN ON INTERIOR SHEETS UNLESS INTERIOR SPECIFIC. REFER ARCHITECTURAL DRAWINGS FOR DIMENSIONS.

B. FIELD VERIFY ALL DIMENSIONS PRIOR TO FABRICATION / ORDERING.

C. ALL TRANSITION IN FLOORING ARE TO OCCUR DIRECTLY BENEATH DOORS U.N.O.

D. ALL GYPSUM BOARD APPLICATIONS SHALL BE SANDED, TAPED AND MUDDED AS NECESSARY.

E. PROVIDE A MAXIMUM OF 1/2" OFFSET AT ALL THRESHOLDS AND AT ANY CHANGES OF FLOORING MATERIAL. ICC/ANSI A117.1 SECTION 303.

F. ALL HOLLOW METAL DOOR FRAMES TO BE PAINTED (PT-10).

G. ALL MATERIALS ARE TO BE INSTALLED PER MANUFACTURERS INSTRUCTIONS USING APPROPRIATE ADHESIVE.

H. SMOOTH FLOOR SUBSTRATE SURFACES. SAND OR GRIND SUBFLOORS TO REMOVE IRREGULARITIES. FILL LOW SPOTS, CONTROL OR CONSTRUCTION JOINTS AND OTHER DEFECTS AS REQUIRED TO PROVIDE UNIFORM SUBSTRATE FOR FLOOR FINISHES.

I. FINISHES NOT REQUIRED ON WALL AREA CONCEALED BY PERMANENT FIXTURES.

J. FINISHES SHALL EXTEND A MINIMUM OF 6" BEHIND FIXTURE.

K. PAINT ALL INTERIOR GYPSUM BOARD CEILINGS AND SOFFITS.

L. NO ITEM TO BE INSTALLED ON FINISH WALL MATERIALS WITHOUT PROJECT MANAGER AND OWNER'S APPROVAL.

M. ALL EXPOSED VENTS, ACCESS PANELS AND SIMILAR ITEMS TO BE PAINTED TO MATCH THE WALL OR CEILING SURFACES THAT THEY ARE ON.


N. REFER TO ENLARGED PLANS, ELEVATIONS, FINISH SCHEDULES FOR ADDITIONAL FINISH INFORMATION.

O. EXTEND RUBBER BASE A MINIMUM OF 6", MAXIMUM OF 12" BEHIND FIXTURES.


P. ALL GYPSUM BOARD TO BE LEVEL 4 FINISH

## ###

SHEET NOTES:

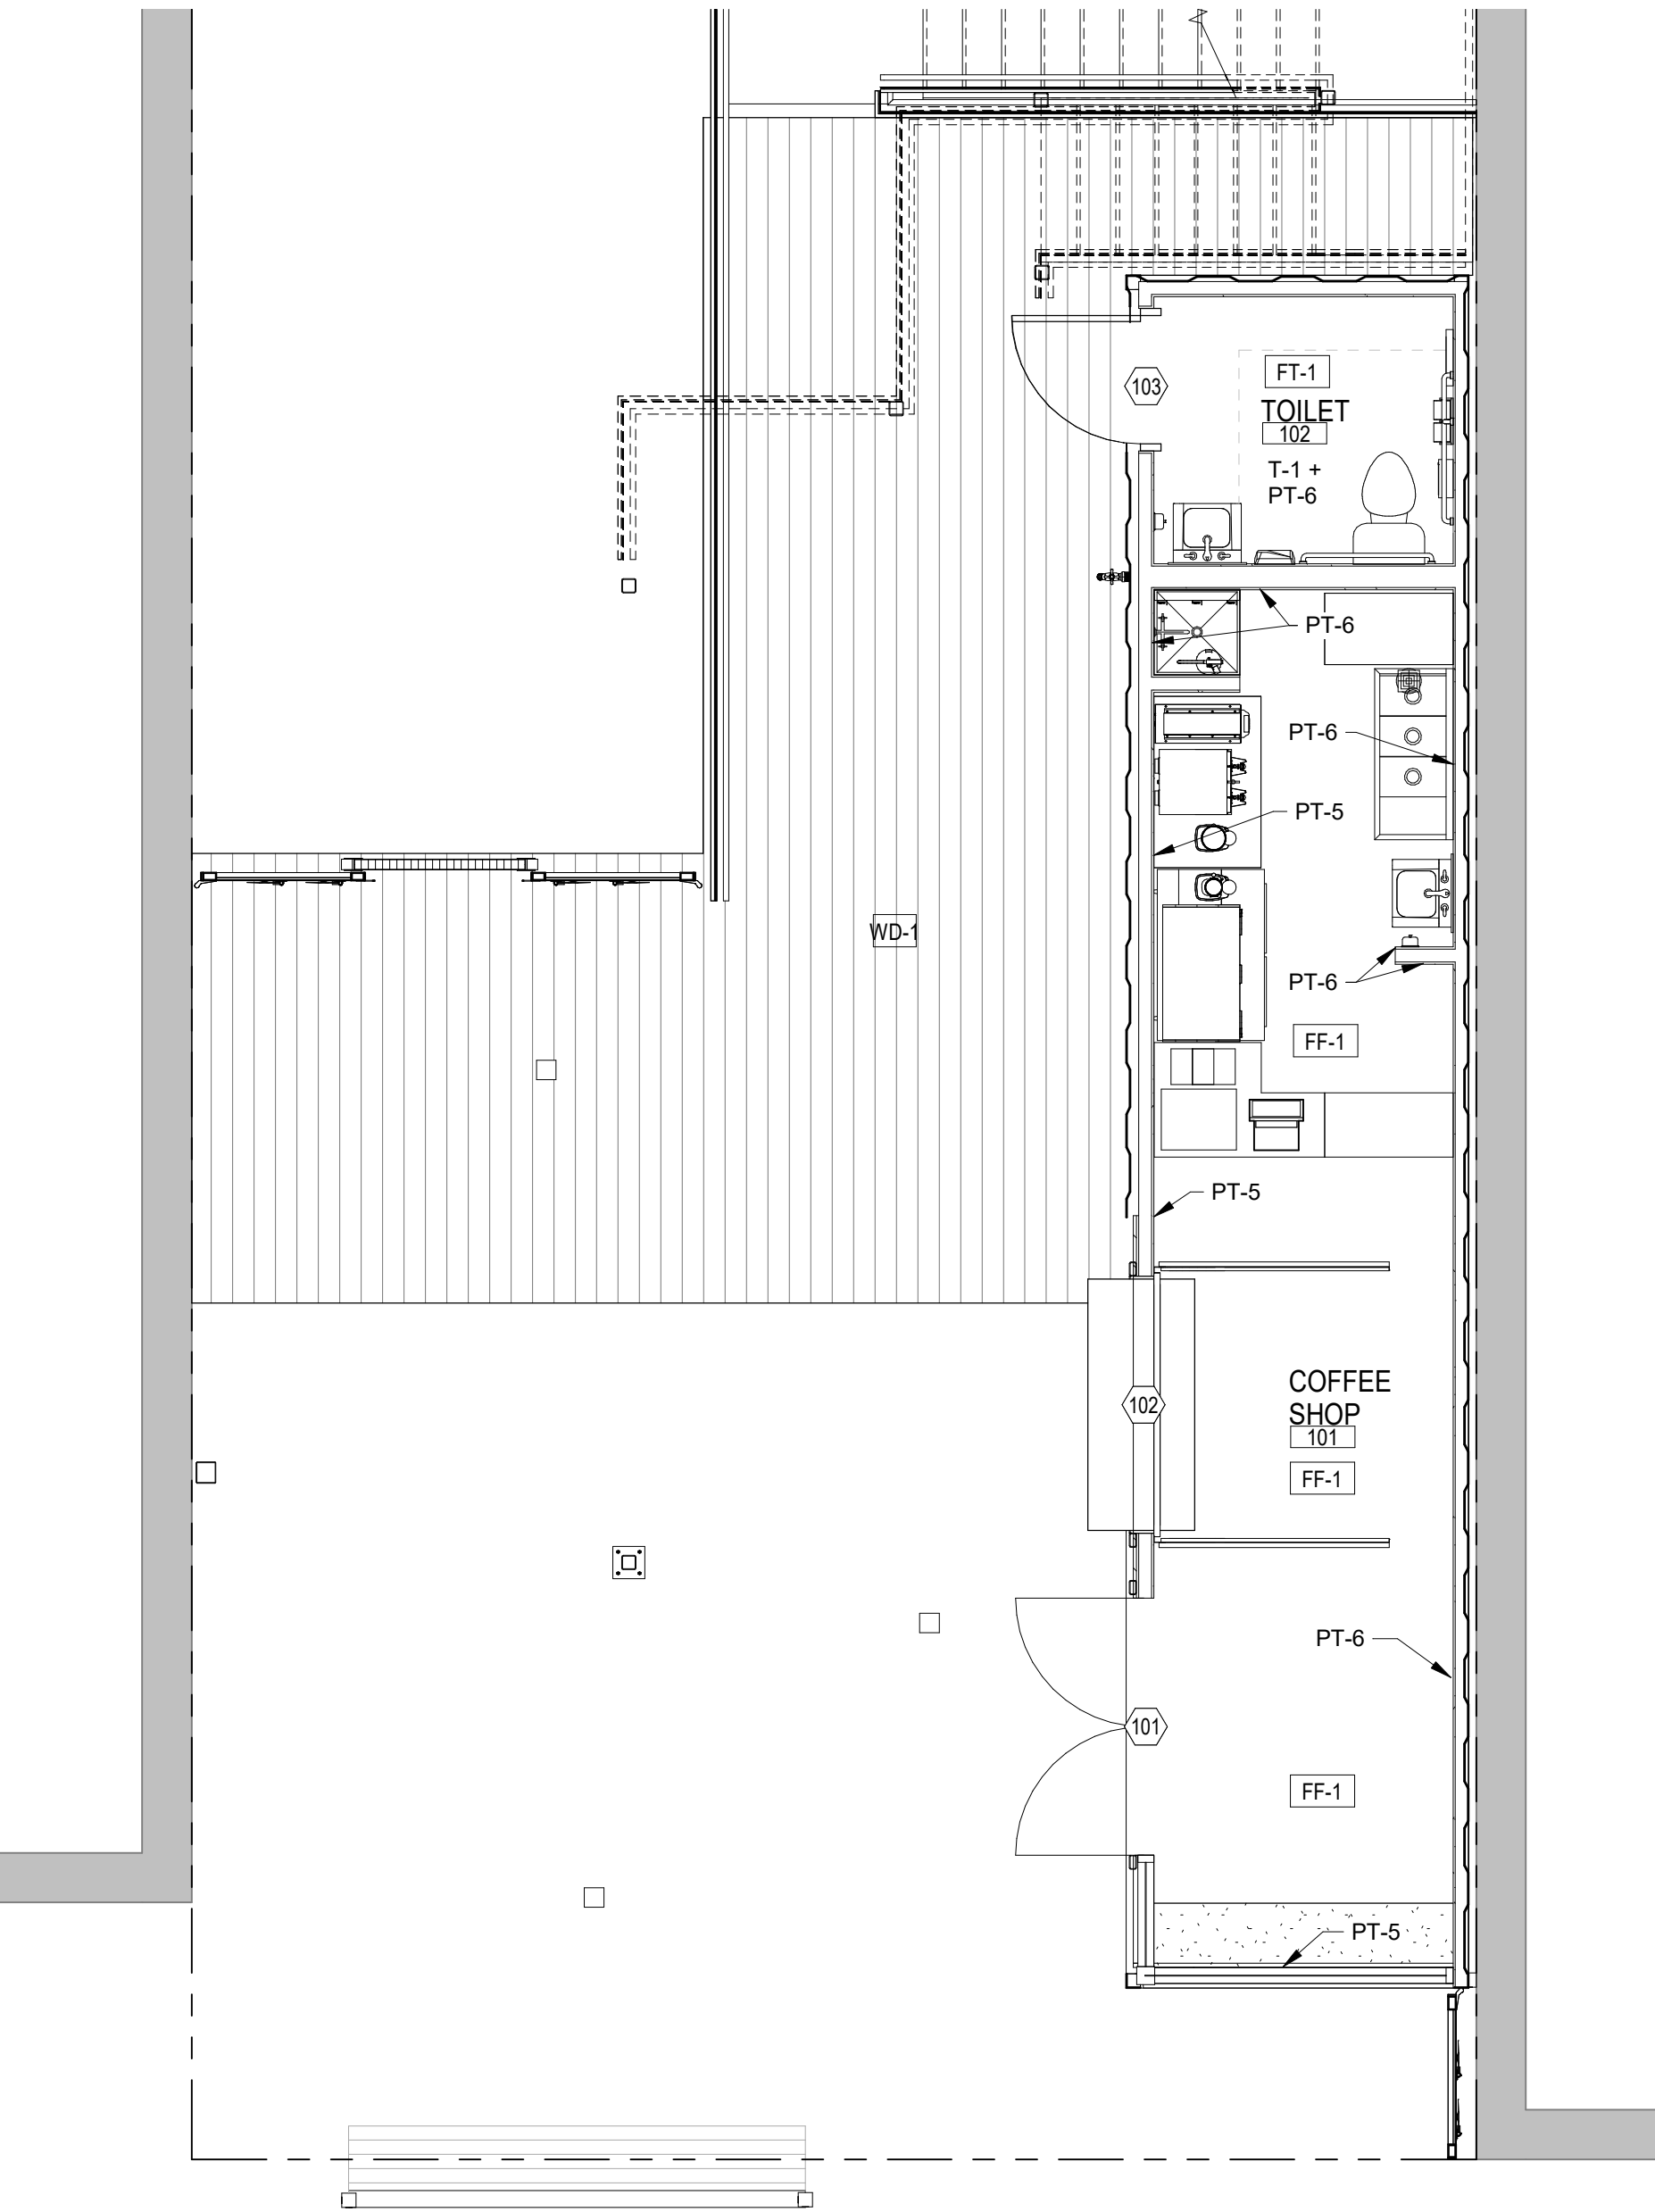

1 FINISH PLAN - COFFEE SHOP  
1/4" = 1'-0"

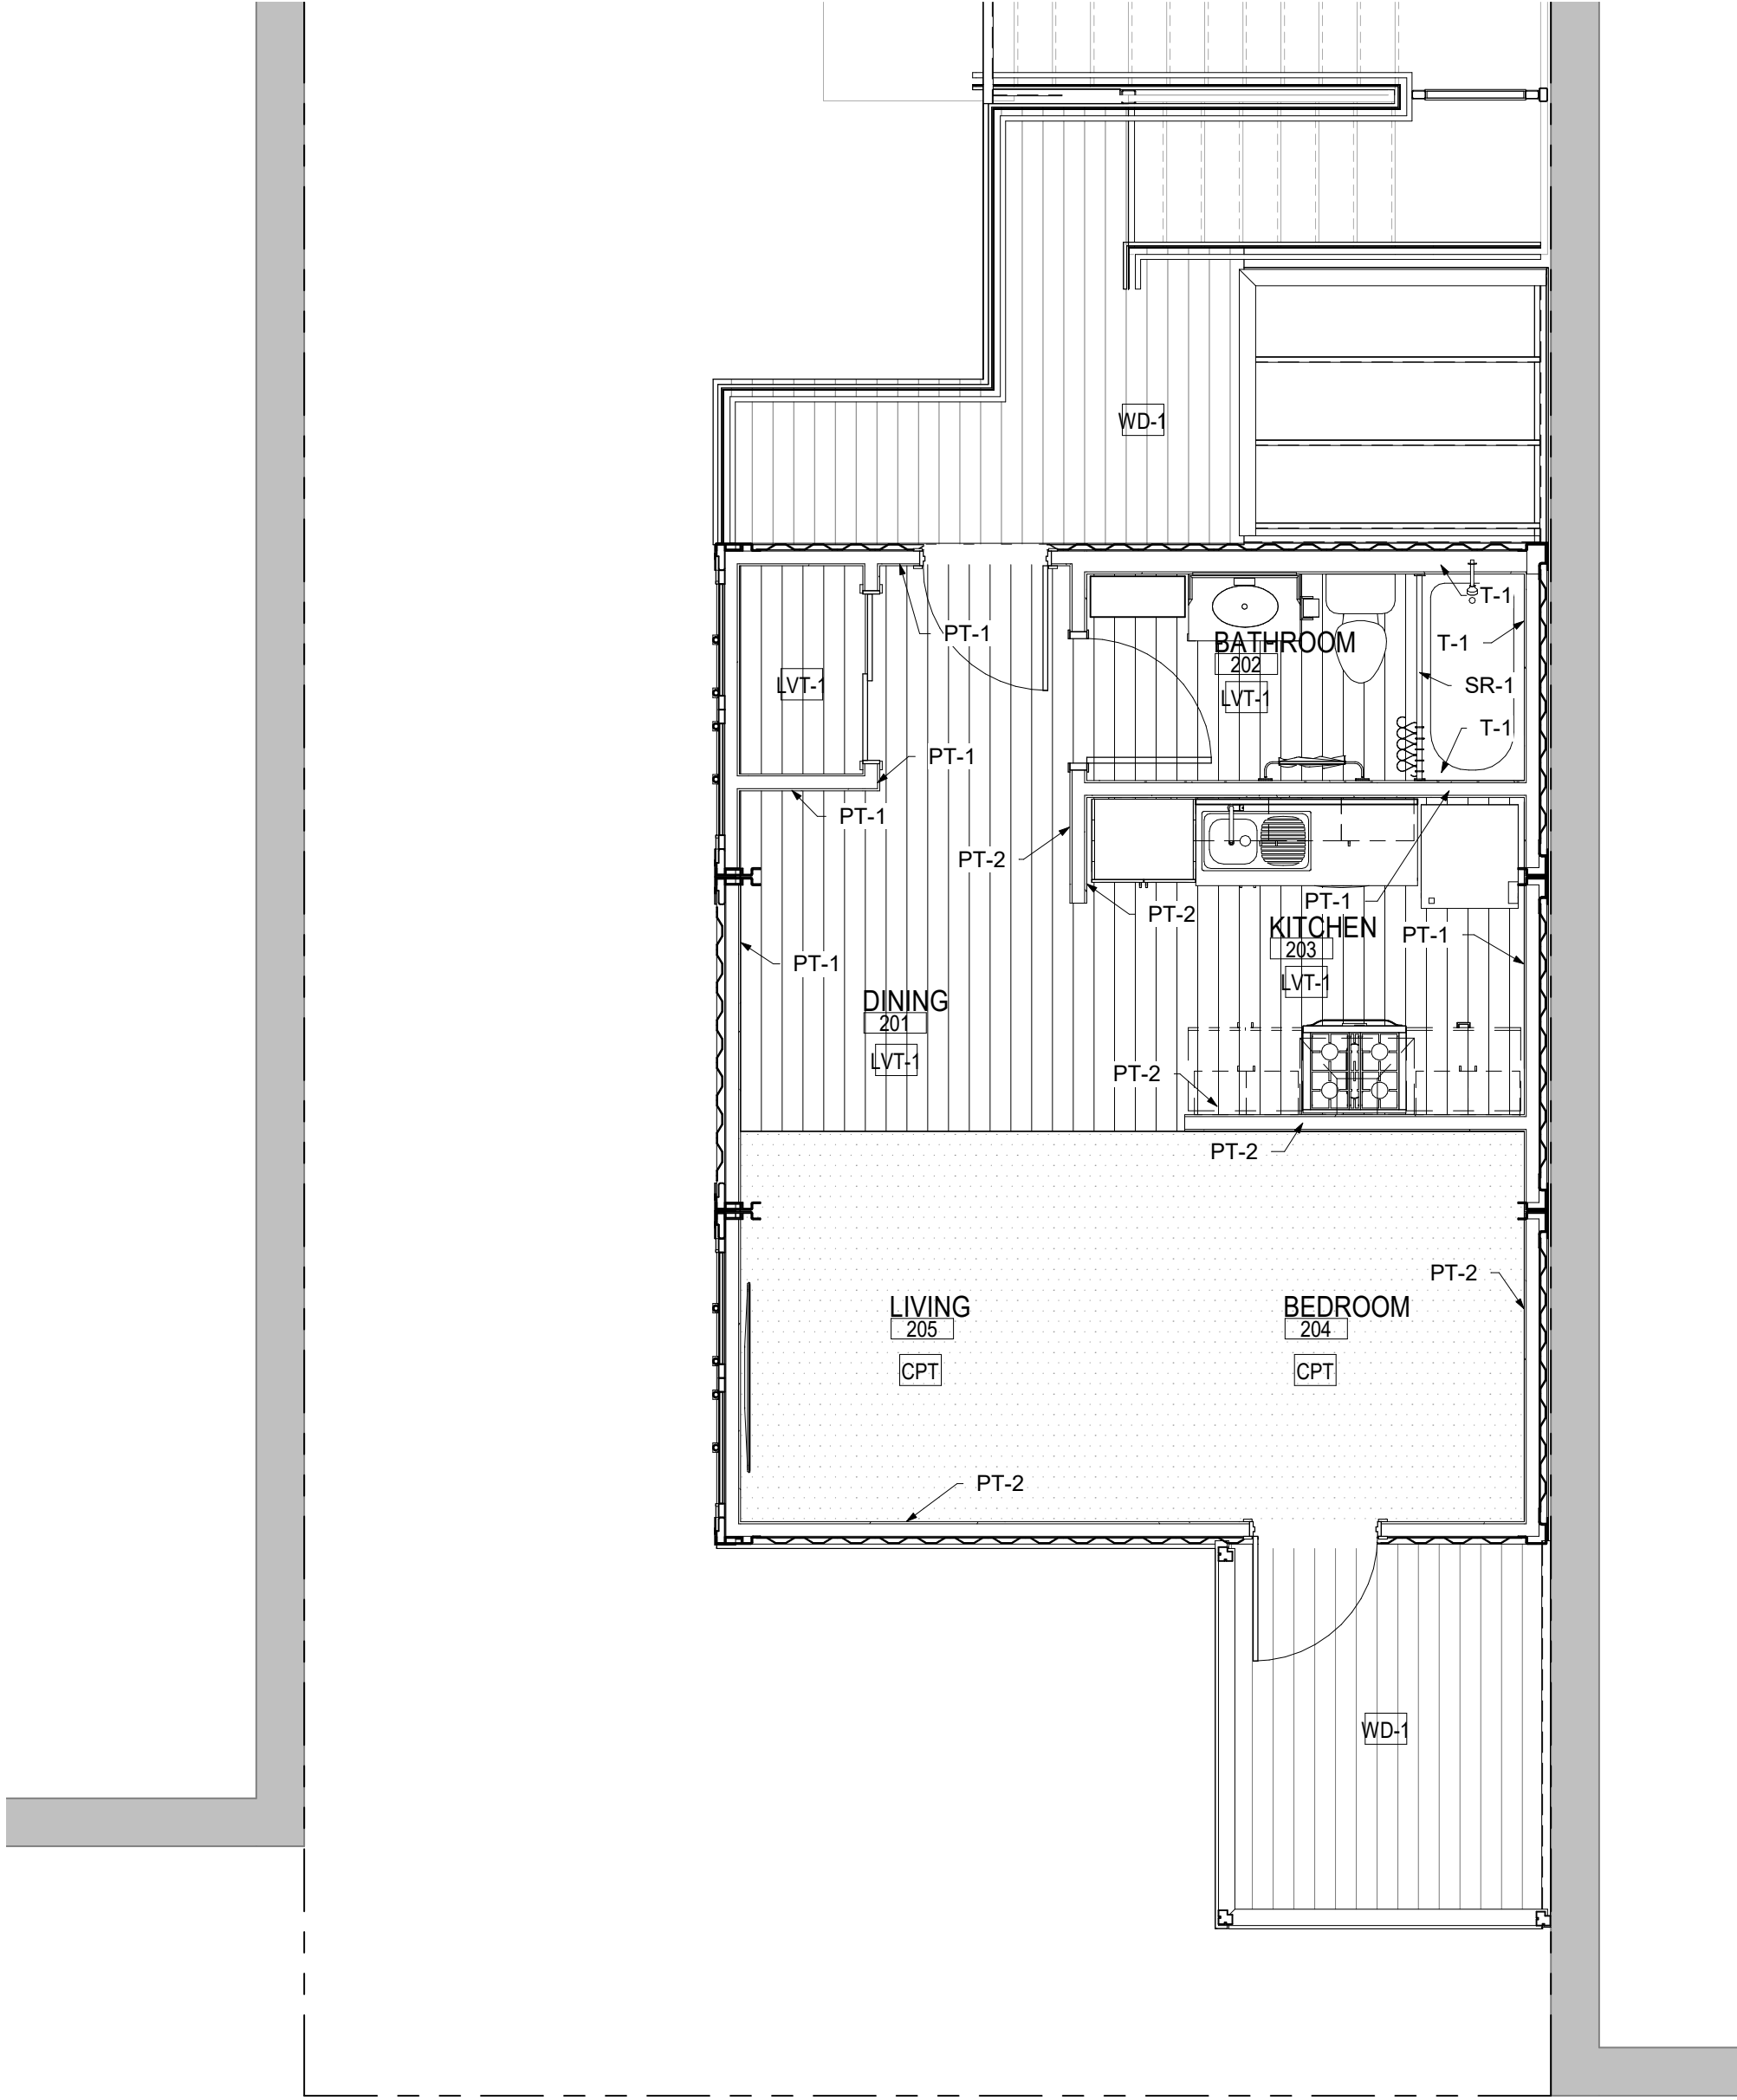

2 FINISH PLAN - APARTMENT  
1/4" = 1'-0"

REGISTERED ARCHITECT  
PENNSYLVANIA  
CRAIG A. SLOCUM  
No. 000000000  
Exp. 12/31/2020

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CRAIG A. SLOCUM, ARCHITECT

AGENCY SET

PROJECT  
19176

DATE  
05-07-2020

DRAWN  
LMV

CHECKED  
JSG / CAS

REVISED

SHEET TITLE

FLOOR  
FINISH PLANS


SHEET

111

ORIGINAL SHEET SIZE  
24" x 36"

5/7/2020, 10:27:56 AM




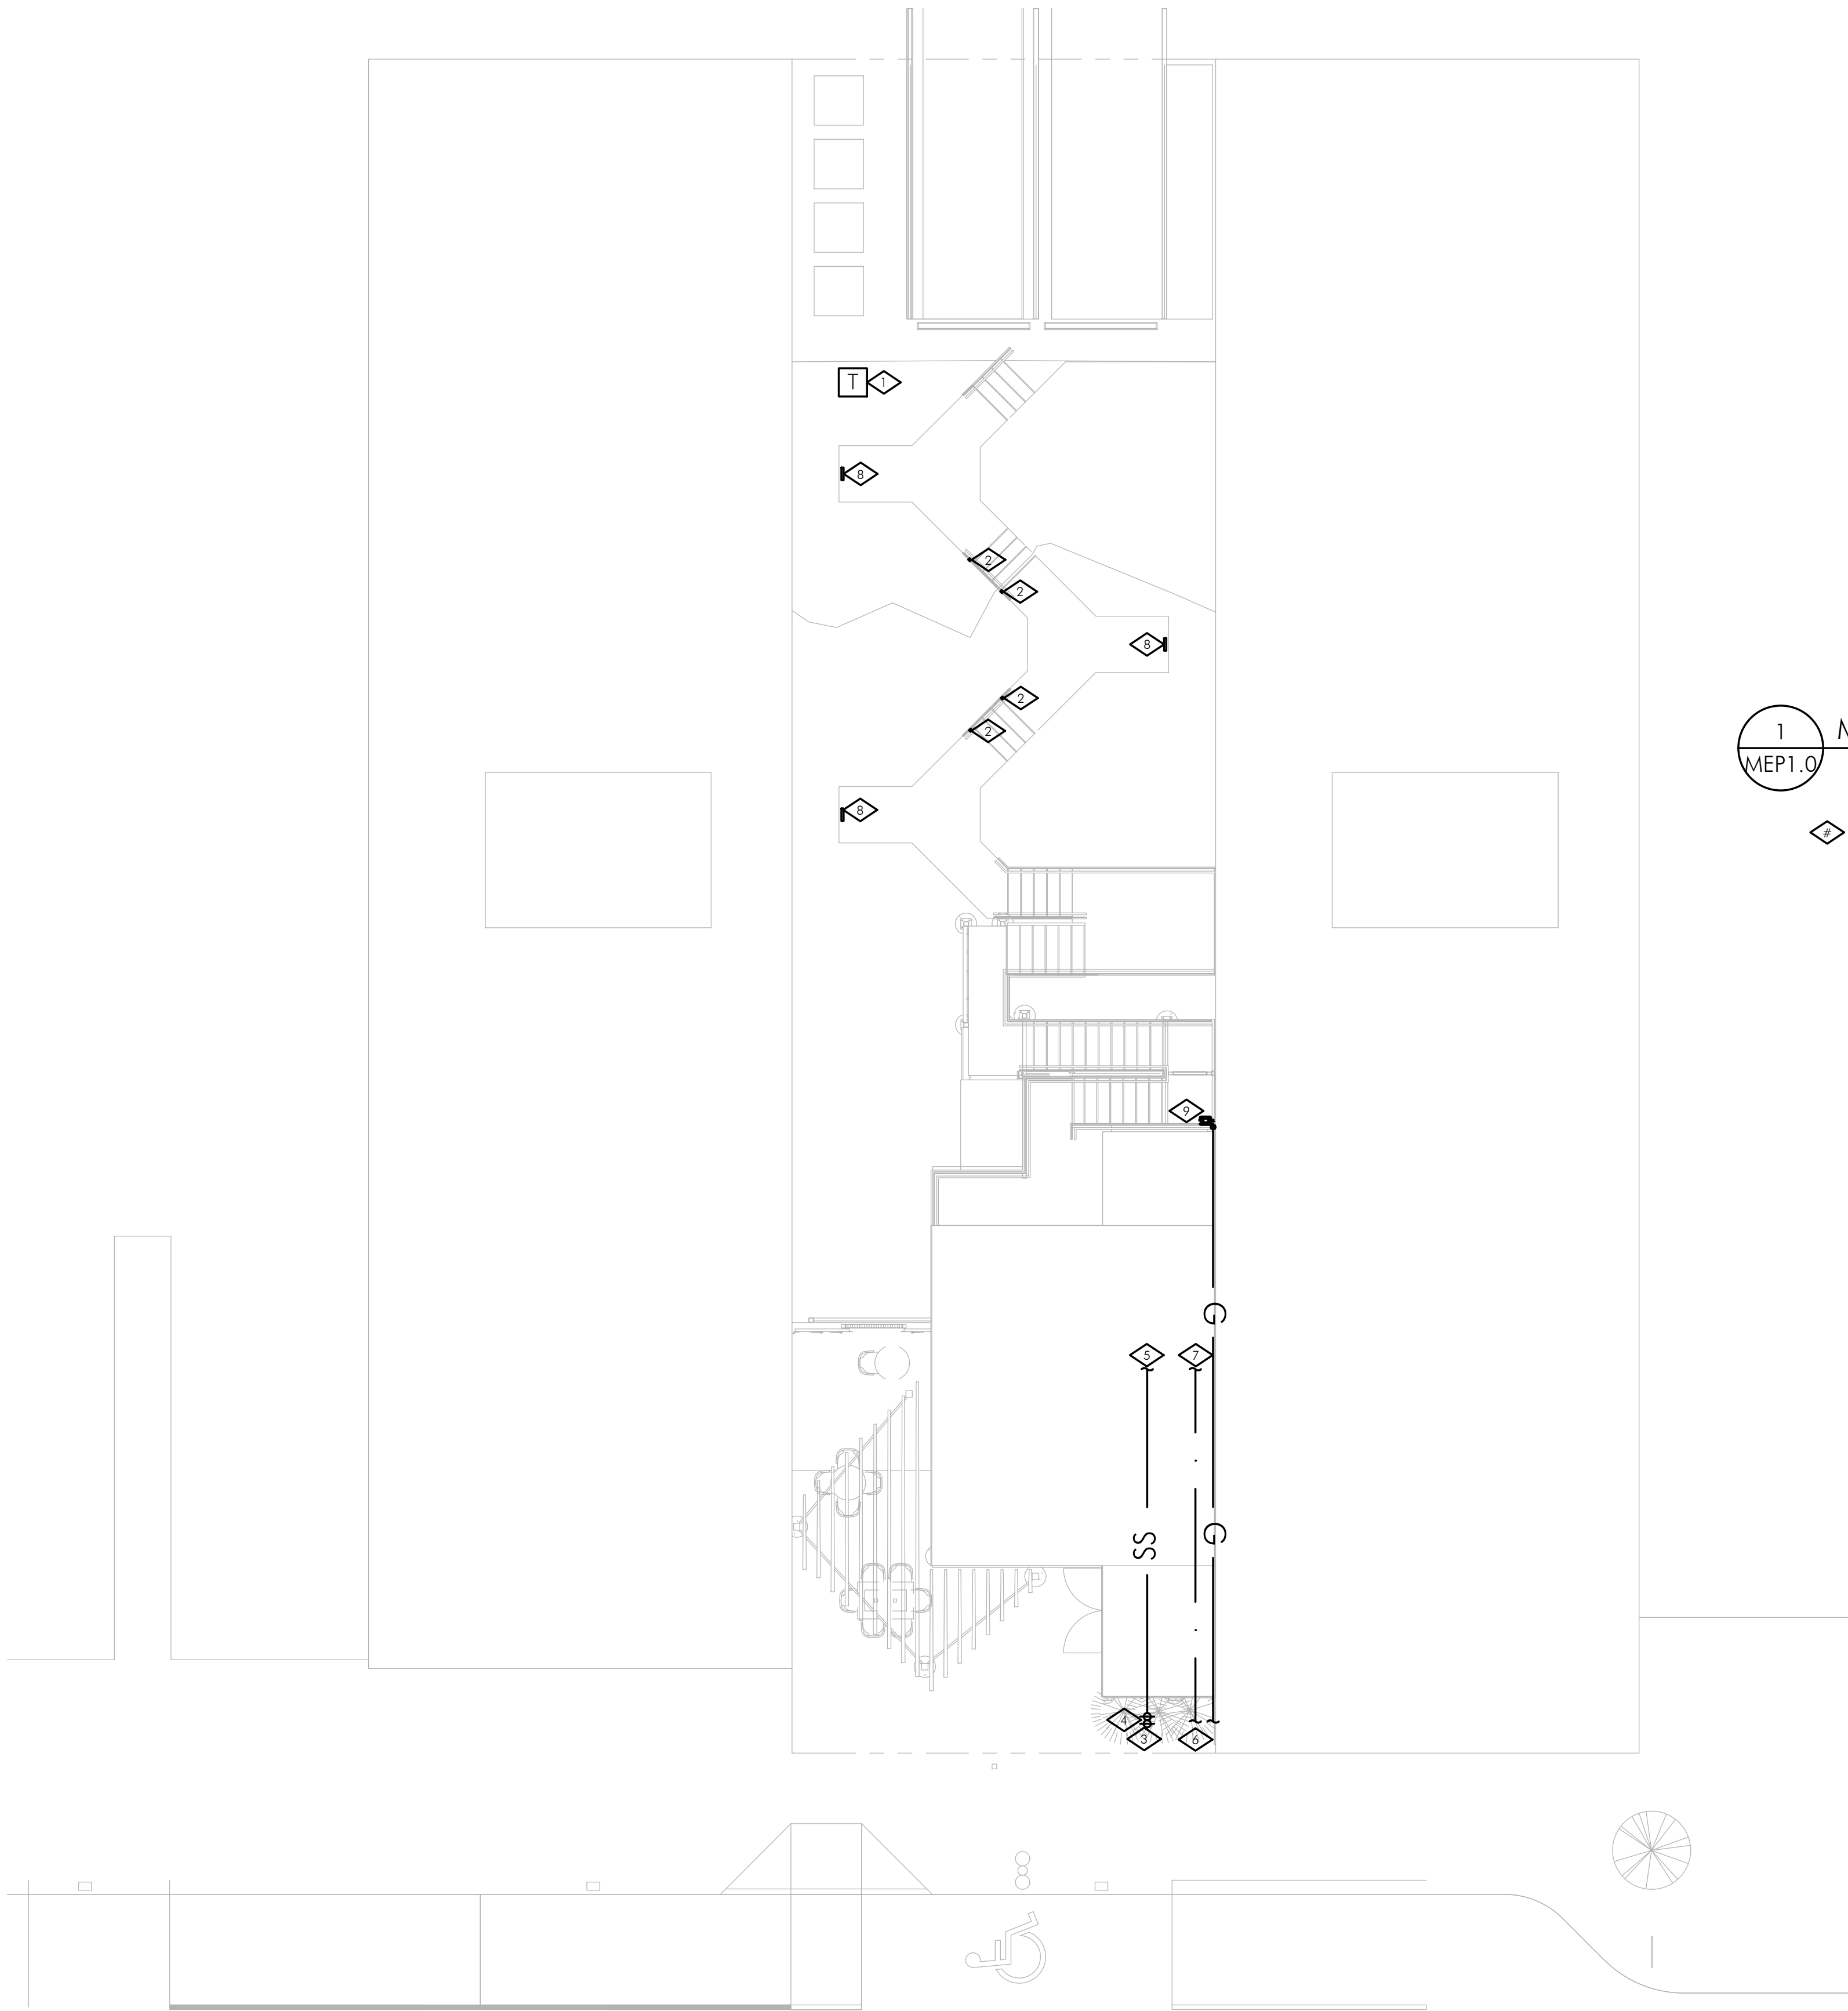

1  
MEP1.0


## MEP SITE PLAN

SCALE: NTS

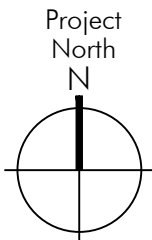

### SITE PLAN KEYED NOTES:

1. ASSUMED UTILITY TRANSFORMER LOCATION. COORDINATE WITH UTILITY CO. FIELD VERIFY FINAL LOCATION PRIOR TO ANY WORK.
2. PROVIDE STAIR STEP LIGHT, 'SL'. CIRCUIT TO PANEL-A, CIRCUIT #21. FIELD VERIFY FINAL LOCATION PRIOR TO ANY WORK. REF ARCH.
3. SANITARY SEWER FROM UTILITY. COORDINATE WITH CIVIL DRAWINGS. FIELD VERIFY FINAL LOCATION, TIE-IN, AND DIRECTION OF FLOW PRIOR TO ANY WORK.
4. TWO WAY CLEANOUT. LOCATION PER CIVIL DRAWINGS. FIELD VERIFY FINAL DIRECTION OF FLOW, INVERT, AND TIE-IN POINTS PRIOR TO ANY WORK.
5. SEWER TO CONNECT TO BUILDING IN CRAWL/CHASE UNDER CONTAINERS. FIELD VERIFY FINAL LOCATIONS PRIOR TO ANY WORK.
6. COLD WATER SUPPLY FROM UTILITY. COORDINATE WITH CIVIL DRAWINGS. FIELD VERIFY FINAL LOCATION PRIOR TO ANY WORK.
7. COLD WATER TO CONTINUE TO CRAWL/CHASE UNDER CONTAINERS. WATER METER AND WATER ENTRY ASSEMBLY TO BE IN CRAWL/CHASE. RE: PLUMBING & CIVIL.
8. BOLLARD LIGHT FIXTURE, 'BL'. CIRCUIT TO PANEL-A, CIRCUIT #21. FIELD VERIFY FINAL LOCATION PRIOR TO ANY WORK. REF: ARCH.
9. PROVIDE GAS METER UNDER STAIRS IN A UTILITY CO. AND AHJ APPROVED LOCATION. FIELD VERIFY FINAL LOCATION PRIOR TO ANY WORK. COORDINATE WITH CIVIL.

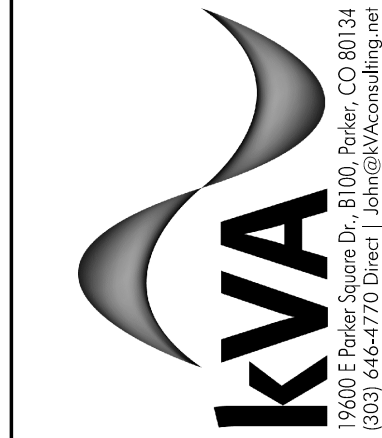

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PROJECT KVA 19-121	DATE 02/10/2020
DRAWN TMK	CHECKED JPT

REVISED

SHEET TITLE

**MEP SITE PLAN**

SHEET


**MEP1.0**

ORIGINAL SHEET SIZE  
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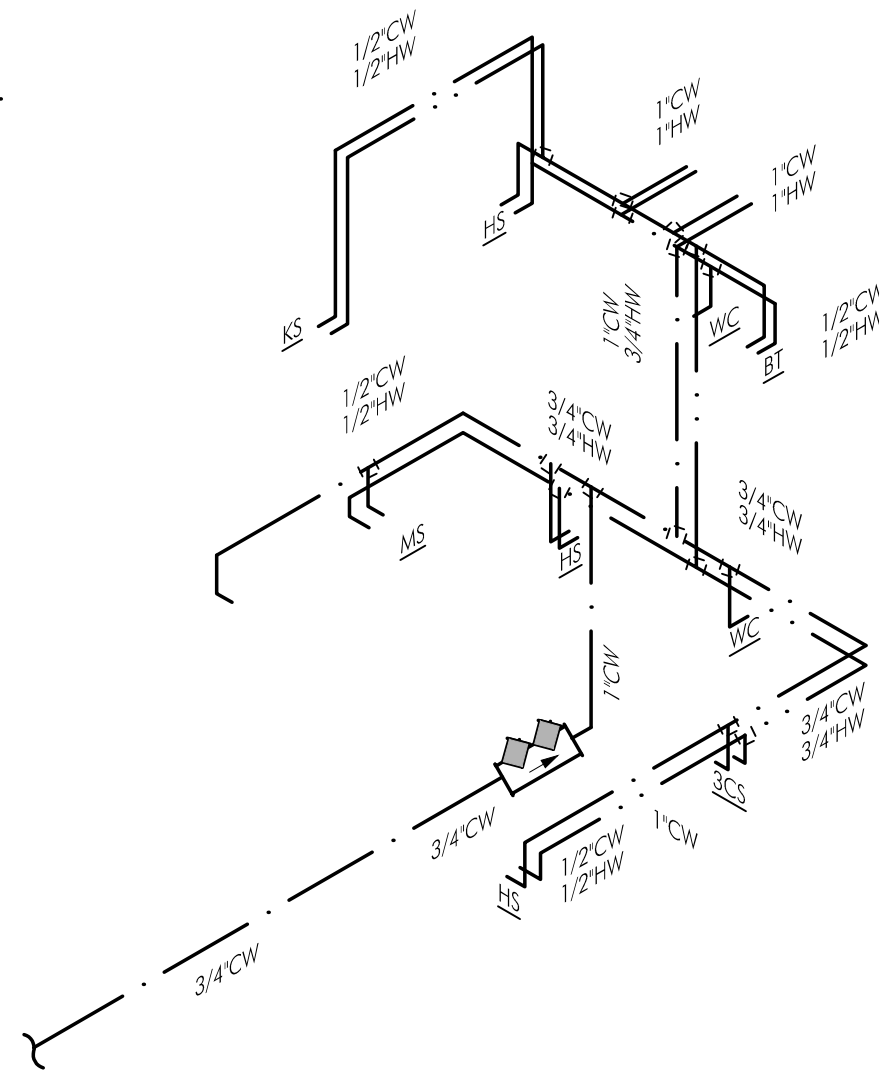







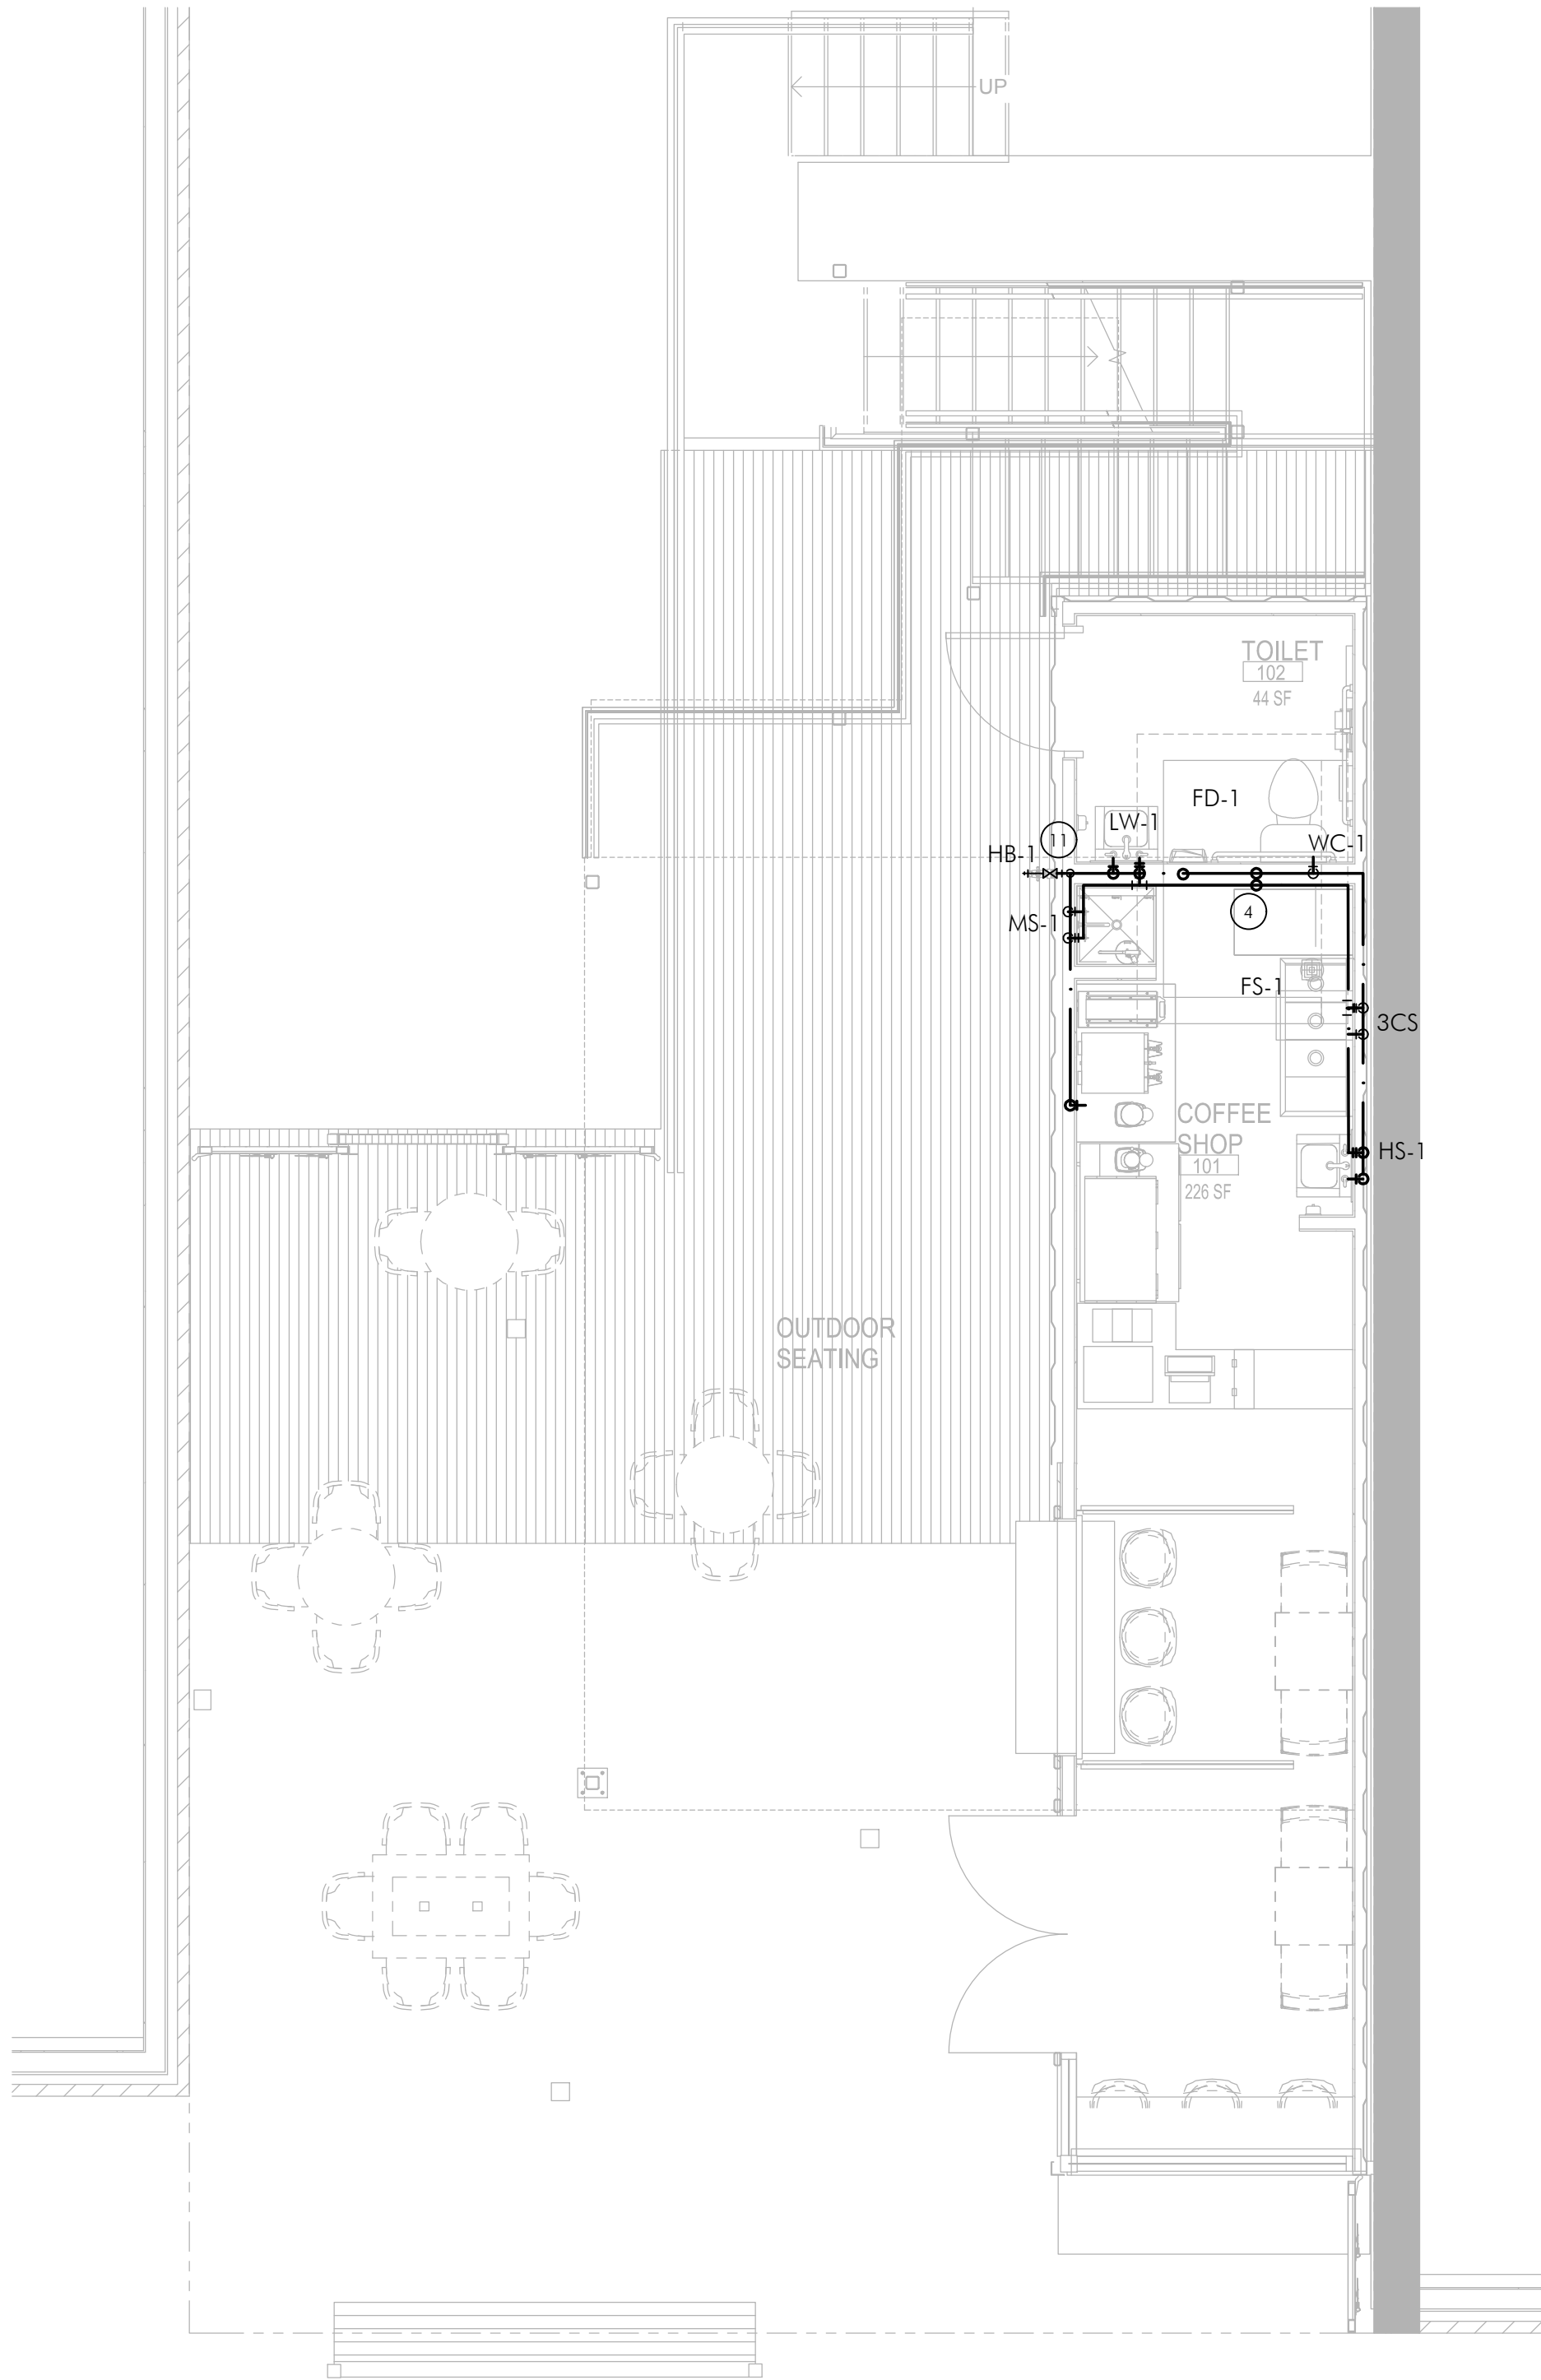


1 WATER PLAN - 1ST FLOOR COFFEE  
P1.0 SCALE: 1/4"=1'-0"



4 WATER ISOMETRIC  
P1.0 SCALE: NONE

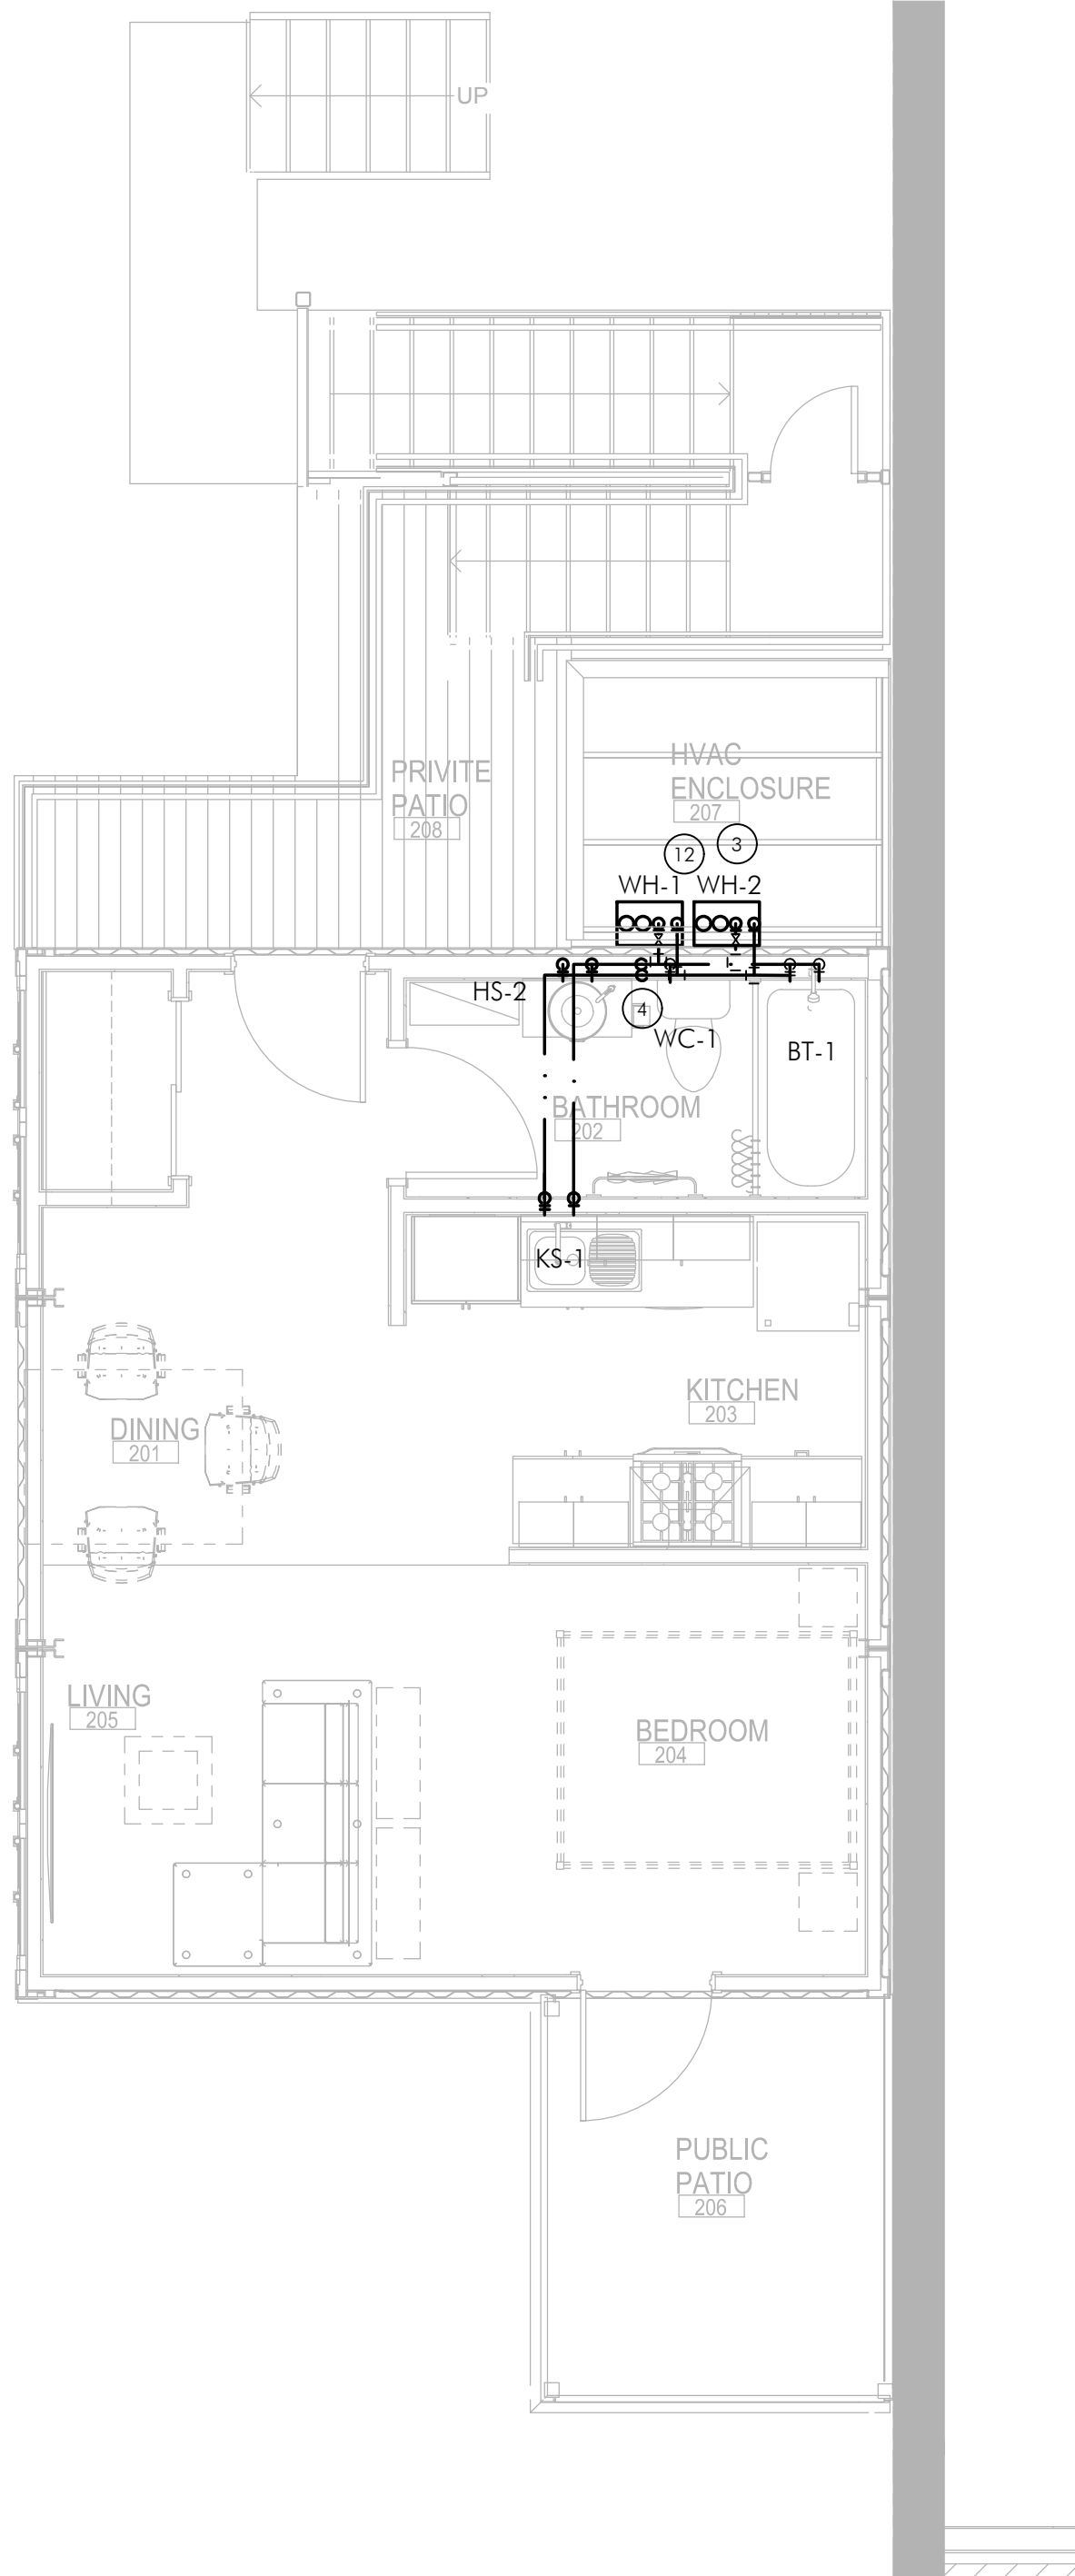


2 WATER PLAN - 2ND FLOOR APT.  
P1.0 SCALE: 1/4"=1'-0"

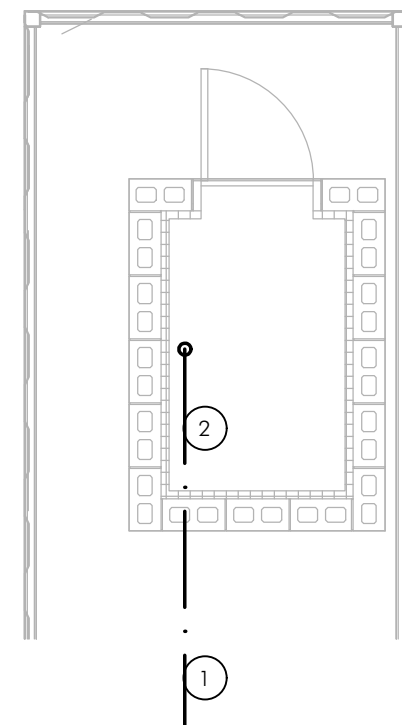

3 WATER PLAN - CRAWL/WATER ENTRY  
P1.0 SCALE: 1/4"=1'-0"

#### PLUMBING SHEET NOTES

- NOTE: NOT ALL NOTES ARE USED ON THIS SHEET.
- NEW 3/4" COLD WATER SUPPLY FROM UTILITY.
  - PROVIDE NEW WATER ENTRY ASSEMBLY AND WATER METER WITH REMOTE READ-OUT BENEATH CONTAINERS. PROVIDE ACCESS TO BACKFLOW PREVENTER AND METERS FOR MAINTENANCE.
  - EXTERIOR TANKLESS GAS WATER HEATERS IN TANDEM MOUNTED ON WALL IN HVAC AREA.
  - 1" CW & 3/4" HW DOWN IN WALL.
  - CONNECT 3" SS TO UTILITY SS. VERIFY INVERT AND DIRECTION OF FLOW PRIOR TO ANY WORK.
  - 3" VENT TO ROOF.
  - NO HORIZONTAL CONNECTIONS FOR AT LEAST 30" AFTER WASTE STACK TO ACCOUNT FOR HYDRAULIC JUMP PER IPC 704.3.
  - SHOWER SHALL BE ELEVATED AS NECESSARY TO ACCOUNT FOR P-TRAP.
  - MOP SINK SHALL BE ELEVATED AS NECESSARY TO ACCOUNT FOR P-TRAP.
  - ROUTE 2" WASTE LINE FROM APARTMENT KITCHEN SINK IN WALL.
  - HOSE BIB SHALL BE OF THE FREEZE-LESS TYPE.
  - PROVIDE FREEZE PROTECTION FOR WATER HEATER EXTERIOR WATER LINES BY MEANS OF THE WATER HEATER MANUFACTURER'S ACCESSORIES OR HEAT TRACE. INSTALL PER MANUFACTURER'S RECOMMENDATIONS, ALL APPLICABLE CODES, AND THE AHJ.

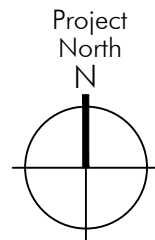

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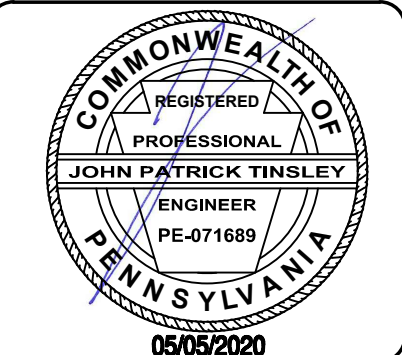
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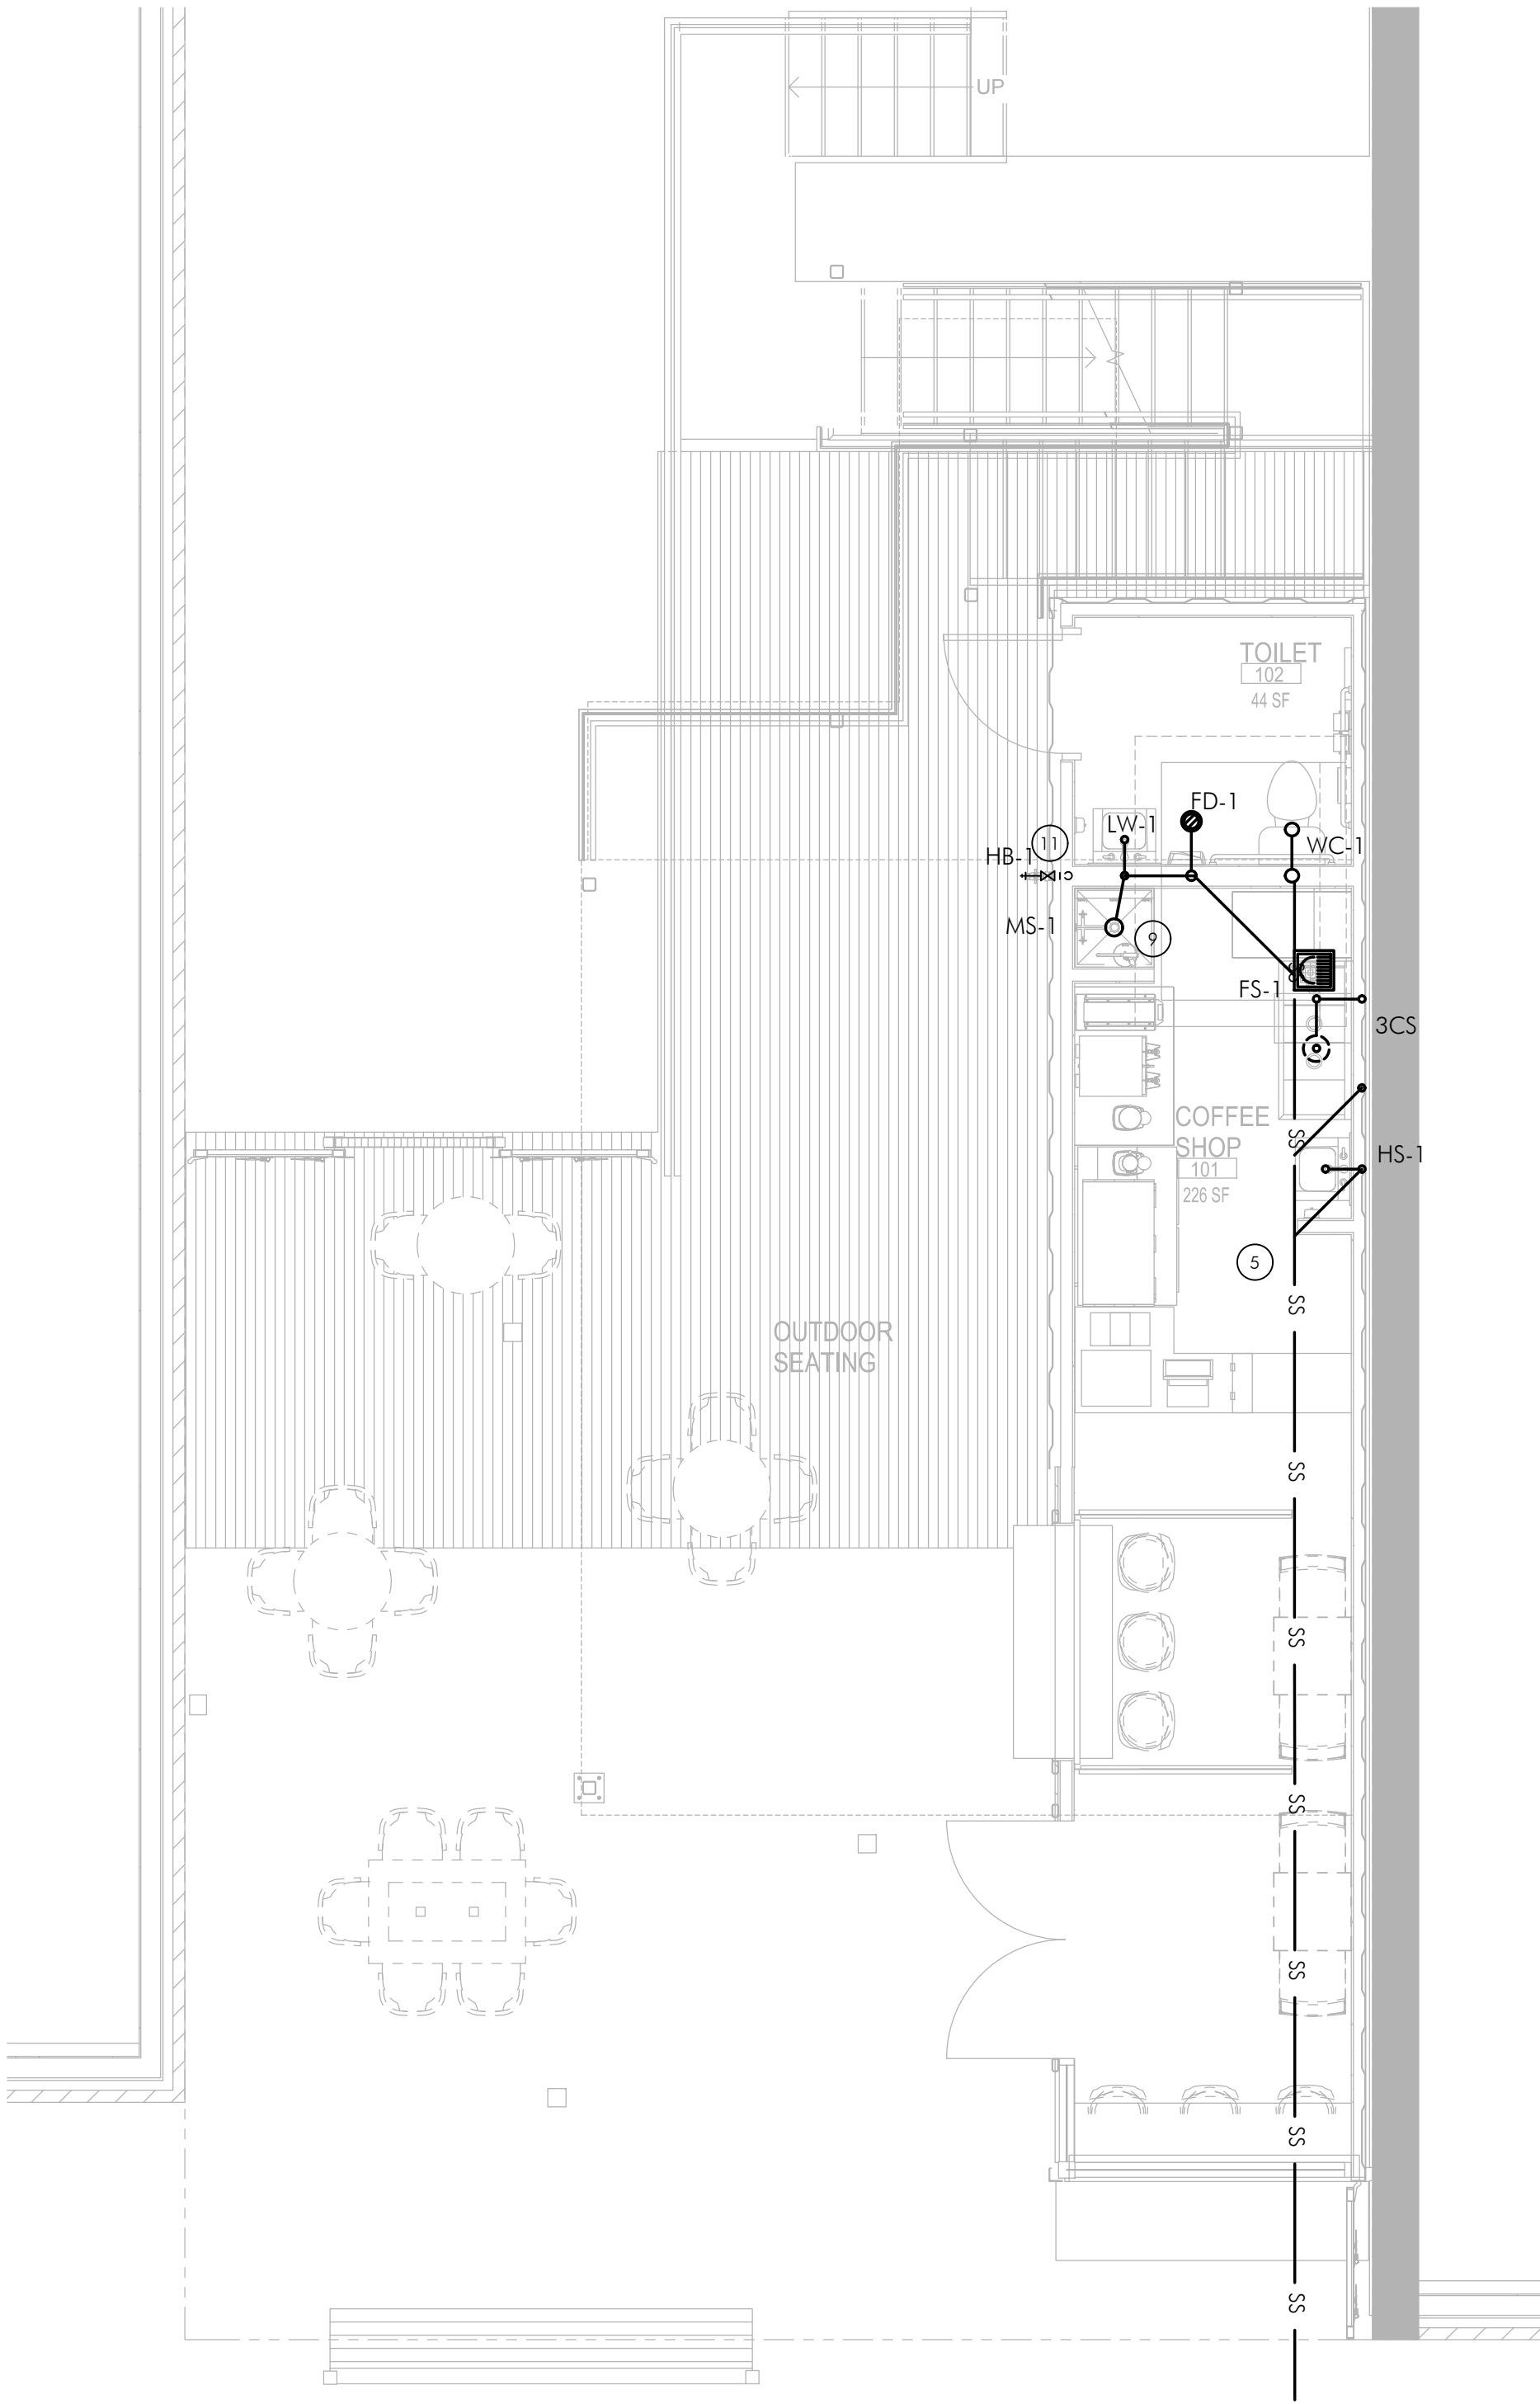
PROJECT KVA 19-121	DATE 02/10/2020
DRAWN TMK	CHECKED JPT

REVISED


SHEET TITLE  
**PLUMBING  
PLANS - WATER**

SHEET  
**P1.0**  
ORIGINAL SHEET SIZE  
24" x 36"






1 WASTE PLAN - 1ST FLOOR COFFEE  
P1.1 SCALE: 1/4"=1'-0"

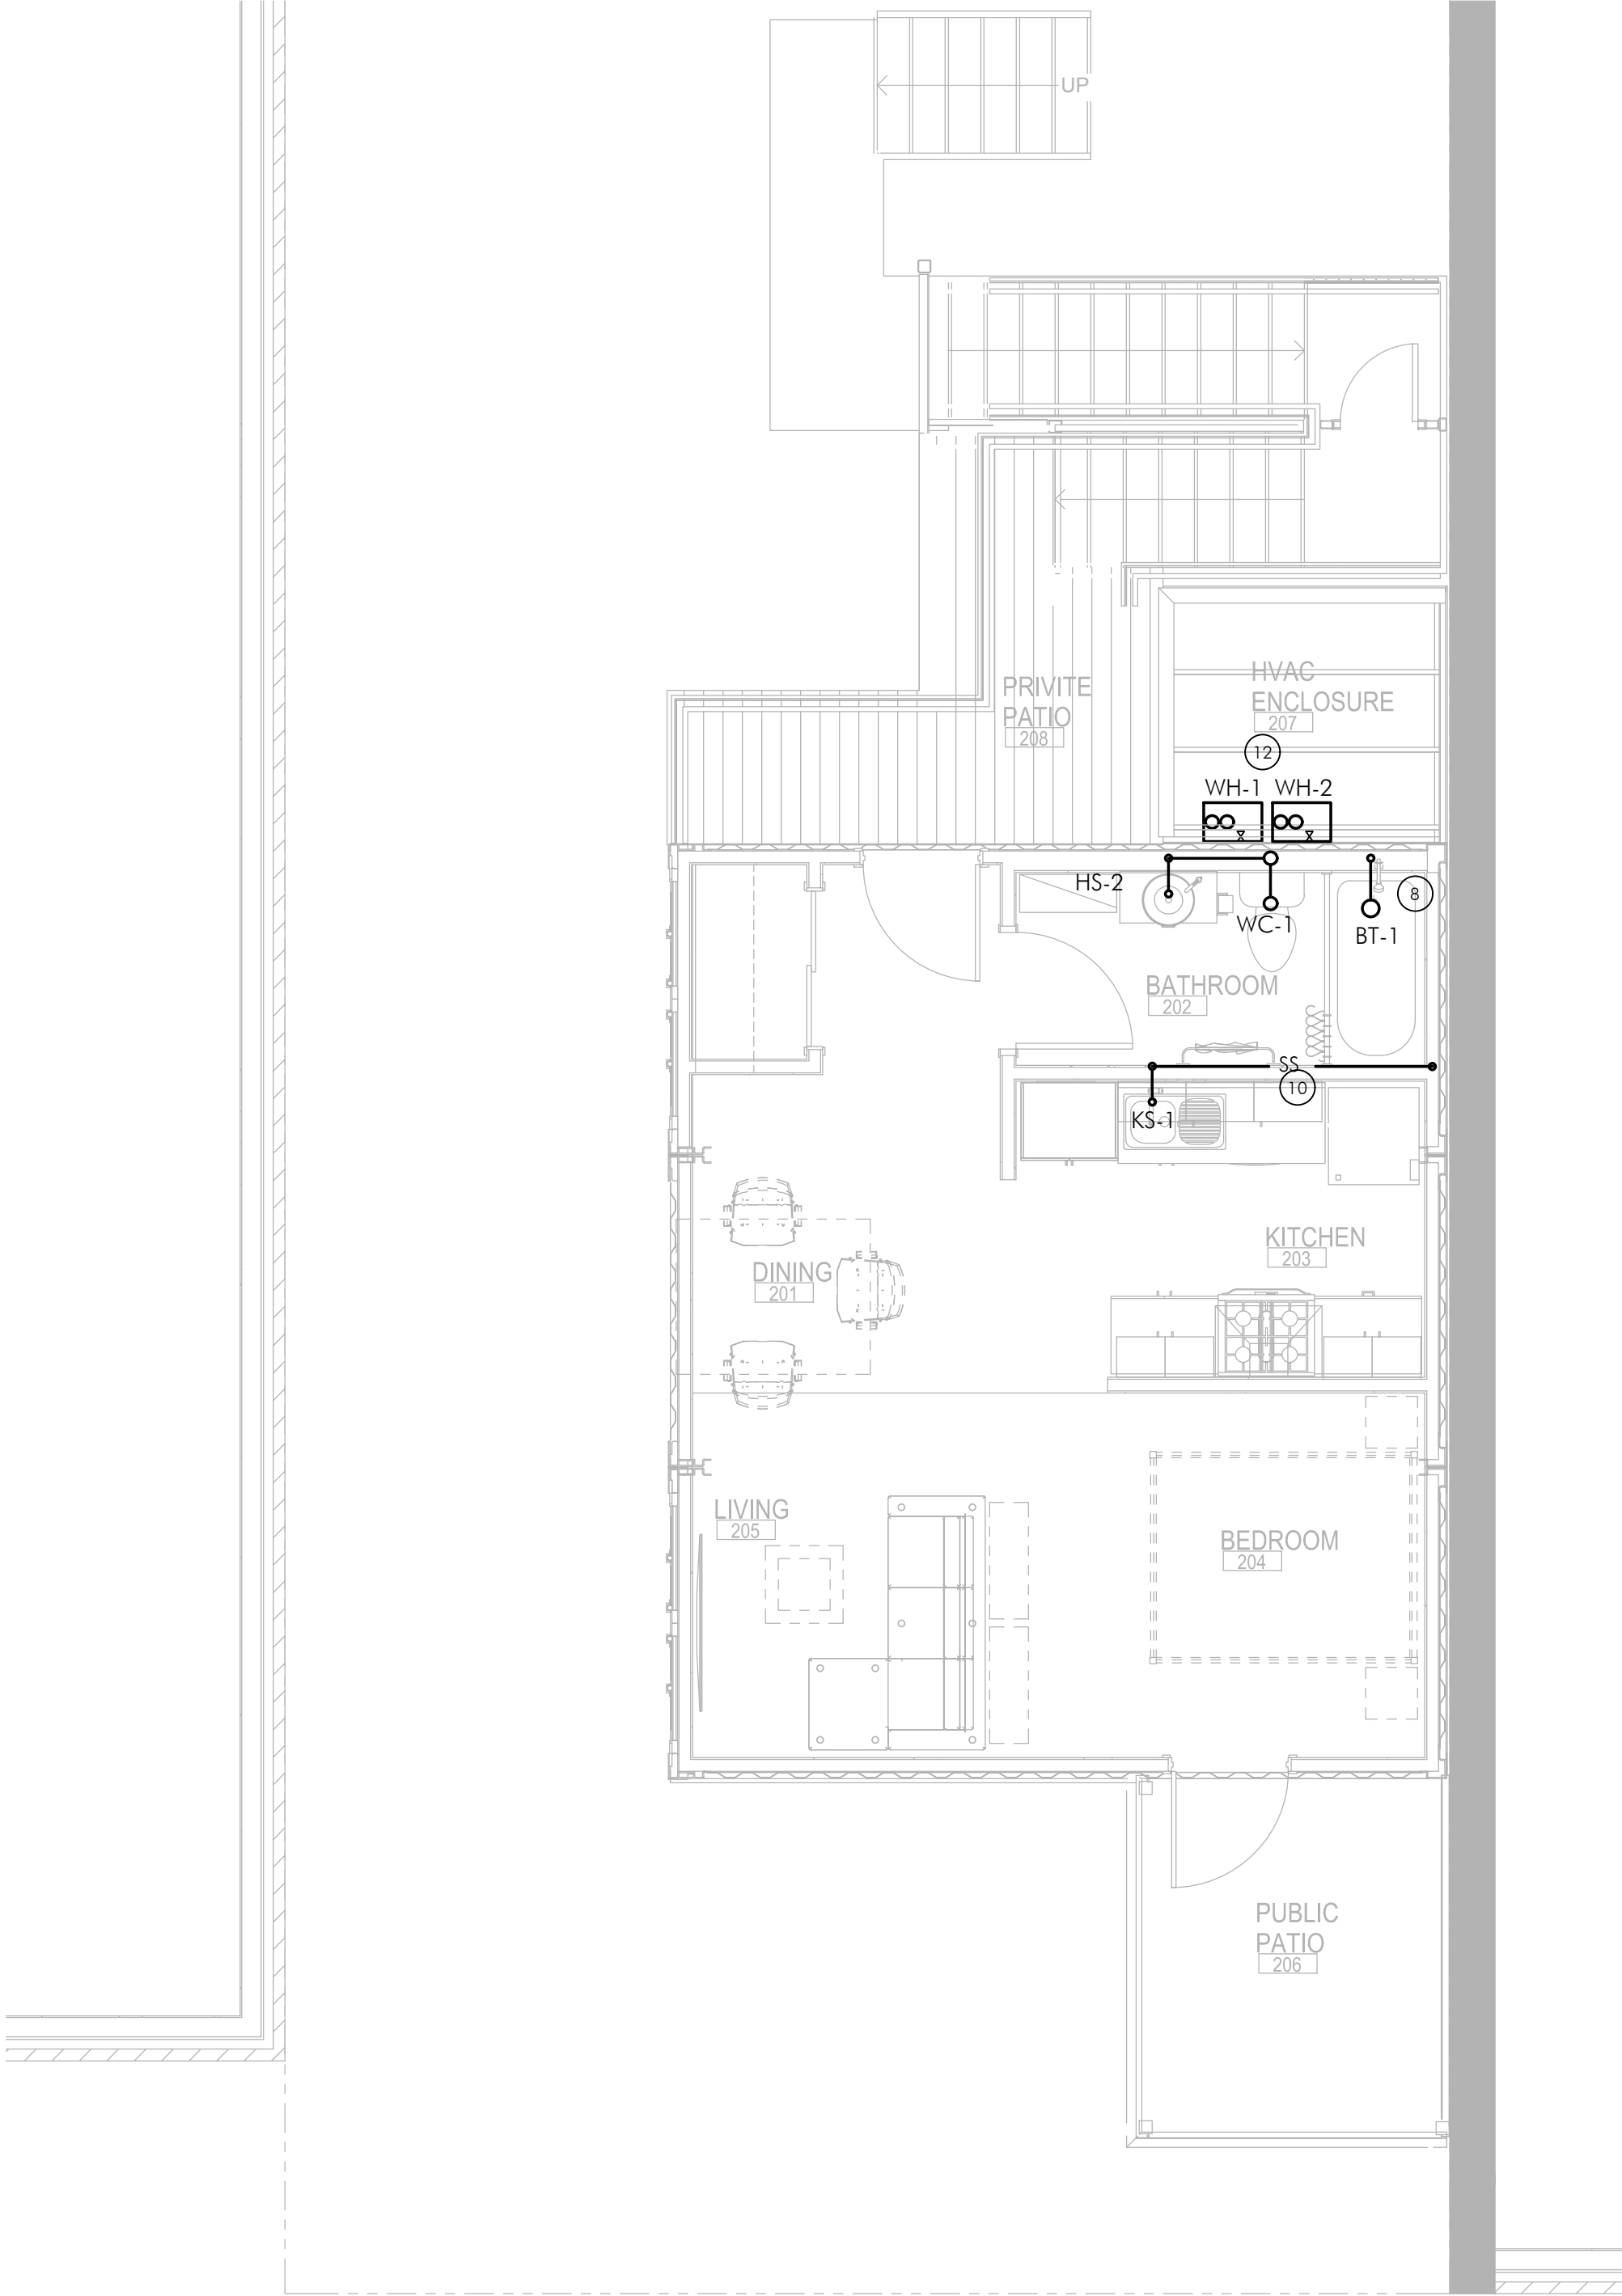

2 WASTE PLAN - 2ND FLOOR APT.  
P1.1 SCALE: 1/4"=1'-0"

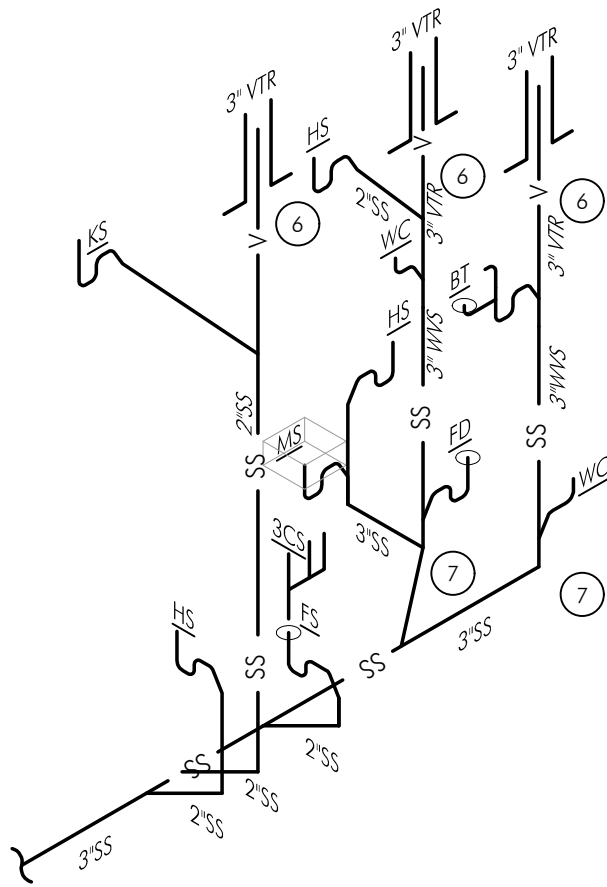

3 WASTE ISOMETRIC  
P1.1 SCALE: NONE

- PLUMBING SHEET NOTES (#)
- NOTE: NOT ALL NOTES ARE USED ON THIS SHEET.
1. NEW 3/4" COLD WATER SUPPLY FROM UTILITY.
  2. PROVIDE NEW WATER ENTRY ASSEMBLY AND WATER METER WITH REMOTE READ-OUT BENEATH CONTAINERS. PROVIDE ACCESS TO BACKFLOW PREVENTER AND METERS FOR MAINTENANCE.
  3. EXTERIOR TANKLESS GAS WATER HEATERS IN TANDEM MOUNTED ON WALL IN HVAC AREA.
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  6. 3" VENT TO ROOF.
  7. NO HORIZONTAL CONNECTIONS FOR AT LEAST 30" AFTER WASTE STACK TO ACCOUNT FOR HYDRAULIC JUMP PER IPC 704.3.
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  12. PROVIDE FREEZE PROTECTION FOR WATER HEATER EXTERIOR WATER LINES BY MEANS OF THE WATER HEATER MANUFACTURER'S ACCESSORIES OR HEAT TRACE. INSTALL PER MANUFACTURER'S RECOMMENDATIONS, ALL APPLICABLE CODES, AND THE AHJ.



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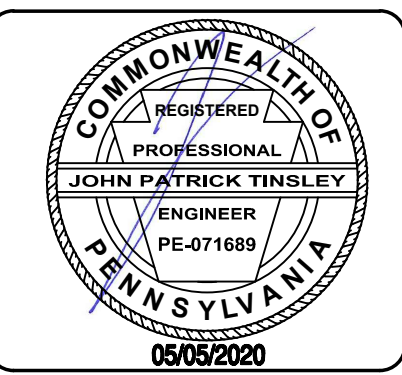
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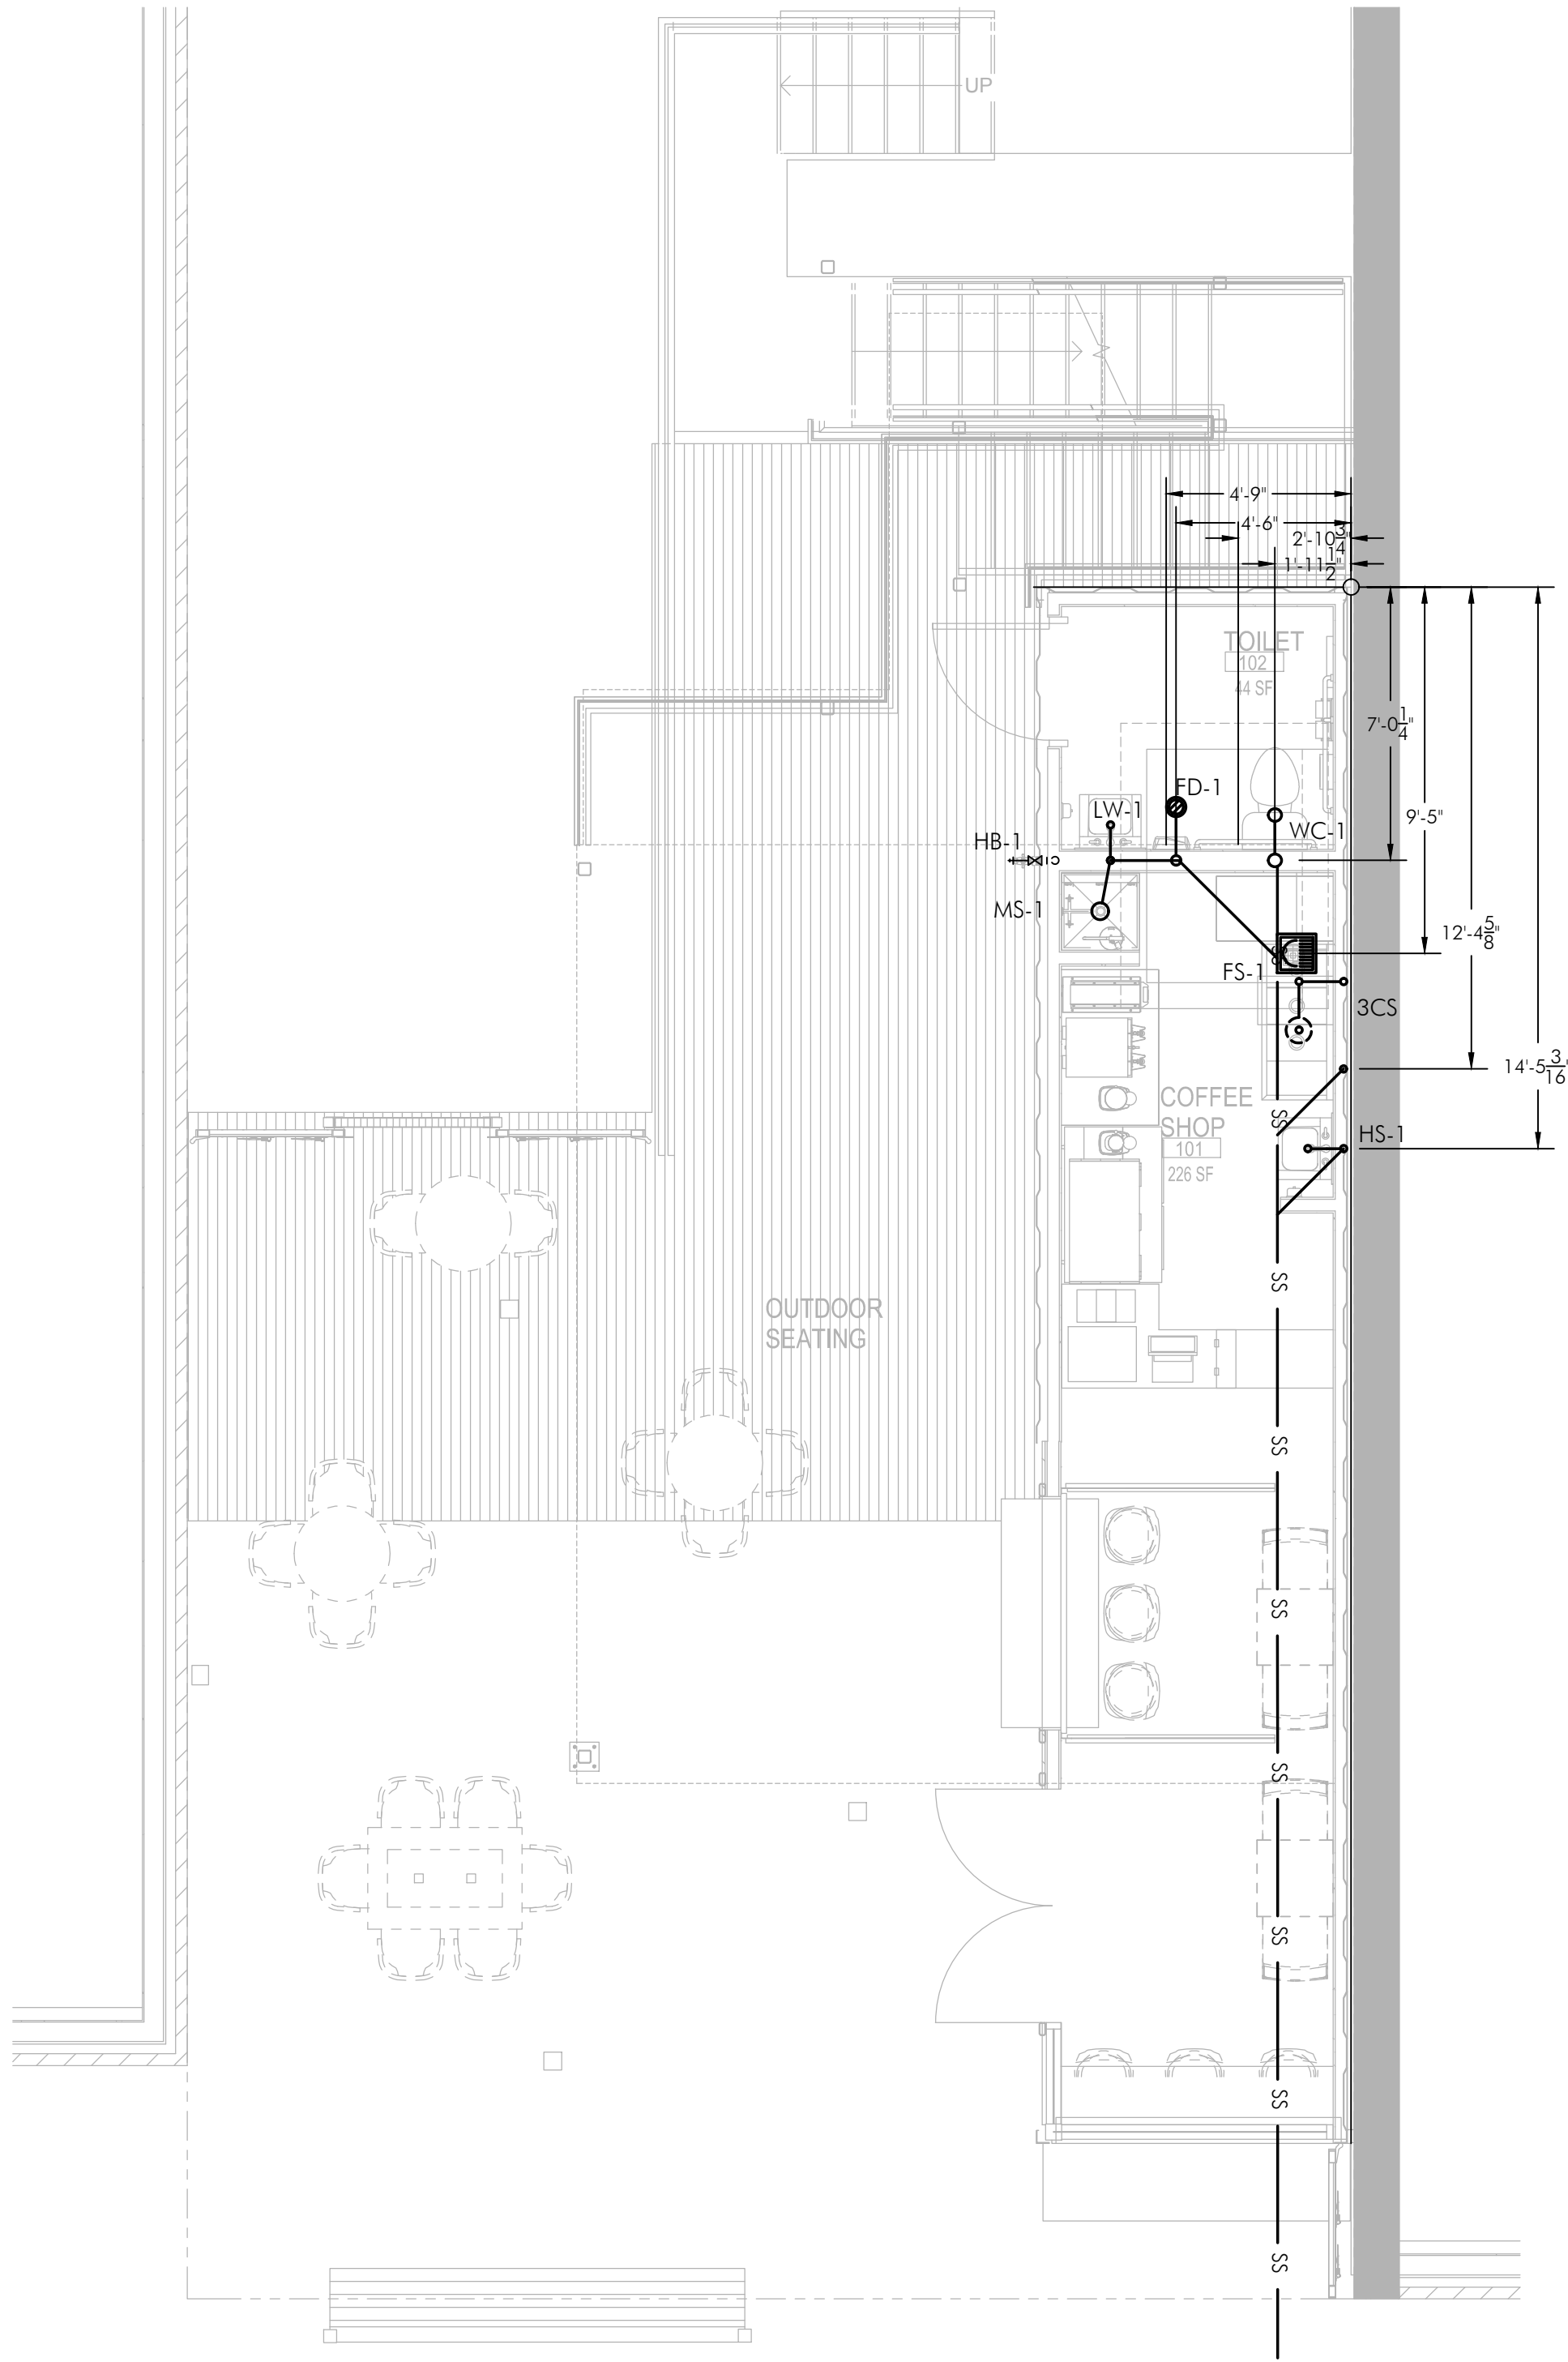
PROJECT KVA 19-121	DATE 02/10/2020
DRAWN TMK	CHECKED JPT

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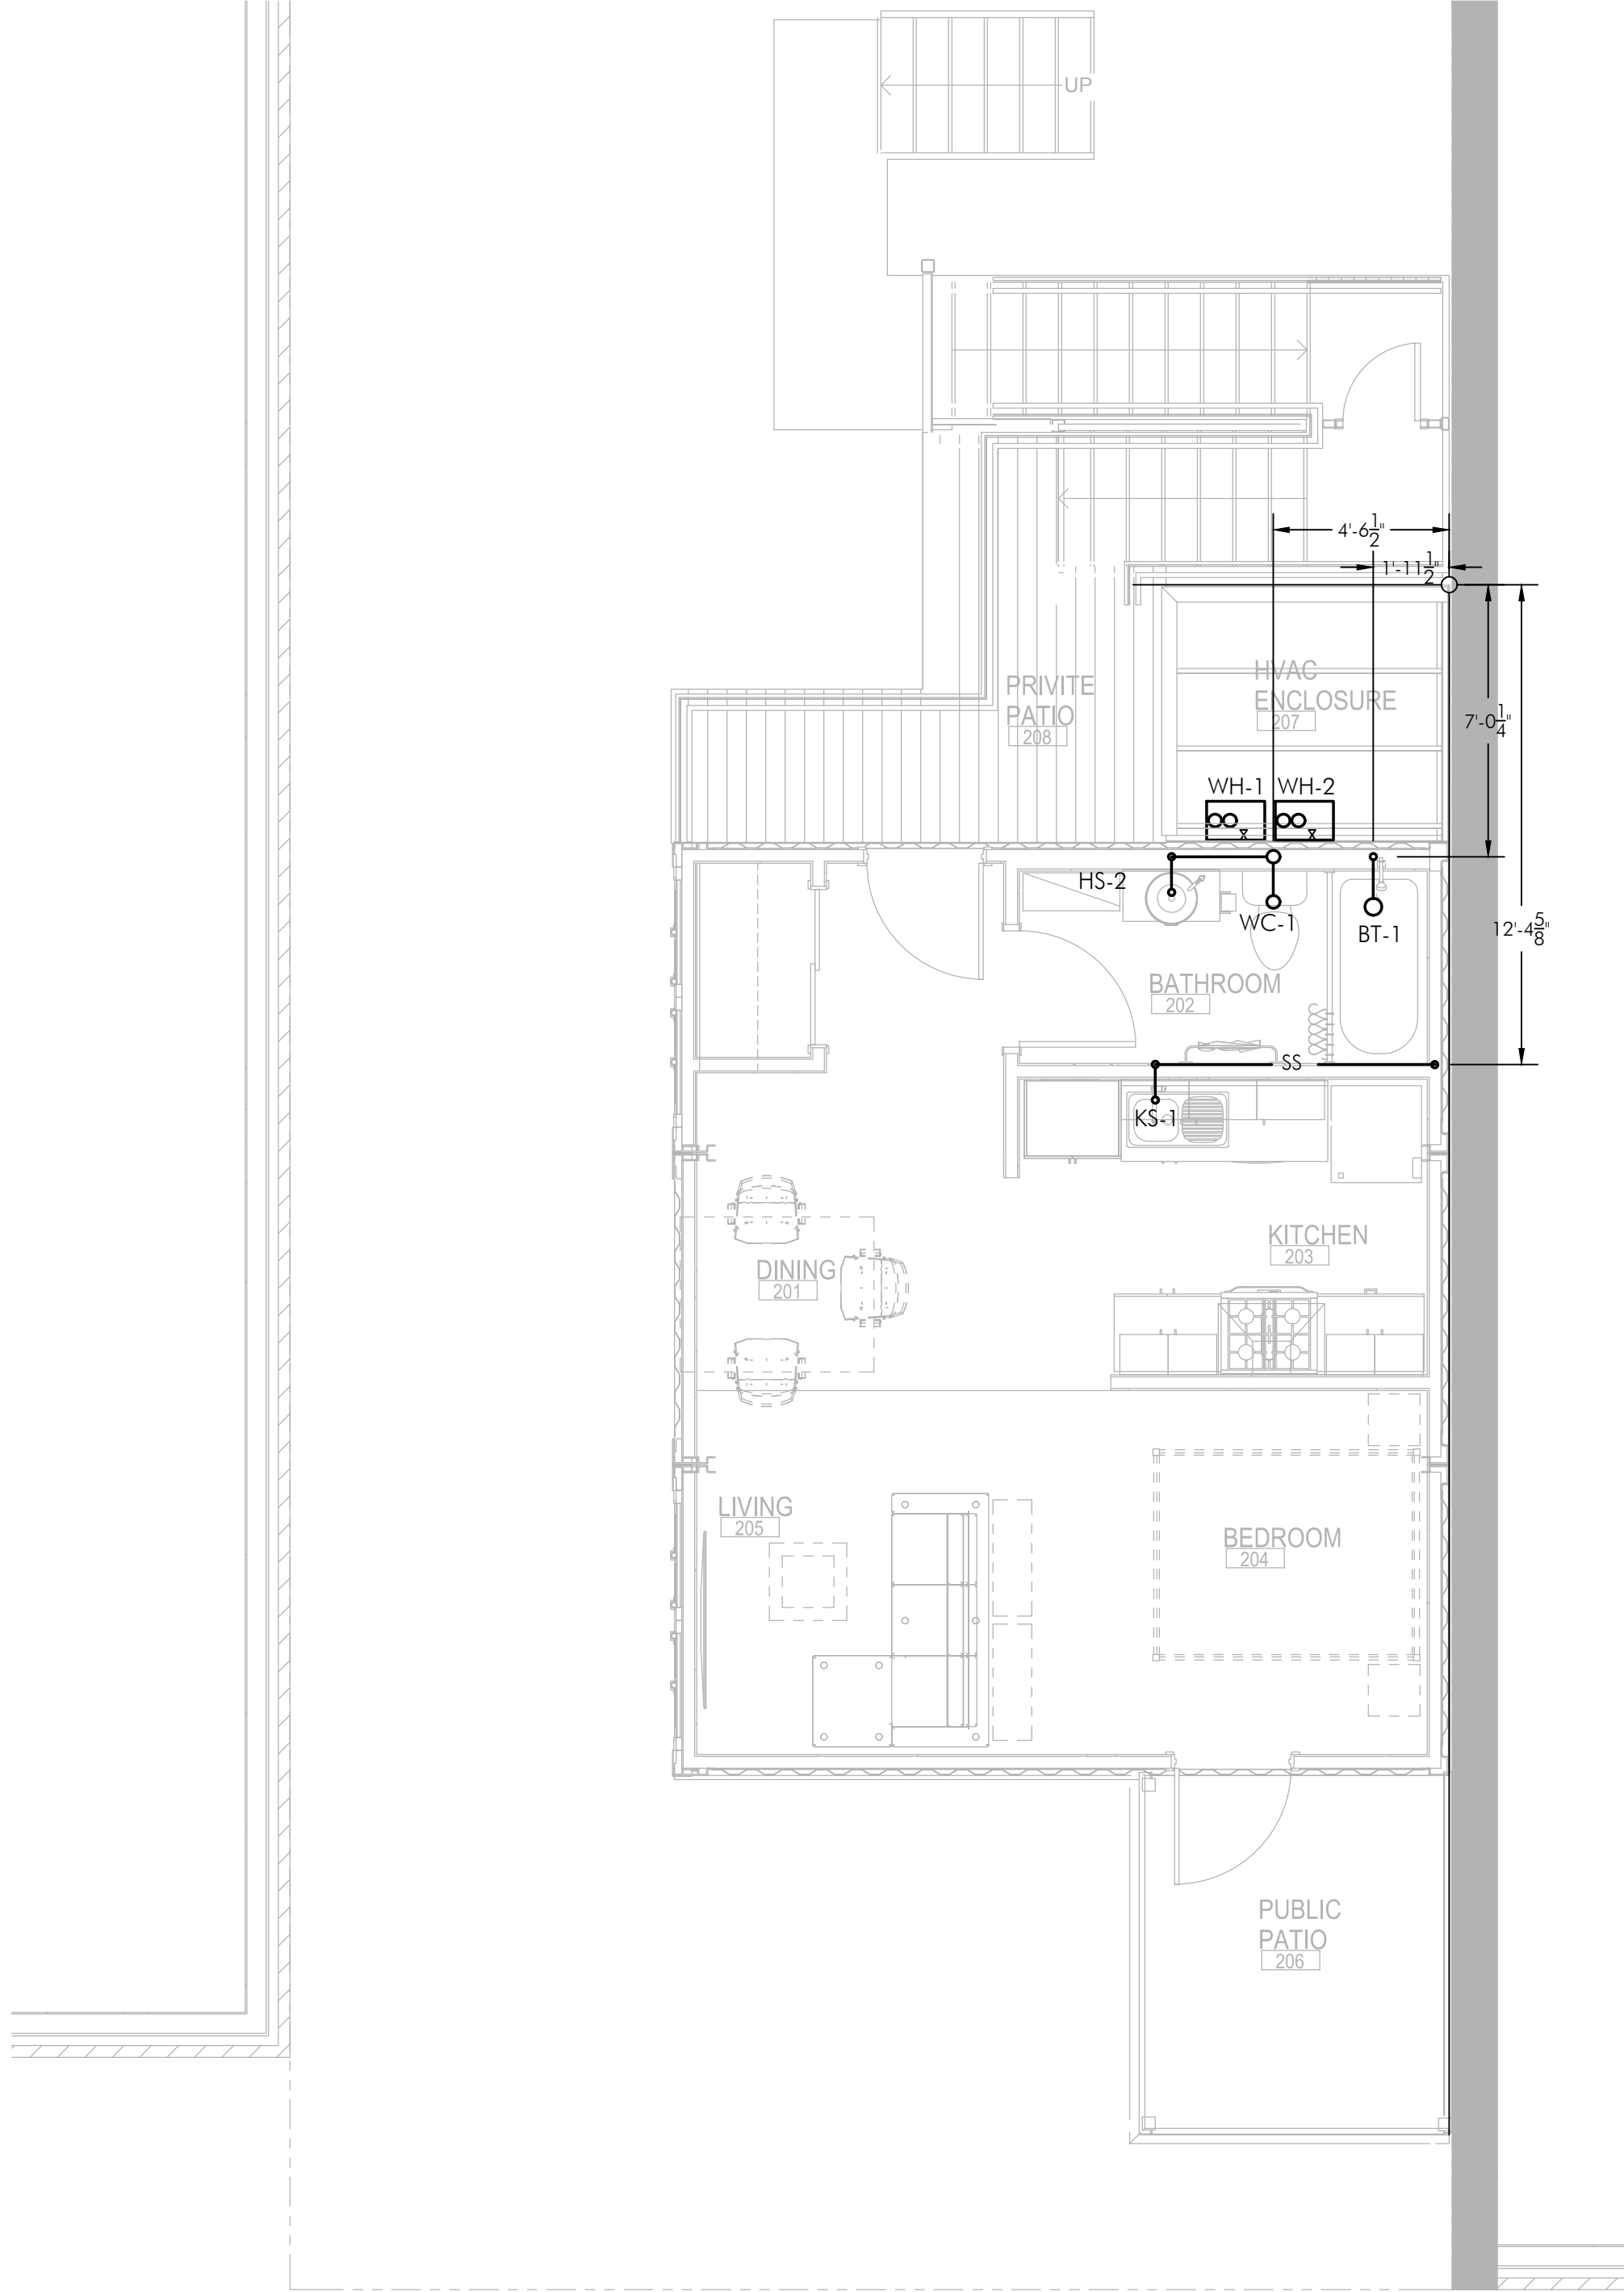
SHEET TITLE  
**PLUMBING  
PLANS - WASTE**

SHEET  
**P1.1**  
ORIGINAL SHEET SIZE  
24" x 36"






1 PLUMBING DIMENSION PLAN  
1ST FLOOR COFFEE  
P1.2 SCALE: 1/4"=1'-0"




2 PLUMBING DIMENSION PLAN  
2ND FLOOR APT.  
P1.2 SCALE: 1/4"=1'-0"

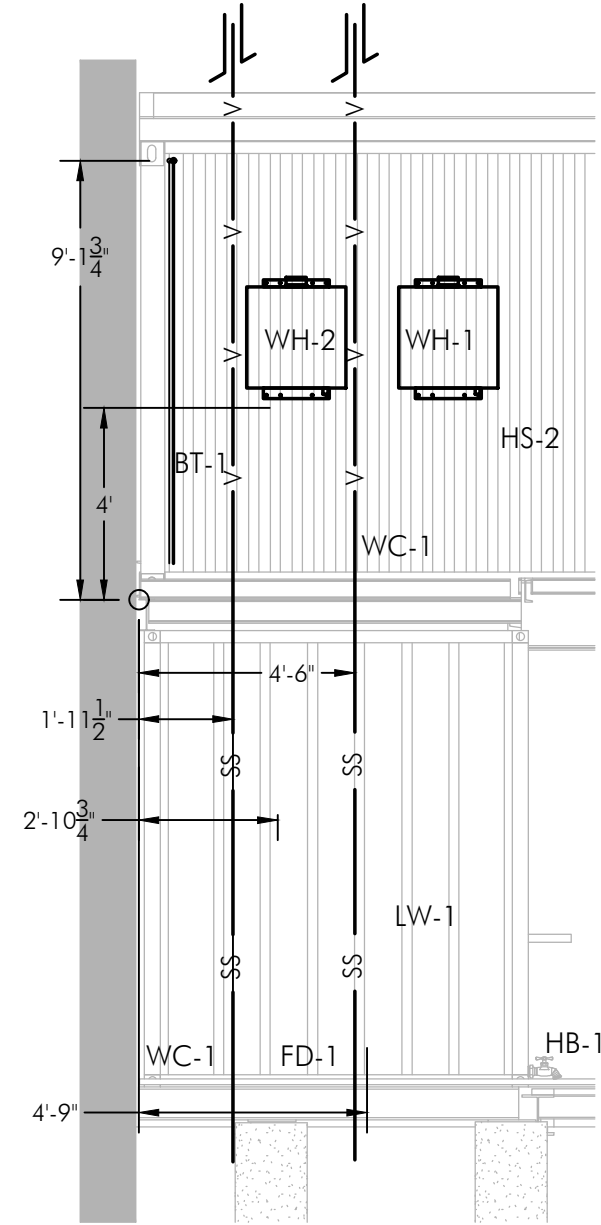

3 PLUMBING WALL  
P1.2 SCALE: 1/4"=1'-0"

- PLUMBING SHEET NOTES (#)
- NOTE: NOT ALL NOTES ARE USED ON THIS SHEET.
1. NEW 3/4" COLD WATER SUPPLY FROM UTILITY.
  2. PROVIDE NEW WATER ENTRY ASSEMBLY AND WATER METER WITH REMOTE READ-OUT BENEATH CONTAINERS. PROVIDE ACCESS TO BACKFLOW PREVENTER AND METERS FOR MAINTENANCE.
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  4. 1" CW & 3/4" HW DOWN IN WALL.
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  6. 3" VENT TO ROOF.
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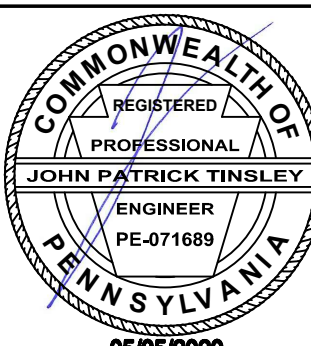
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PROJECT	KVA 19-121	DATE	02/10/2020
DRAWN	TMK	CHECKED	JPT

REVISED


SHEET TITLE

PLUMBING  
PLANS  
DIMENSIONS

SHEET

P1.2

ORIGINAL SHEET SIZE  
24" x 36"

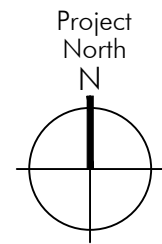



THE DRAWINGS INDICATE DIAGRAMMATICALLY THE EXTENT, GENERAL CHARACTER, AND LOCATION OF THE WORK INCLUDED. OFFSETS AND/OR CHANGES IN ELEVATION OF PIPING AND DUCTWORK DUE TO STRUCTURAL OR OTHER INTERFERENCES SHALL BE PROVIDED WITHOUT EXTRA COST.

PROVIDE ALL LABOR, MATERIALS AND EQUIPMENT NECESSARY FOR THE INSTALLATION OF A COMPLETE AND OPERATING SYSTEM. PROVIDE CONTROL WIRING NECESSARY FOR THE OPERATION OF THE MECHANICAL SYSTEMS INDICATED ON THE MECHANICAL DRAWINGS. THIS SHALL INCLUDE, BUT NOT BE LIMITED TO, THERMOSTATS.

WHERE REQUIRED BY CODE, ALL WORK MUST BE INSPECTED AND APPROVED BY LOCAL AUTHORITIES. PRIOR TO FINAL ACCEPTANCE, FURNISH THE ARCHITECT/OWNER WITH CERTIFICATES OF INSPECTION AND APPROVALS BY LOCAL AUTHORITIES.

BEFORE ACCEPTANCE AND FINAL PAYMENT, DEMONSTRATE THAT ALL APPARATUS ARE FUNCTIONING PROPERLY AND EFFICIENTLY. STARTUPS AND ADJUSTMENTS FOR THE FIRST HEATING AND THE FIRST COOLING SEASON SHALL BE INCLUDED IN THE BID.

TESTING, ADJUSTING, AND BALANCING SHALL BE PERFORMED IN ACCORDANCE WITH THE MOST CURRENT ASHRAE HANDBOOK OF HVAC APPLICATIONS, CHAPTER 36. THIS SHALL INCLUDE, BUT NOT BE LIMITED TO:

ADJUST AIR FLOWS FOR TERMINALS TO WITHIN +/- 10%. ADJUST AIR FLOWS IN DUCT MAINS TO WITHIN +/- 5%, USING THE PITOT-TUBE TRANSVERSE METHOD. FURNISH TO THE ARCHITECT, FIVE (5) COPIES OF THE TESTING AND BALANCING REPORT.

ALL EQUIPMENT SHALL BE INSTALLED IN STRICT COMPLIANCE WITH THE MANUFACTURER'S PUBLISHED INSTRUCTIONS AND SHALL PROVIDE EXTRA MATERIALS REQUIRED FOR A PROPER INSTALLATION.

ALL DUCT CONNECTIONS TO FAN DRIVEN UNITS SHALL BE MADE WITH 4-IN. LONG FIREPROOF FLEXIBLE DUCT CONNECTOR FOR VIBRATION SOUND ISOLATION.

THIS WORK SHALL BE PERFORMED IN A CLEAN AND PROFESSIONAL MANNER. CARE SHALL BE EXERCISED TO MINIMIZE INCONVENIENCE OR DISTURBANCE TO OTHER TRADES DURING CONSTRUCTION. ISOLATE WORK AREAS BY MEANS OF TEMPORARY PARTITIONS AND/OR TARPS TO KEEP DUST AND DEBRIS WITHIN THE CONSTRUCTION AREA. CLEAN THE JOB SITE DAILY AND REMOVE FROM THE PREMISES ANY DIRT AND DEBRIS CAUSED BY THE PERFORMANCE OF THE WORK INCLUDED IN THIS CONTRACT.

THIS CONTRACTOR SHALL BE RESPONSIBLE FOR THE SAFEKEEPING OF HIS/HER OWN PROPERTY ON THE JOB SITE. THE OWNER OR TENANT ASSUMES NO RESPONSIBILITY FOR PROTECTION OF THIS CONTRACTOR'S PROPERTY AGAINST FIRE, THEFT, OR ENVIRONMENTAL CONDITIONS.

WHERE CONDUIT, CABLES, DUCTWORK OR PIPING PASSES THROUGH FIRE RATED FLOORS, WALLS, OR PARTITIONS, THE SLEEVES SHALL BE COMPLETELY SEALED WITH A FIRE STOP MATERIAL THAT IS U.L. LISTED (EQUAL TO OR DOW CORNING) AND ACCEPTED BY THE BUILDING DEPARTMENT AND FIRE DEPARTMENT AS BEING SUITABLE FOR THE SERVICE. THIS MATERIAL SHALL BE INSTALLED IN ACCORDANCE WITH THE MANUFACTURER'S PUBLISHED INSTRUCTIONS IN ORDER TO MAINTAIN THE FIRE RATING OF THE PENETRATED WALL, FLOOR, OR PARTITION. INSTALLATION SHALL BE A THROUGH-PENETRATION FIRESTOP SYSTEM INSTALLED AS TESTED IN ACCORDANCE WITH ASTM E 814 AND UL 1479. THE FIRE RATING SHALL MATCH THE RATING OF THE BARRIER BEING PENETRATED.

SUBMIT (1) PDF FILE OR SIX (6) SETS OF SHOP DRAWINGS, CONTROL DIAGRAMS, AND EQUIPMENT CUTS TO THE MECHANICAL ENGINEER FOR APPROVAL PRIOR TO STARTING RELATED WORK. UPON COMPLETION OF CONSTRUCTION, SUPPLY THE MECHANICAL ENGINEER WITH ONE COMPLETE SET OF FULL SIZE AS-BUILT DRAWINGS AND ONE FULL SIZED PDF FILE. PROVIDE THE OWNER WITH (1) PDF AND THREE (3) SETS OF OPERATION AND MAINTENANCE MANUALS FOR EACH TYPE OF EQUIPMENT INSTALLED.

THIS CONTRACTOR SHALL SECURE AND PAY ALL FEES AND PERMITS PERTAINING TO THIS CONTRACT, SHALL BE RESPONSIBLE FOR WORKERS IDENTIFICATION AND BADGING, SAFETY, AND LIABILITY INSURANCE. PROVIDE BARRICADES, WARNING SIGNS, AND TRASH REMOVAL FOR THE SAFETY OF THE WORKERS UNDER THIS CONTRACTORS EMPLOY.

DUCT INSULATION:

EXTERIOR DUCTWORK SHALL BE INSULATED WITH A MINIMUM INSTALLED R-VALUE OF 8.

WHERE DUCTWORK IS NOTED TO BE INSULATED DIFFERENTLY ON THE DRAWINGS (i.e. EXTERNAL INSULATION ON RECTANGULAR DUCTWORK), THE CORRESPONDING INSULATION SPECIFICATIONS ABOVE SHALL APPLY.

GREASE EXHAUST DUCT SHALL BE CONSTRUCTED OF 16 GAGE WELDED BLACK IRON AND SHALL BE EXTERNALLY WRAPPED IN 2 LAYERS OF U.L. LISTED GREASE DUCT WRAP UP TOP ROOF PENETRATION. HORIZONTAL GREASE EXHAUST DUCT SHALL BE PROVIDED WITH RATED CLEANOUTS PER MECHANICAL CODE.

Room Name	Square Ft.	Min Operable Square Ft.	Supplied Square Ft.
Coffee Shop	228	9.12	42
1st Floor Restroom	44	1.76	21
Apartment	350	14	42
Apartment Bath	53	32.24	42

Description		Q	Q	Q	Q	CONVERSION DATA:	
					SL =	14.7 PSIA	
					5000F =	12.2 PSIA	
					1 PSI =	2.307 HWC	
					1 PSI =	27.684 "WC	
					1 "WC =	0.0361 PSI	
<p>ACTUAL METER Gas Pressure = 6"WC = 0.2167 PSI</p> <p>MAX Press Drop = 0.5"WC = 0.0181 PSI</p> <p>PRESSURE AT END OF LINE = 5.5"WC = 0.1987 PSI</p>							
<b>INPUTS:</b>							
Local Barometric Pressure = 12.20 PSIA				<b>Converted Pressures:</b>			
Initial Gas Pressure = P1 = 0.2167 PSI =				6.00 "WC Initial Pressure at GAS METER			
Pressure Drop MAX = P1 - P2 = 0.0181 PSI =				0.50 "WC MAX Pressure Drop			
Final Gas Pressure = P2 = 12.40 PSI =				5.50 "WC Final Pressure P2 at Appliance			
Specific Gravity = S = 0.60 SG				STP is 60oF and 14.7 psia or 101.325 kPa			
Factor for visc. density and temp = Cr = 0.6094				(use 1.2462 for propane)			
Viscosity of Gas= Z = 0.012				(use .008 for propane)			
Nominal Pipe Size "d"	ft length (L)	(D) Minimum D	(Q) MBH	Description of piping section			
1-1/2"	38	1.435	760	GAS METER TO POINT [A]			
1-1/4"	38	1.102	380	POINT [A] TO WH-1			
1-1/4"	38	1.102	380	POINT [A] TO WH-2			

MINI-SPLIT OUTDOOR UNIT													
Mark(s)	Manufacturer / Model No.	NOM. TONS	SEER	HEATING AT 17F	HEATING AT 47F	COOLING MAXIMUM CAPACITY	ELECTRICAL			SIZE			
							VOLTAGE & PHASE	MCA	MOCp	LENGTH (IN)	WIDTH (IN)	HEIGHT (IN)	WEIGHT (LBS)
ODU-1	Mitsubishi MXZ3C30NAHZ	2	18	18,000	28,600	28,400	208/1	29.9	40	37-13/32"	13"	41-9/32"	189
NOTES: <div>1. Provide 7-Day programmable thermostat.</div> <div>2. Route condensate drains to nearest approved receptacle.</div> <div>3. Outdoor condenser shall be placed on platform.</div>													





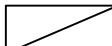









MINI-SPLIT INDOOR UNIT														
Mark(s)	Manufacturer / Model No.	COOLING CAPACITY (BTU/H)	HEATING CAPACITY (BTU/H)	REFRIGERANT PIPE		SUPPLY FAN CFM	ELECTRICAL			SIZE				NOTES
				LIQUID (INCHES)	GAS (INCHES)		VOLTAGE & PHASE	MCA	MOC ²	LENGTH (IN)	WIDTH (IN)	HEIGHT (IN)	WEIGHT (LBS)	
IDU-1	Mitsubishi MSZ-GL12NA	12,000	14,400	1/4"	3/8"	400	208/1	1	15	31-7/16"	9-1/8"	11-5/8"	22	1-4

NOTES:

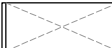1. Provided with a condensate pump. Drain to mop sink.
2. Provided with an external heat adapter.
3. Provided with a Relay Kit.
4. Provide with a PAR-CT01MAU-SB Touch MA Controller.
5. Field verify final refrigerant line lengths with the manufacturer prior to any work. NOTE 5 APPLIES TO ALL UNITS.

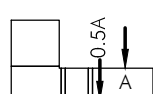ELECTRIC BASEBOARD HEATER									
Mark(s)	Manufacturer / Model No.	DESCRIPTION	ELECTRICAL			LENGTH FT.	WEIGHT LBS.	Control	REMARKS
			WATTS	VOLT & PHASE	AMPS				
EBB-1	Berko 2513W	Baseboard heater	750	120/1	6.25	3'	7.5	Integral T-Stat, set at 50°F	High limit safety, surface mount on wall
EBB-2	Berko 25126W	Baseboard heater	500	120/1	4.2	2' 6"	6.3	Integral T-Stat, set at 50°F	High limit safety, surface mount on wall

EXHAUST FAN SCHEDULE													
MARK(S)	MANUFACTURER/MODEL	LOCATION	SERVING	CFM	ESP in	MOTOR			Dampner Type	Fan Control	ROOF OPENING in x in	WEIGHT lbs.	NOTES lbs.
						Watts or HP	Voltage & Phase	RPM					
EF-1	Greenheck - SPA-110	Ceiling	Restroom	75	0.25	49	115/1	750	Backdraft	8	6'dia thru roof	17	1, 2, 4, 6
EF-2	Greenheck - SPA-110	Ceiling	Restroom	75	0.25	49	115/1	750	Backdraft	8	6'dia thru roof	17	1, 2, 4, 6
EF-3	Greenheck - SPA-110	Ceiling	Map Sink	75	0.25	49	115/1	750	Backdraft	8	6'dia thru roof	17	1, 2, 4, 6
NOTES:	1. Integral gravity backdraft damper 2. Ducted from fan outlet to roof 3. SMACNA approved roof cap 4. Ducted from fan outlet to wall 5. Wall exhaust louver, see plans for size 6. 1/4" galv. mesh birdscreen 7. 12" Manufacturer's roof curb 8. 18" Manufacturer's ventilated roof curb												
FAN CONTROL:	A. Separate wall switch B. Switch on wall lights C. 24/7 time clock to operate during occupied times D. Continuous operation E. Interlock with equipment (Marks shown)												

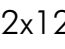H.V.A.C. A.C. LEGEND		H.V.A.C. A.C. LEGEND	
SYMBOL	DESCRIPTION	SYMBOL	DESCRIPTION
	SUPPLY DUCT UP		SIDE CONNECTION OF ROUND DUCT
	SUPPLY DUCT DN		TOP (OR BOTTOM) CONN OF ROUND DUCT
	RETURN OR EXHAUST DUCT UP		VOLUME DAMPER (TYP)
	RETURN OR EXHAUST DUCT DN		SIDE CONNECTION OF RECTANGULAR DUCT
(E)	EXISTING		FIRE DAMPER
	INSUL FLEX ROUND DUCT		INSIDE CLEAR INSULATION DIMENSION
	TRUNK DUCT ELBOW (TURNING VANES REQ'D)		EQUIPMENT MARK (SEE SCHEDULES)
			CONNECT NEW TO EXISTING



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**CONTAINER COFFEE SHOP**  
**79 SOUTH MAIN STREET**  
**PITTSBURGH, PA**

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05/05/2020

PROJECT KVA 19-121	DATE 02/10/2020
DRAWN TMK	CHECKED JPT

REVISED

SHEET TITLE


**MECHANICAL  
DETAILS, NOTES,  
& SCHEDULES**

SHEET


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ORIGINAL SHEET SIZE  
24" x 36"



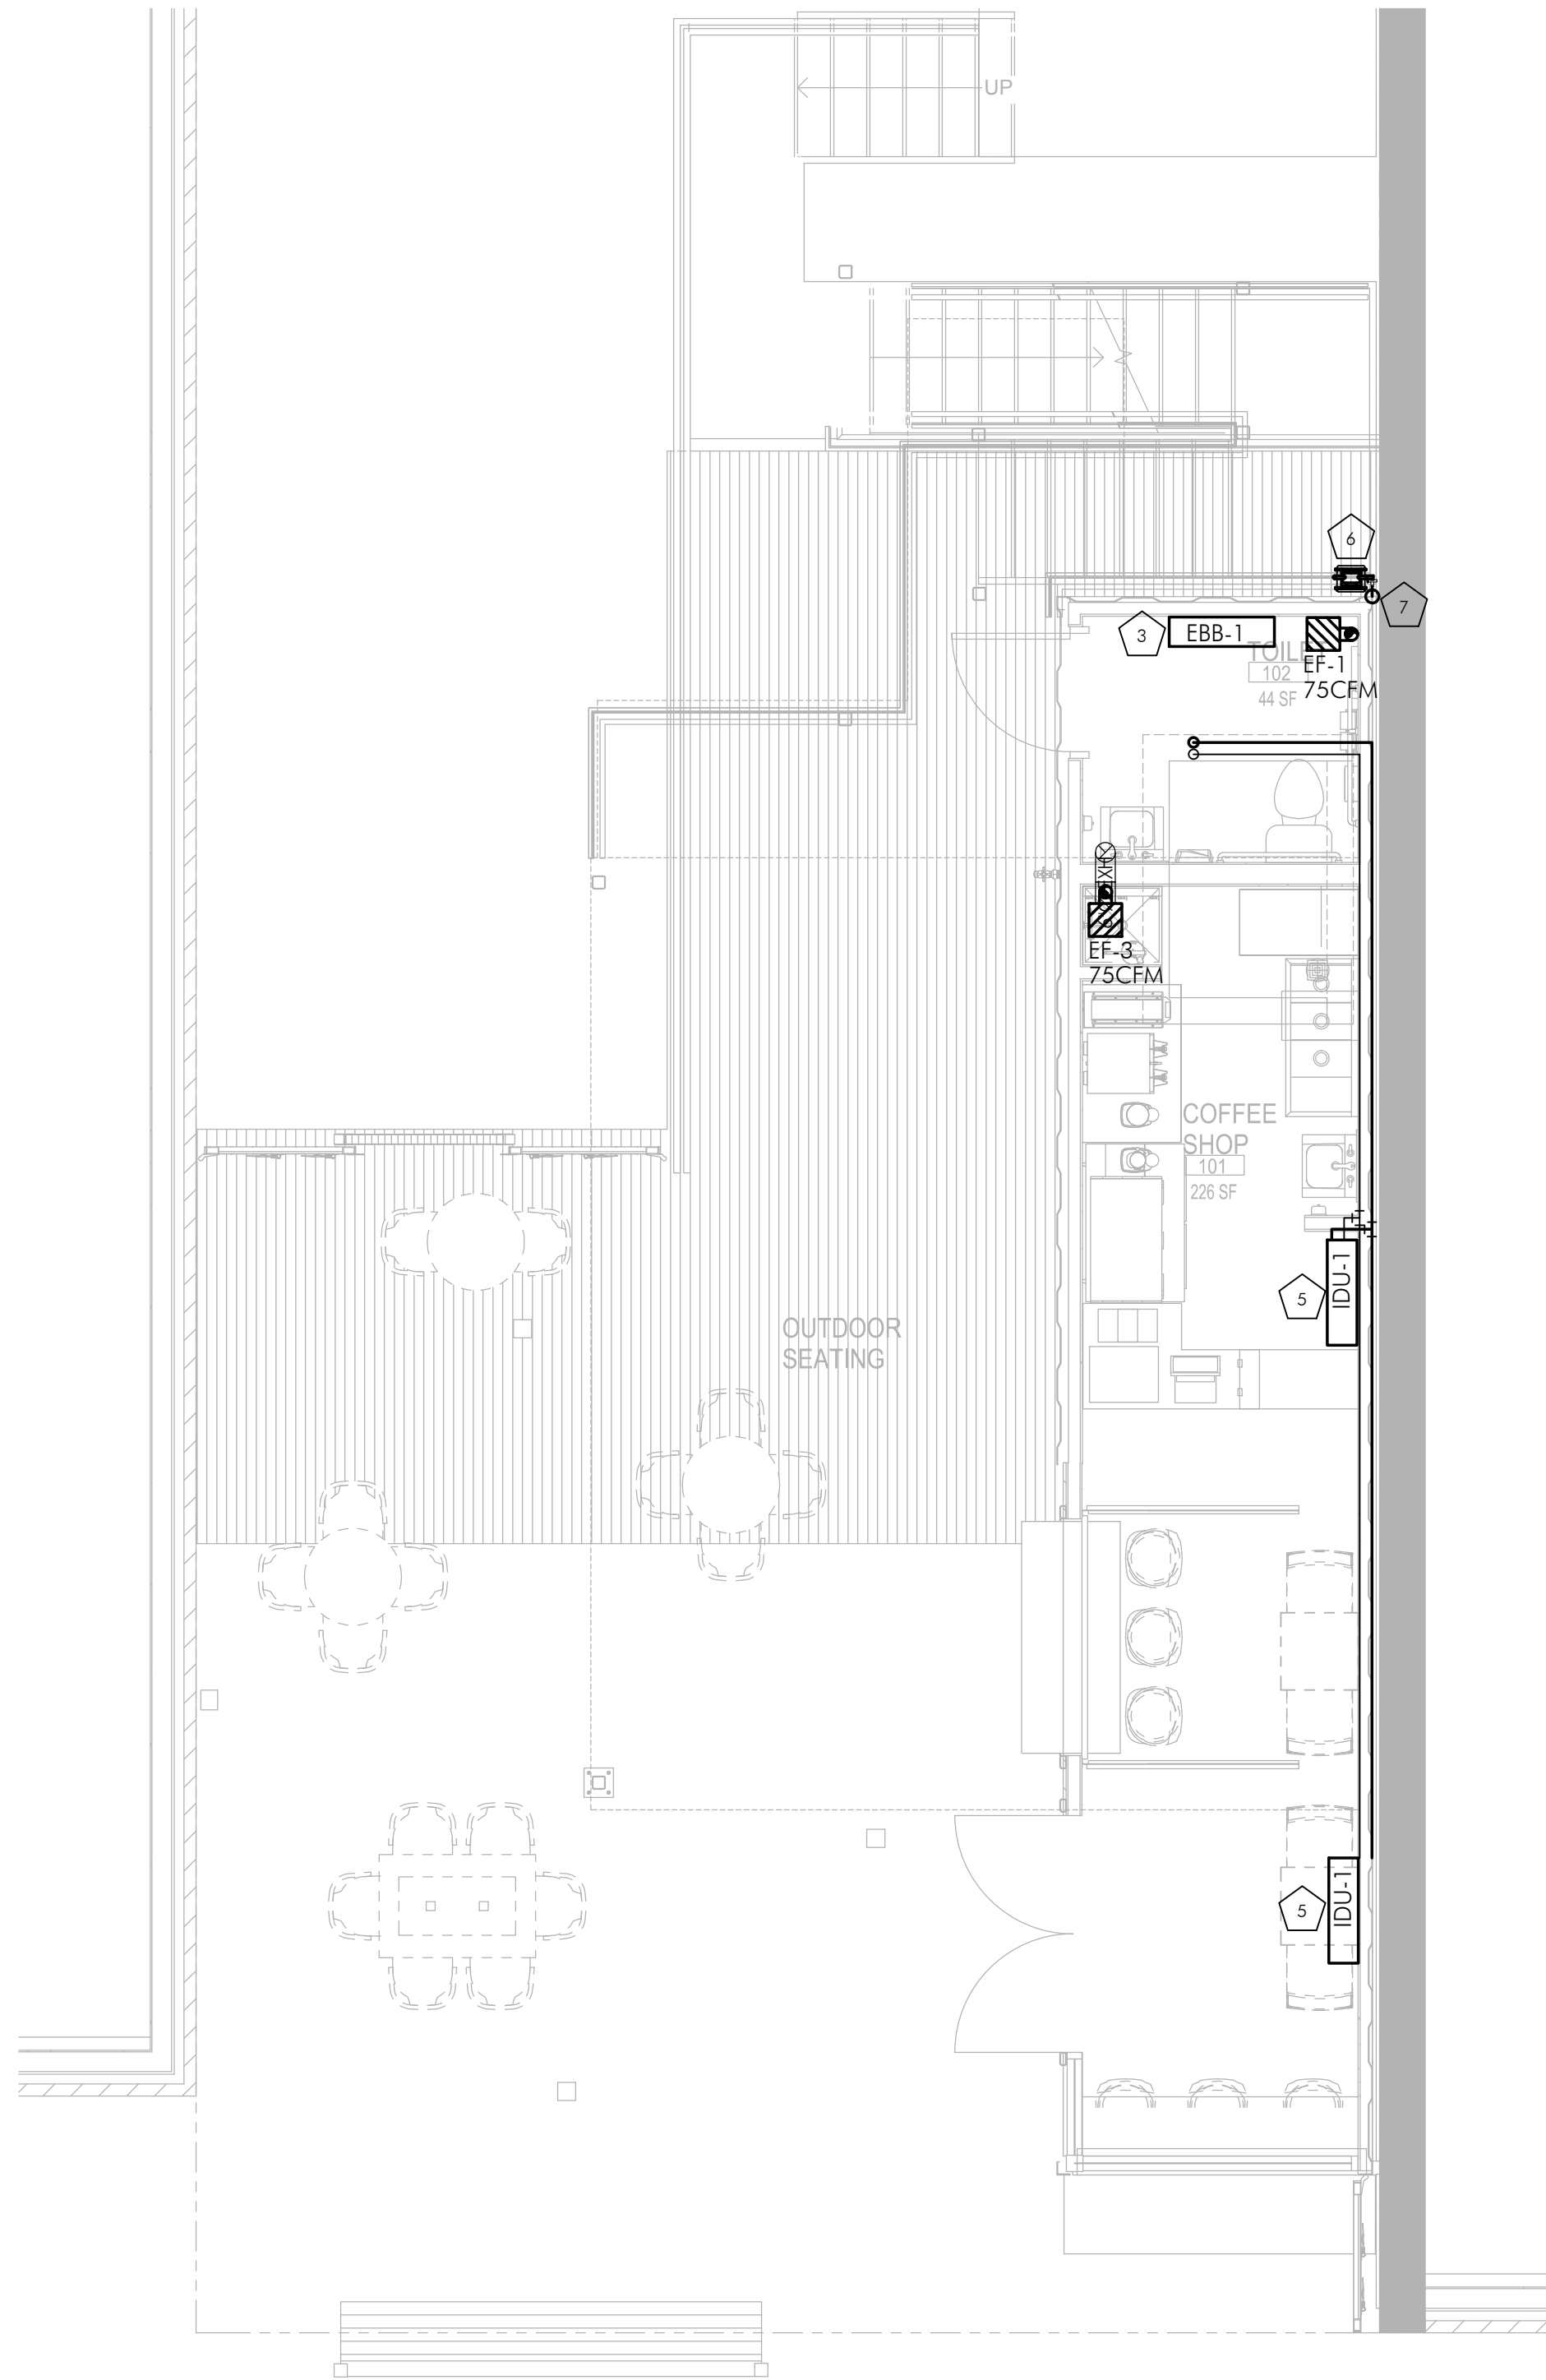

1 MECHANICAL PLAN - 1ST FLOOR COFFEE  
M1.0 SCALE: 1/4"=1'-0"

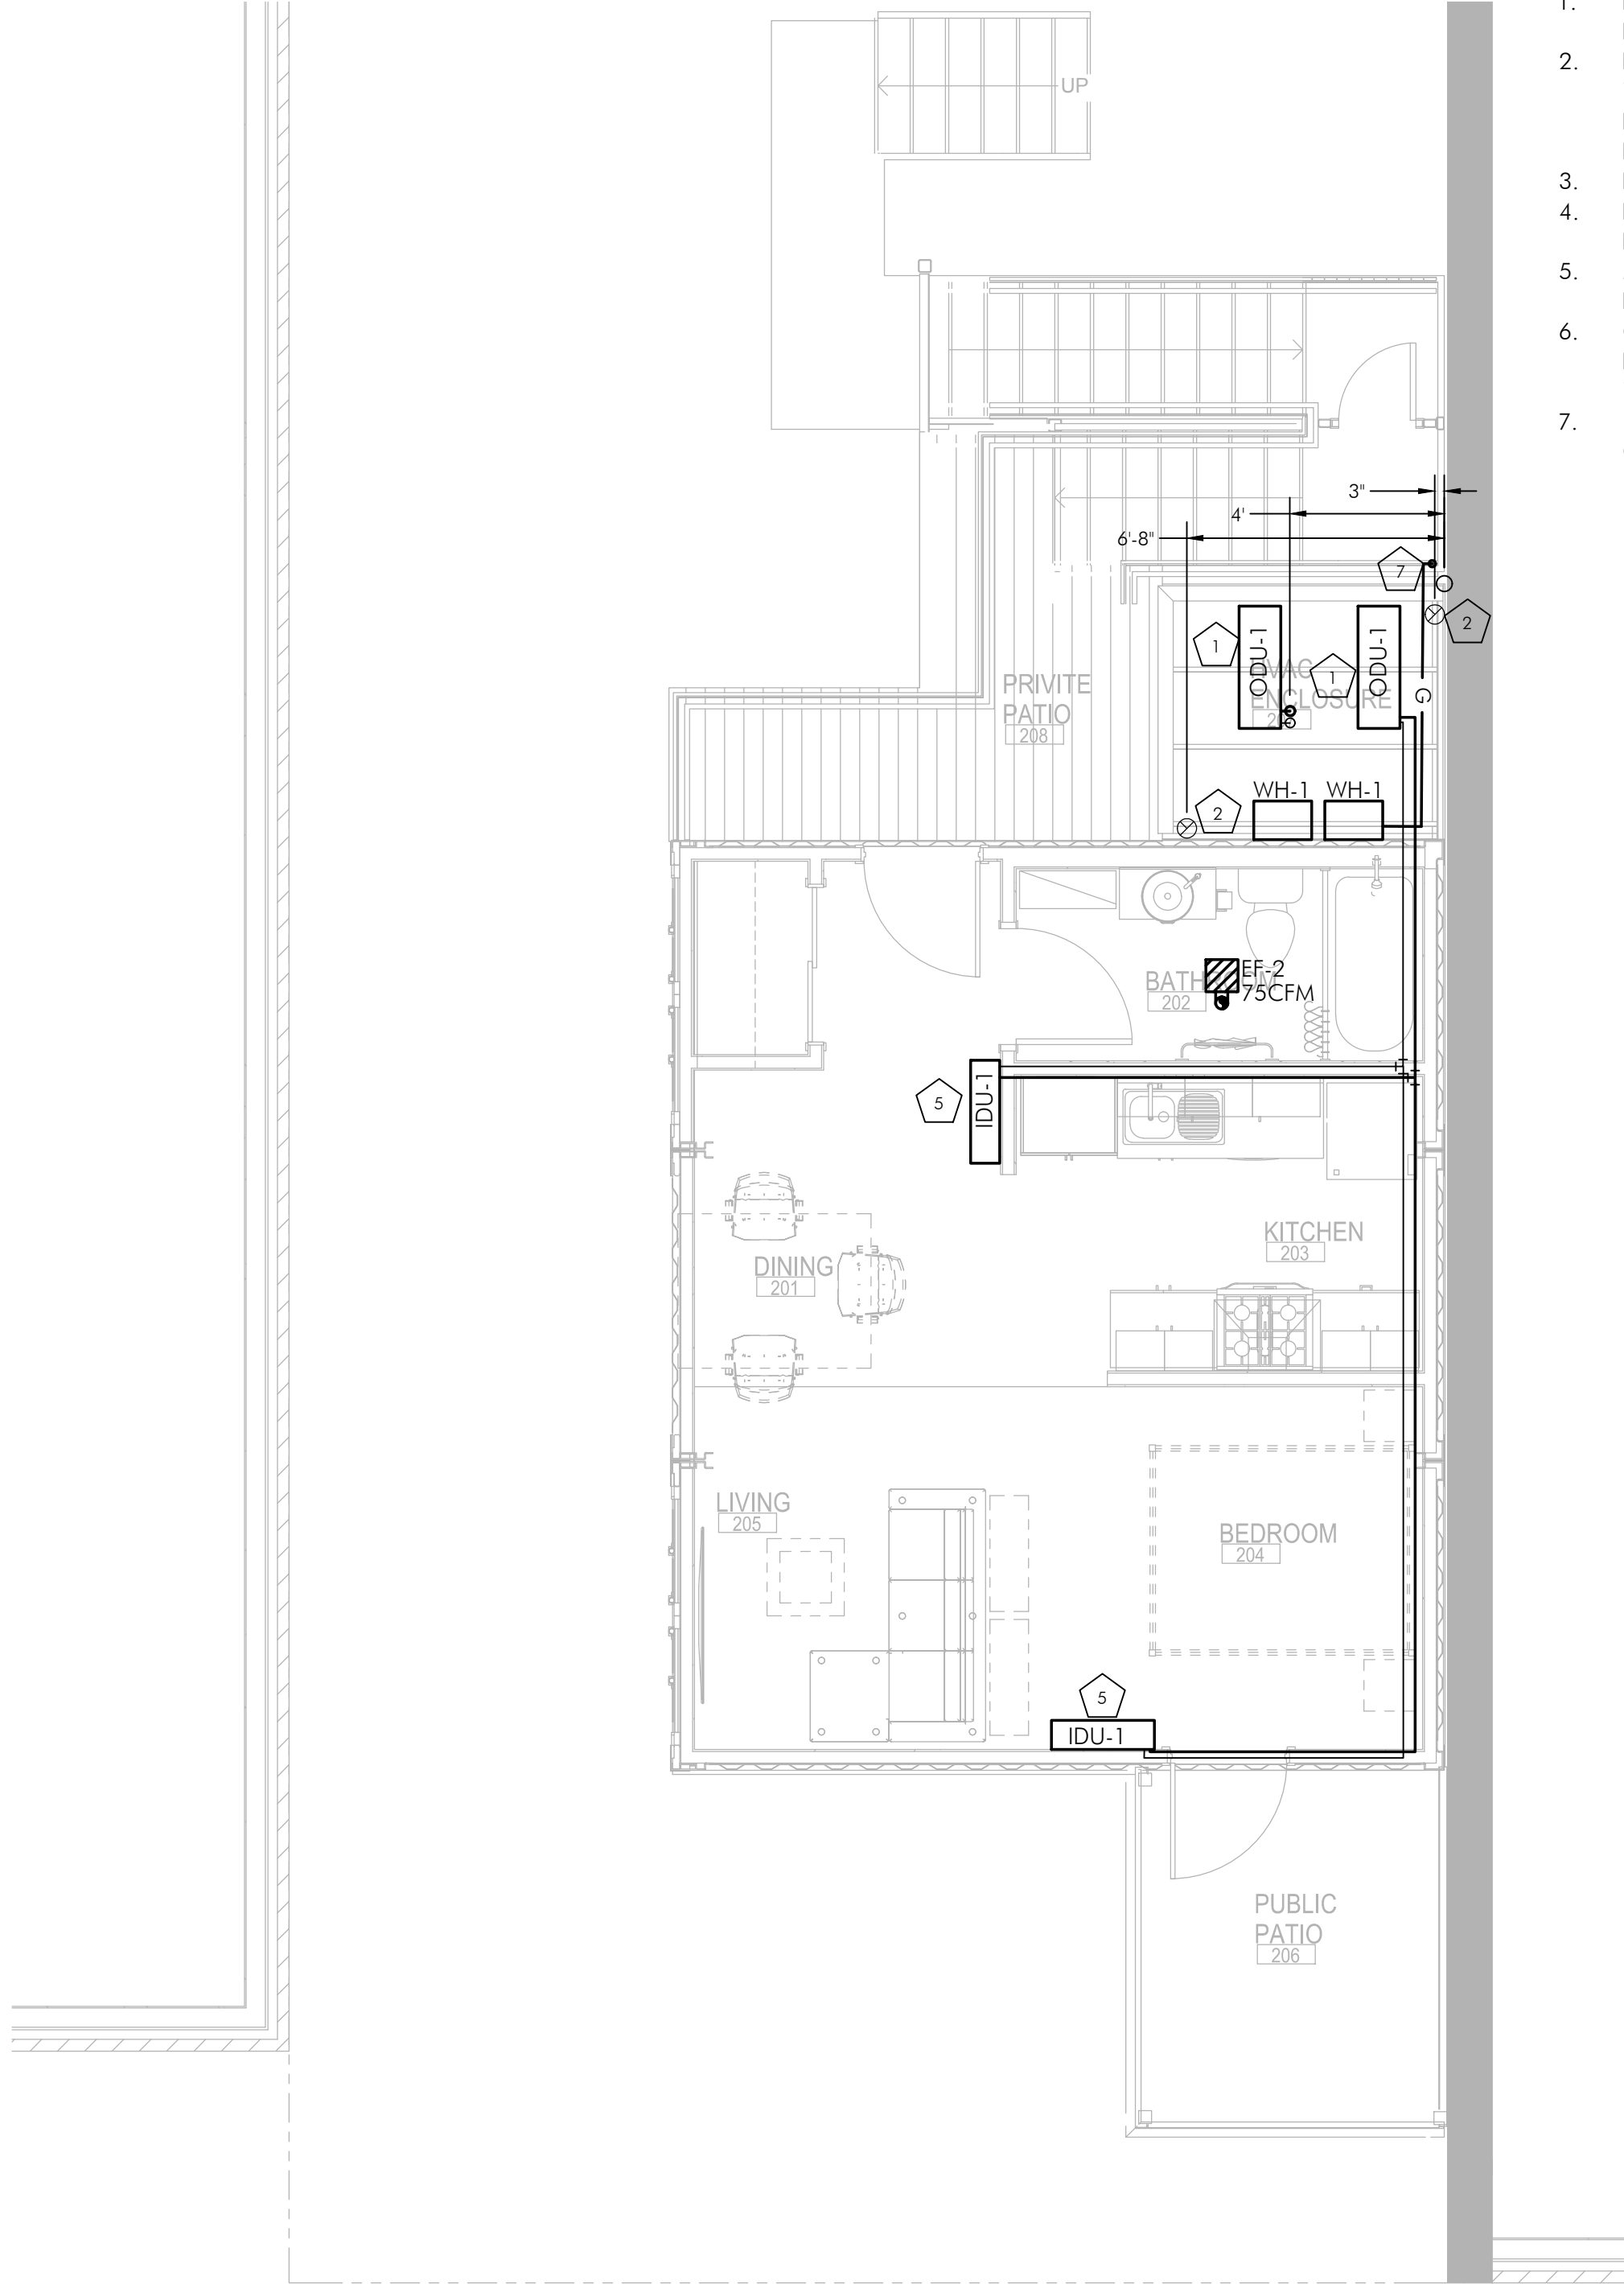

2 MECHANICAL PLAN - 2ND FLOOR APT.  
M1.0 SCALE: 1/4"=1'-0"

- MECHANICAL SHEET NOTES
1. NEW OUTDOOR CONDENSER UNIT. FIELD VERIFY FINAL LOCATION(S) AND RECOMMENDED MAINTENANCE CLEARANCES PRIOR TO ANY WORK.
  2. PROVIDE A 6" EXHAUST DUCT SERVING FIRST FLOOR RESTROOM. EXHAUST TERMINATIONS SHALL BE A MINIMUM DISTANCE OF 10'-0" ABOVE GRADE, AND 10'-0" HORIZONTALLY, OR 3'-0" VERTICALLY ABOVE, ANY FRESH AIR INTAKE. FIELD VERIFY FINAL LOCATION(S) PRIOR TO ANY WORK.
  3. PROVIDE ELECTRIC BASEBOARD IN RESTROOM.
  4. PROVIDE ELECTRIC BASEBOARD IN CRAWL SPACE FOR FREEZE PROTECTION OF WATER ENTRY ASSEMBLY.
  5. MOUNT INDOOR WALL-MOUNTED UNIT. MOUNT AS HIGH AS POSSIBLE. FIELD VERIFY FINAL LOCATIONS PRIOR TO ANY WORK.
  6. GAS METER LOCATION UNDER STAIRS IN AN UTILITY CO. AND AHJ APPROVED LOCATION. COORDINATE WITH CIVIL. FIELD VERIFY FINAL LOCATION PRIOR TO ANY WORK.
  7. 1-1/2" GAS PIPING TO RUN OUTSIDE AND MOUNTED TO THE EXTERIOR OF THE CONTAINER. FIELD VERIFY FINAL ROUTING PRIOR TO ANY WORK.




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SHEET TITLE  
**MECHANICAL  
PLANS**

SHEET  
**M1.0**  
ORIGINAL SHEET SIZE  
24" x 36"



## GENERAL PROJECT NOTES

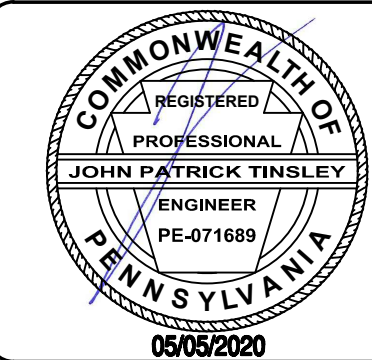NOTE: SEE ARCHITECTURAL DRAWINGS FOR ADDITIONAL CONSTRUCTION REQUIREMENTS

- THE CONTRACTOR SHALL PROVIDE ALL LABOR AND MATERIAL NECESSARY FOR A COMPLETE, OPERATIONAL AND PROPERLY FUNCTIONING ELECTRICAL SYSTEM
- MATERIALS AND INSTALLATION SHALL COMPLY WITH CODES, LAWS AND ORDINANCES OF FEDERAL, STATE AND LOCAL GOVERNING BODIES HAVING JURISDICTION.
- MATERIALS AND EQUIPMENT SHALL BE LISTED AND/OR LABELED BY U.L., ETL, CSA OR ANOTHER RECOGNIZED TESTING LAB. ALL MATERIAL, EQUIPMENT, WIRING DEVICES, ETC. SHALL BE NEW, UNLESS SPECIFICALLY INDICATED AS EXISTING TO BE REUSED.
- THE CONTRACTOR SHALL PREPARE AND SUBMIT TO GOVERNMENTAL AGENCIES AND UTILITY COMPANIES SHOP DRAWINGS REQUIRED BY THESE AGENCIES FOR APPROVAL. THE CONTRACTOR SHALL SECURE AND PAY FOR ALL PERMITS, GOVERNMENTAL FEES, TAXES AND LICENSES NECESSARY FOR THE PROPER EXECUTION AND COMPLETION OF THE ELECTRICAL WORK. THIS CONTRACTOR SHALL SECURE AND PAY ALL FEES AND PERMITS PERTAINING TO THIS CONTRACT, SHALL BE RESPONSIBLE FOR WORKERS IDENTIFICATION AND BADGING, SAFETY, AND LIABILITY INSURANCE. PROVIDE BARRICADES, WARNING SIGNS, AND TRASH REMOVAL FOR THE SAFETY OF THE WORKERS UNDER THIS CONTRACTORS EMPLOY.
- THE CONTRACTOR SHALL NOTIFY THE ARCHITECT/ENGINEER/OWNER OF ANY MATERIALS OR APPARATUS BELIEVED TO BE INADEQUATE, UNSUITABLE, IN VIOLATION OF LAWS, ORDINANCES, RULES OR REGULATIONS OF AUTHORITIES HAVING JURISDICTION.
- THE CONTRACTOR SHALL PREPARE THE DOCUMENTS, INCLUDING DRAWINGS, REQUIRED TO OBTAIN APPROVAL OF THE EQUIPMENT AND LOCATIONS OF THE DEVICES THAT COMPRISE THE BUILDING FIRE ALARM LIFE SAFETY SYSTEM. THE DRAWINGS AND CUT SHEETS SHALL BE PROVIDED TO A PROFESSIONAL ENGINEER FOR REVIEW AND APPROVAL. THE APPROVED DRAWINGS WILL BE STAMPED, SIGNED AND RETURNED TO E.C. TO SUBMIT TO THE BUILDING DEPARTMENT.
- THE CONTRACTOR SHALL CAREFULLY EXAMINE THE CONTRACT DOCUMENTS, VISIT THE SITE, AND THOROUGHLY BECOME FAMILIAR WITH THE BUILDING STANDARDS, LOCAL JURISDICTIONAL CODES AND REQUIREMENTS, AND LOCAL CONDITIONS RELATING TO THE WORK. FAILURE TO DO SO WILL NOT RELIEVE THE CONTRACTOR OF THE OBLIGATIONS OF THE CONTRACT. SUBMISSION OF PROPOSAL IN CONNECTION WITH THIS WORK SHALL IMPLY THAT THE BIDDER HAS EXAMINED THE JOB SITE. NO EXTRA CHARGE WILL BE ALLOWED FOR CHANGES AS A RESULT FROM FAILURE TO EXAMINE THE JOB SITE.
- THE CONTRACTOR SHALL PROVIDE TEMPORARY POWER AND WIRING FOR THE PERFORMANCE OF ALL TRADES, FOR THE ENTIRE PERIOD OF CONSTRUCTION AND SHALL REMOVE ALL TEMPORARY WIRING AT THE COMPLETION OF CONSTRUCTION.
- THE EXISTING POWER, SIGNAL AND COMMUNICATION SYSTEMS ARE TO REMAIN IN SERVICE TO PROVIDE FOR THE OWNER'S FUNCTION. SHOULD IT BECOME NECESSARY TO SHUT-DOWN ANY SYSTEM OR PORTION OF A SYSTEM, APPROVAL IN WRITING MUST BE OBTAINED FROM THE OWNER AND SHALL ONLY APPLY FOR THE PERIOD AND TIME AGREED UPON. THE BID IS TO INCLUDE THE COST OF ANY TEMPORARY WIRING AND PREMIUM TIME REQUIRED FOR THE SHUT-DOWN.
- ALL MATERIALS AND EQUIPMENT SHALL BE ERECTED, INSTALLED, CONNECTED, CLEANED, ADJUSTED, TESTED, CONDITIONED, AND PLACED IN SERVICE IN ACCORDANCE WITH THE MANUFACTURERS DIRECTIONS AND RECOMMENDATIONS.
- ALL CUTTING, DRILLING AND PATCHING OF MASONRY, STEEL OR IRON WORK BELONGING TO THE BUILDING MUST BE DONE BY THIS CONTRACTOR IN ORDER THAT HIS WORK MAY BE PROPERLY INSTALLED, BUT UNDER NO CONDITIONS MAY STRUCTURAL WORK BE CUT, EXCEPT AT THE DIRECTION OF THE ARCHITECT-DESIGNER OR THEIR REPRESENTATIVE.
- REFER TO ARCHITECTURAL DRAWINGS FOR EXACT LOCATIONS AND MOUNTING HEIGHTS OF ELECTRICAL FIXTURES AND ELECTRICAL DEVICES. MOUNTING HEIGHTS SHALL CONFORM TO ADA/ICC/ANSI STANDARDS.

- ALL WORK REQUIRED FOR THE INSTALLATION AS SHOWN ON DRAWINGS INCLUDING LABOR, EQUIPMENT AND MATERIALS SHALL BE IN STRICT COMPLIANCE WITH THE BUILDING STANDARDS.
- PROVIDE COMPLETE METAL RACEWAY SYSTEMS AND ENCLOSURES FOR ALL WIRING THROUGHOUT THE EXTENT OF THE REQUIRED SYSTEM.
- ALL TELE/ DATA BOXES SHALL BE PROVIDED WITH A 1/2" CONDUIT AND BUSHING WITH PULL STRING RUN 6" ABOVE FINISHED CEILING OR CEILING GRID. ELECTRICAL METALLIC TUBING (EMT) SHALL BE USED FOR ALL WALL OUTLETS & TELEPHONE WIRING RUNNING BELOW RAISED FLOOR OR ABOVE HARD CEILINGS.
- ALL RECEPTACLES NOTED AS ISOLATED GROUND (IG) OR DEDICATED OR CIRCUITED AS DEDICATED SHALL BE PROVIDED WITH A DEDICATED GROUND AND NEUTRAL. ALL RECEPTACLES IN BATHROOMS, KITCHENS, ROOFTOPS, OUTDOORS, AND WITHIN 6FT. OF A SINK SHALL BE GFCI (OR SERVED BY A GFI CIRCUIT BREAKER) PER NEC 210.8(B). THE E.C. SHALL PROVIDE GFCI OUTLETS (OR CIRCUIT BREAKERS) IN ALL LOCATIONS REQUIRED BY THE NEC. ALL RECEPTACLES IN DWELLING UNITS, GUEST ROOMS, AND CHILD CARE FACILITIES (AS SPECIFIED BY ARTICLE 406 OF THE 2017 NEC) SHALL BE LISTED AS TAMPER-RESISTANT RECEPTACLES.
- MINIMUM CONDUIT SIZE SHALL BE 3/4" UNLESS OTHERWISE INDICATED. CONDUITS LARGER THAN 2" DIAMETER OR CONDUITS OF ANY SIZE ROUTED OUTDOORS SHALL BE INTERMEDIATE METAL CONDUIT (IMC).
- FLEXIBLE CONDUIT CONNECTIONS TO RECESSED LIGHTING FIXTURES SHALL BE MADE WITH FLEXIBLE STEEL CONDUIT, 3/8 INCH MINIMUM.
- FINAL CONNECTIONS TO MOTORS SHALL BE MADE WITH LIQUID TIGHT FLEXIBLE STEEL CONDUIT, 1/2 INCH MINIMUM.
- WIRE NO. 8 AND SMALLER INSTALLED IN DRY LOCATIONS SHALL BE TYPE THWN OR THHN THERMOPLASTIC 600V INSULATED COPPER CONDUCTORS. NO WIRE SMALLER THAN NO. 12 SHALL BE USED FOR LIGHTING OR POWER WIRING. WIRE NO. 8 AND LARGER SHALL BE STRANDED. ALL CONDUCTORS INSTALLED IN EXTERIOR OR WET LOCATIONS SHALL BE TYPE THWN 600V INSULATED COPPER CONDUCTORS.
- ALL NEW CIRCUIT BREAKERS FOR NEW OR EXISTING PANELBOARDS SHALL MATCH EXISTING OR NEW BUILDING STANDARD PANELBOARD MANUFACTURER AND BREAKER TYPE. THE CONTRACTOR SHALL PROVIDE NEW ACCURATE AND DETAILED TYPE WRITTEN PANEL DIRECTORIES PER NEC 408.4 FOR ALL NEW OR MODIFIED PANELS. NUMBERED CIRCUITS ARE FOR CONVENIENCE OF DESIGN ONLY. E.C. TO FIELD VERIFY ACTUAL CIRCUIT NUMBERS USED AND CORRECTLY INDICATE ON 'AS-BUILT' DRAWINGS. THE E.C. SHALL REMOVE ALL ABANDONED CIRCUITS.
- PROVIDE #10 FOR BRANCH CIRCUITS OVER 75 AT 120V AND OVER 150 AT 277V. E.C. TO FIELD VERIFY BRANCH CIRCUIT LENGTHS AND SIZE CONDUCTORS FOR VOLTAGE DROP.
- EACH SWITCH, LIGHT, RECEPTACLE AND ALL OTHER DEVICES SHALL BE PROVIDED AND INSTALLED WITH A GALVANIZED OR SHERARDIZED PRESSED STEEL JUNCTION BOX OF NOT LESS THAN NO. 14 U.S. GAUGE. STEEL CONDUITS SHALL BE FASTENED WITH LOCKWITS AND BUSHINGS AND ALL UNUSED KNOCKOUTS MUST BE LEFT SEALED. THERE MUST BE SUFFICIENT ROOM FOR WIRES AND BUSHINGS AND DEEP BOXES SHALL BE INSTALLED WHERE REQUIRED. BOXES SHALL BE SECURELY AND ADEQUATELY SUPPORTED.
- ELECTRICAL CONTRACTOR SHALL PROVIDE ALL SPECIAL OUTLET BOXES THAT MAY BE REQUIRED TO ENCLOSE RECEPTACES.
- IN SUSPENDED CEILINGS SUPPORT CONDUIT AND JUNCTION BOXES DIRECT FROM THE STRUCTURAL SLAB, DECK, OR FRAMING PROVIDED FOR THAT PURPOSE. LIGHTING BRANCH CIRCUIT CONDUITS SHALL NOT BE CLIPPED TO THE CEILING SUPPORT WIRES OR SPLINE UNLESS THE CEILING SYSTEM HAS BEEN SPECIFICALLY DESIGNED FOR THAT PURPOSE.
- PROVIDE LOCAL DISCONNECT SWITCHES FOR ALL MOTORS (PLENUM APPROVED WHERE REQUIRED). THE E.C. SHALL INCLUDE IN HIS COST THE REMOVAL OF ALL EXISTING ELECTRICAL DEVICES, CONDUITS, FIXTURES AND EQUIPMENT THAT IS NOT TO BE REUSED. DISCARD ALL EQUIPMENT AS REQUIRED. E.C. SHALL BE RESPONSIBLE FOR DISCONNECTING PRIMARY SERVICE AND TEMPORARY POWER.
- PROVIDE WARRANTY GUARANTEED FOR A PERIOD OF ONE YEAR AFTER COMPLETION AND ACCEPTANCE. REPLACE ALL DEFECTIVE WORKMANSHIP, EQUIPMENT AND MATERIALS WITHOUT ADDITIONAL CHARGES.
- THIS CONTRACTOR SHALL BE RESPONSIBLE FOR THE SAFEKEEPING OF HIS/HER OWN PROPERTY ON THE JOB SITE. THE OWNER OR TENANT ASSUMES NO RESPONSIBILITY FOR PROTECTION OF THIS CONTRACTORS PROPERTY AGAINST FIRE, THEFT, OR ENVIRONMENTAL CONDITIONS.
- WHERE CONDUIT, CABLES, DUCTWORK OR PIPING PASSES THROUGH FIRE RATED FLOORS, WALLS, OR PARTITIONS, THE SLEEVES SHALL BE COMPLETELY SEALED WITH A FIRE STOP MATERIAL THAT IS U.L. LISTED (EQUAL TO DOW CORNING) AND ACCEPTED BY THE BUILDING DEPARTMENT AND FIRE DEPARTMENT AS BEING SUITABLE FOR THE SERVICE. THIS MATERIAL SHALL BE INSTALLED IN ACCORDANCE WITH THE MANUFACTURERS PUBLISHED INSTRUCTIONS IN ORDER TO MAINTAIN THE FIRE RATING OF THE PENETRATED WALL, FLOOR, OR PARTITION. INSTALLATION SHALL BE A THROUGH-PENETRATION FIRESTOP SYSTEM INSTALLED AS TESTED IN ACCORDANCE WITH ASTM AND UL. THE FIRE RATING SHALL MATCH THE RATING OF THE BARRIER BEING PENETRATED.
- SUBMIT SIX (6) SETS OF SHOP DRAWINGS, CONTROL DIAGRAMS, AND EQUIPMENT CUTS TO THE ENGINEER FOR APPROVAL PRIOR TO STARTING RELATED WORK. SHOP DRAWINGS SHALL INCLUDE MANUFACTURERS NAMES, CATALOG NUMBERS, CUTS, DIAGRAMS AND OTHER SUCH DESCRIPTIVE DATA AS MAY BE REQUIRED TO IDENTIFY AND REVIEW THE EQUIPMENT. SUBMITTALS SHALL BE IN LOGICAL GROUPS, PARTIAL SUBMITTALS WILL NOT BE REVIEWED.
- UPON COMPLETION OF CONSTRUCTION, SUPPLY THE ENGINEER WITH ONE COMPLETE SET OF FULL SIZE AS-BUILT DRAWINGS. PROVIDE THE OWNER WITH THREE (3) SETS OF COPY OF OPERATION AND MAINTENANCE MANUALS FOR EACH TYPE OF EQUIPMENT INSTALLED.
- THIS CONTRACTOR SHALL ASSUME ALL ADDED EXPENSES TO ALL TRADES ASSOCIATED WITH THE INSTALLATION OF SUBMITTED AND APPROVED ALTERNATE EQUIPMENT.
- THE CONTRACTOR SHALL COORDINATE THE LAYOUT OF THE FIRE ROOM WITH ALL OTHER DISCIPLINES, ESPECIALLY THE FIRE ALARM AND FIRE PROTECTION DESIGN-BUILD CONTRACTORS PRIOR TO ANY WORK.
- IF ANY CHANGES ARE MADE TO ACCOMMODATE FIELD CONDITIONS NOTIFY THE ENGINEER IMMEDIATELY OF WHAT THE CHANGES WERE, THE REASON FOR THE CHANGES, AND THE COST IMPACTS.

### ELECTRICAL LEGEND

NOTE: NOT ALL ITEMS APPEAR ON DRAWINGS. SYMBOLS MAY DIFFER FROM EXISTING AND DEMO WORK OR DEVICES REFERENCED FROM DRAWINGS BY OTHERS.

POWER AND LIGHTING	LOW VOLTAGE SYSTEMS	
GROUNDING SWITCHED DUPLEX RECEPTACLE	TELEPHONE TERMINAL BOARD	
GROUNDING SPLIT-WIRED RECEPTACLE	FLOOR/CEILING MOUNTED DATA OUTLET	
GROUNDING DUPLEX RECEPTACLE	FLOOR/CEILING MOUNTED TELEPHONE OUTLET	
GROUNDING QUADRAPLEX RECEPTACLE	DATA OUTLET	
SPECIAL PURPOSE RECEPTACLE	TELEPHONE/DATA OUTLET, PROJECT STANDARD	
FLOOR/CEILING MOUNTED RECEPTACLE	TELEPHONE OUTLET	
JUNCTION BOX	CATV/MONITOR AV OUTLET	
WALL MOUNTED JUNCTION BOX	SPEAKER	
EQUIPMENT DISCONNECT SWITCH	FIRE ALARM PANEL	
EQUIPMENT FUSED DISCONNECT SWITCH	FIRE ALARM REMOTE ANNUNCIATOR PANEL	
THERMAL OVERLOAD SWITCH	S-SMOKE, T-HEAT DETECTOR	
ELECTRICAL PANEL BOARD	DUCT FIRE DETECTOR	
TRANSFORMER	ABBREVIATIONS	
CIRCUIT # (ARROW TO PANEL Y ARROWS NOT USED IF CIRCUIT NUMBERS APPEND NEXT TO DEVICES)	EWC	ELECTRIC WATER COOLER
	EF	EXHAUST FAN
	GFI	GROUND FAULT INTERRUPTING
	AF	ARC FAULT INTERRUPTING
	C	CIRCUIT
	C.T.T.	ELECTRICAL CONTRACTOR
	AC	ABOVE COUNTER - VERIFY HEIGHT
	AC	ABOVE COUNTER - VERIFY HEIGHT
	VP	WEATHER PROOF
	TFR	TELEPHONE TERMINAL BOARD
	AFF	ABOVE FINISH FLOOR
	AHJ	AUTHORITY HAVING JURISDICTION
	(R)	EXISTING TO REMAIN
	(EX)	EXISTING TO BE REMOVED
	(RE)	EXISTING TO BE RELOCATED
	(RL)	RELOCATE/RELOCATED LOCATION
	REFERENCE SYMBOLS	
KEYED NOTE	EQUIPMENT - SEE SCHEDULE	
FEEDER - SEE SCHEDULE	TRANSFORMER WITH GROUNDING AND OVERCURRENT DEVICES SEE TRANSFORMER SCHEDULE	

PANEL SCHEDULE: B															May 4, 2020	
PROJECT: Pitson Container Residence					VOLTAGE L-L: 208					Circuit Font Key: Normal: New Load/Breaker						
LOCATION: Exterior wall					VOLTAGE L-G: 120					Bolt: New Load/Exist Brkr Italic:Exist Load/Brkr						
JOB NO.: 19-121					SYSTEM: 3Ø, 4-WIRE											
COMMENTS: New Nema 3R Panel																
BUS RATING: 100A					S.C.RMS RATING: 10,000 AIC											
MAIN O.C. DEVICE: 100A MLO																
MOUNTING: Surface, Exterior																
CR NO.	CIRCUIT NO.	BREAKER	POLE	CONNECTED LOAD (VA)	NEC DEMAND FACTOR	DESCRIPTION OF LOAD SERVED	PHASE	DESCRIPTION OF LOAD SERVED	NEC DEMAND FACTOR	CONNECTED LOAD (VA)	CIRCUIT POLE	BREAKER AMPS	CR NO.			
1	40	2		3000	1.00	Electric Stove	A	Residence Restroom & E-2	1.50	290	1	20	2			
3	40	2		3000	1.00	Electric Stove	B	Residence Kitchen Counter	1.00	900	1	20	4			
5	20	1				Spare	C	Residence Refrigerator	1.00	1200	1	20	6			
7	20	1				Spare	A	Residence Garbage Disposal	1.00	1200	1	20	8			
9	20	1				Spare	B	Residence Living Room Rec	1.00	1040	1	20	10			
11	20	1				Spare	C	Residence Bedroom Rec	1.00	720	1	20	12			
13	40	2		3588	1.00	ODU-1	A	Residence Exterior Rec	1.00	360	1	20	14			
15	40	2		3588	1.00	ODU-1	B	Residence Lighting	1.00	718	1	20	16			
17	15	2		120	1.00	IDU-1	C	Residence Hood	1.00	180	1	20	18			
19	15	2		120	1.00	IDU-1	A	Spare			1	20	20			
21	15	2		120	1.00	IDU-1	B	Spare			1	20	22			
23	15	2		120	1.00	IDU-1	C	Spare			1	20	24			
CONNECTED LOAD:					DEMAND LOAD:											
PHASE A (VA): 8,558					PHASE A (VA): 8,703											
PHASE B (VA): 9,366					PHASE B (VA): 9,366											
PHASE C (VA): 2,340					PHASE C (VA): 2,340											
TOTAL LOAD (VA): 20,264					TOTAL DEMAND LOAD (VA): 20,409					56.65 A						
NOTES:																
1. Field verify final location prior to any work. Coordinate with Container Provider.																

### FAULT CURRENT CALCULATION TABLE

March 26, 2020									
LOCATION (a)	# of RUNS	CONDUCTOR	VOLTAGE	L _{eff}	C	I	M	F	
300	Utility Transformer		208						52,000
200A Main	1	3/0	208	130	13,923	4.04	0.20	10,321	
Panel A	1	1	208	5	7,293	0.06	0.94	9,747	
Panel B	1	1	208	5	7,293	0.06	0.94	9,747	

NOTES:

1. All Calculations use Bussman "Point-To-Point" Method.

2. Variables:  $L$  = Feeder Length (ft)  $C$  = Conductor "C" Value  $M(n) = 1 + (1 + |n|)$   
 $F(n) = (1.73 \times L \times F(n-1)) / (C \times \# \text{ of runs} \times \text{Voltage})$  in Amperes  $F(n) = F(n-1) \times M(n)$

The E.C. shall report any discrepancies to the Engineer.


3. Aluminum Conductors, MC Cables, and Series Rated Panels are not allowed.

The E.C. shall verify the Available Fault Current from the Electrical Utility and shall report the actual Fault Current available to the Engineer if different from above. Fault Currents are based on Utility information or  $\%Z = 1/4$  if none are provided.


The E.C. shall field verify the Feeder Lengths and report any discrepancy to the engineer.

Conductor lengths listed in this table are engineering estimates and are not intended to represent actual lengths for bidding or other calculations. The E.C. shall inform the Engineer immediately if the actual lengths are less than that listed.




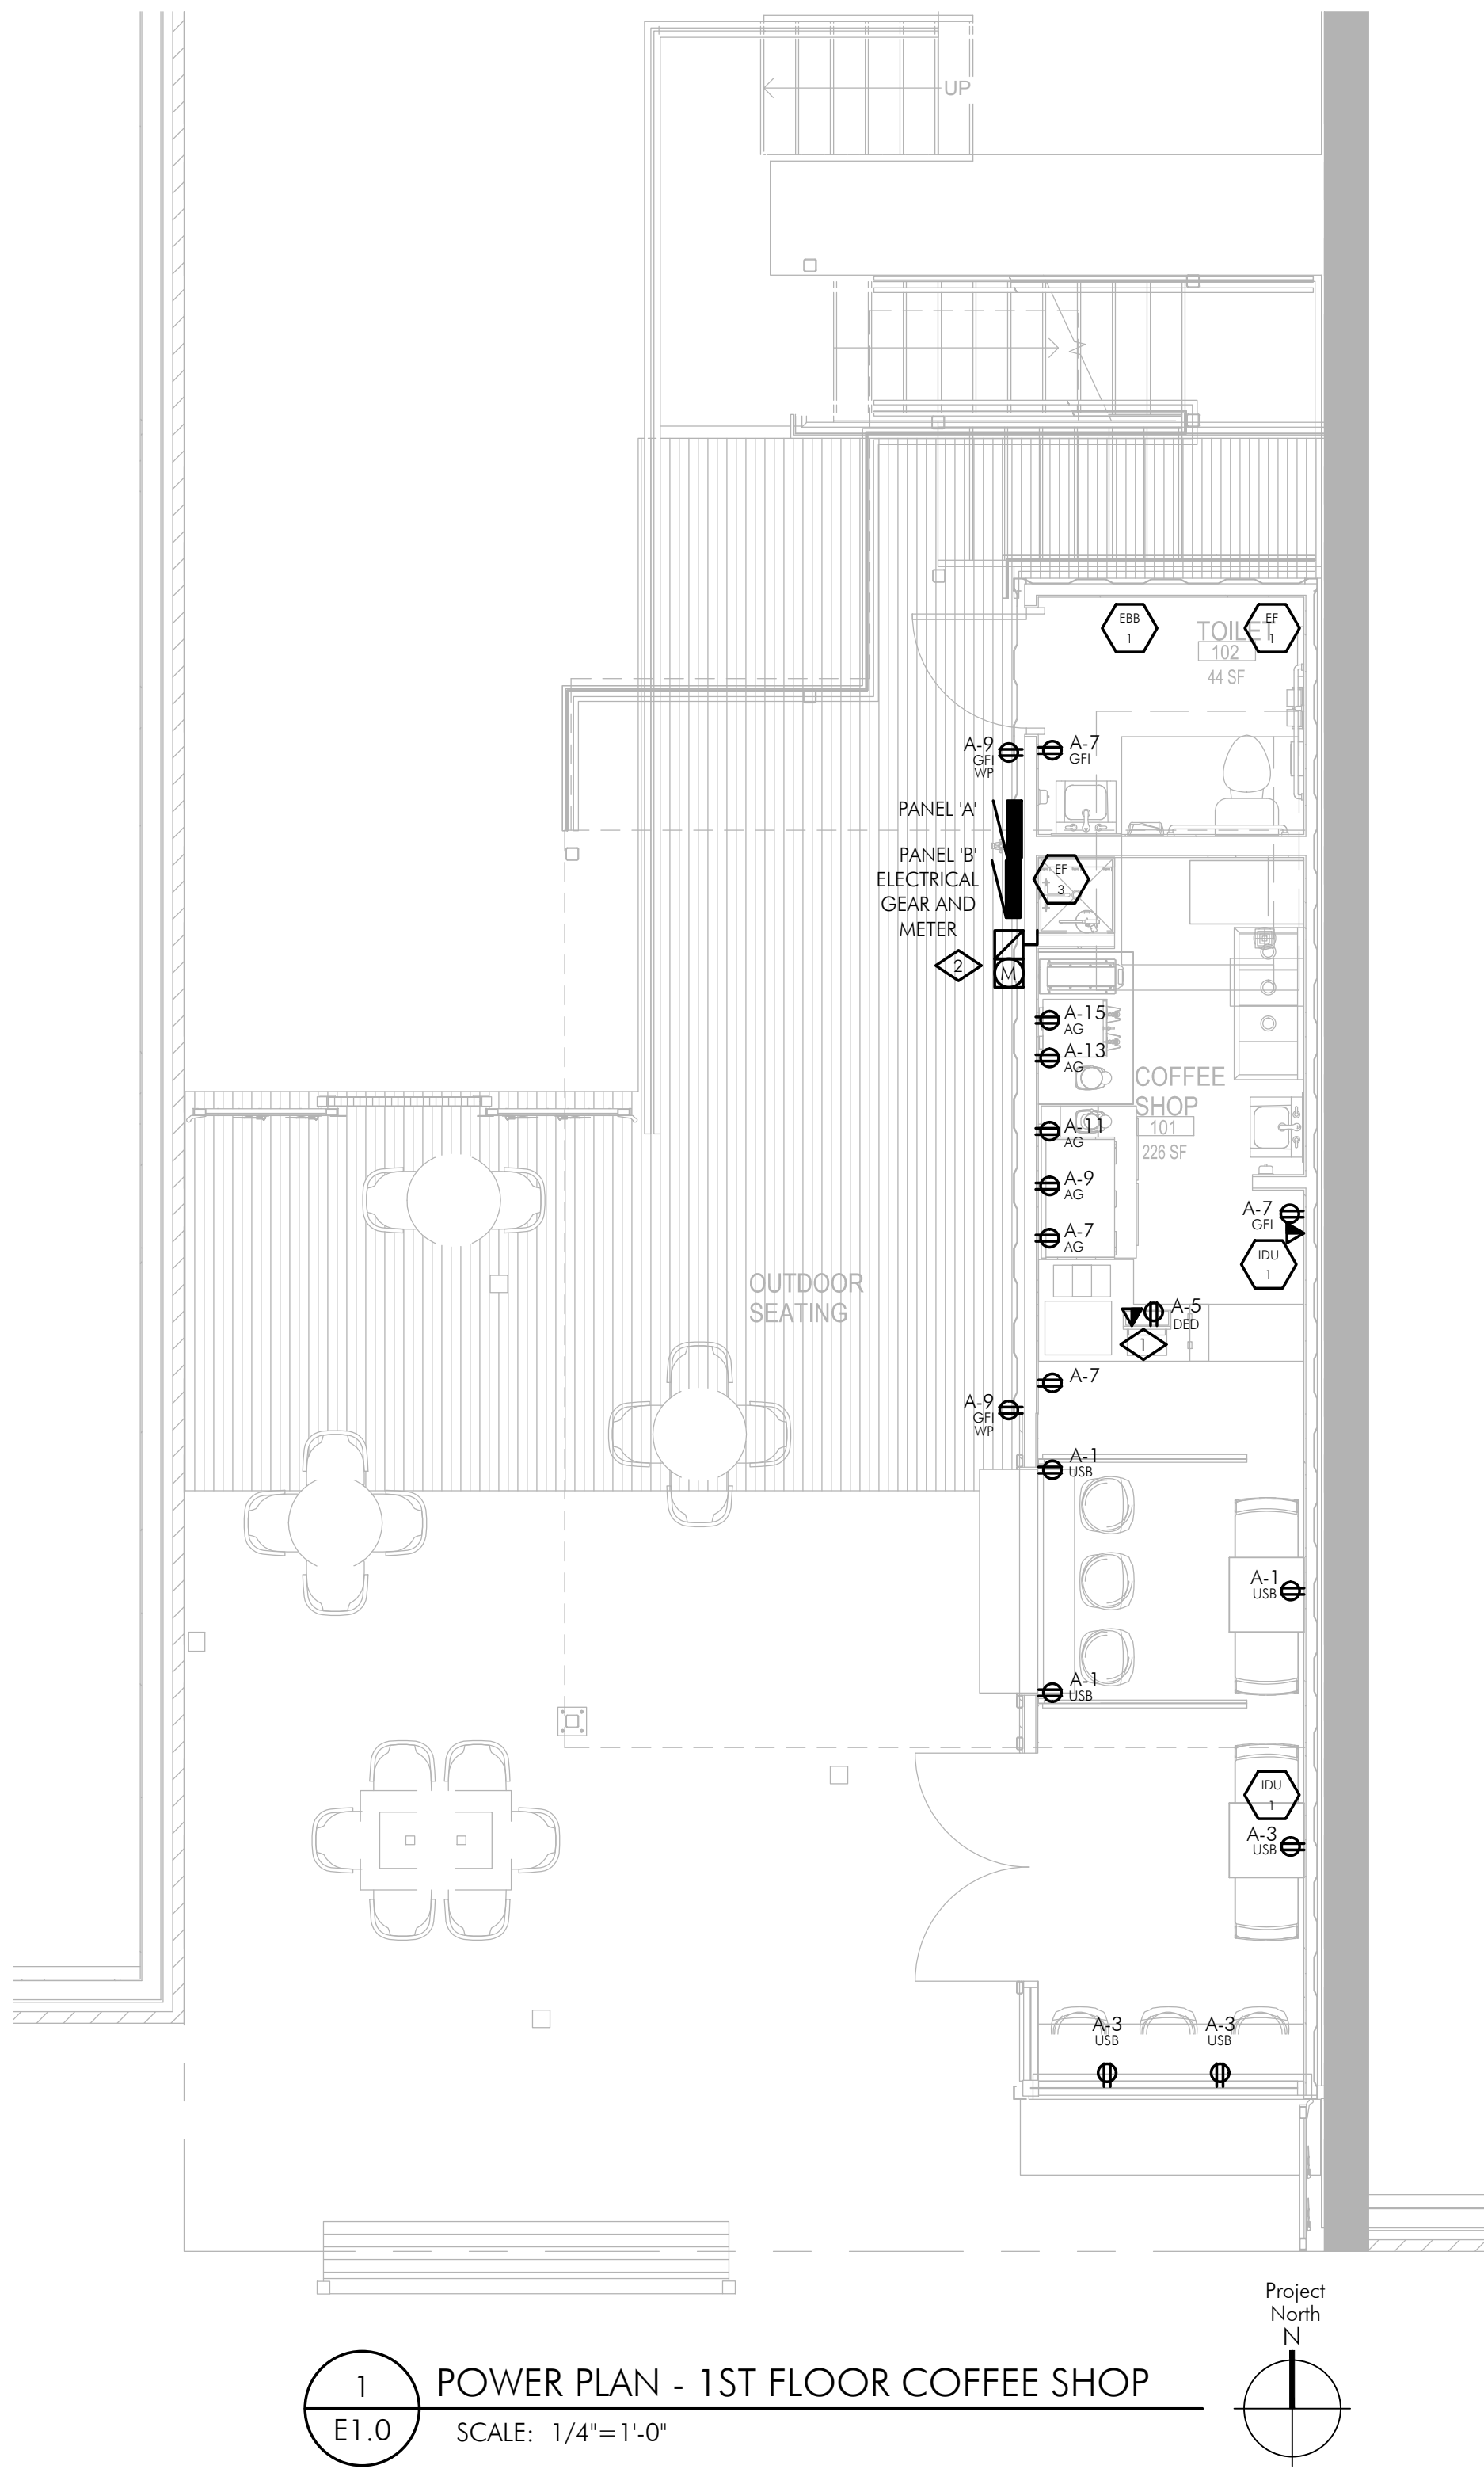

1 POWER PLAN - 1ST FLOOR COFFEE SHOP  
E1.0 SCALE: 1/4"=1'-0"

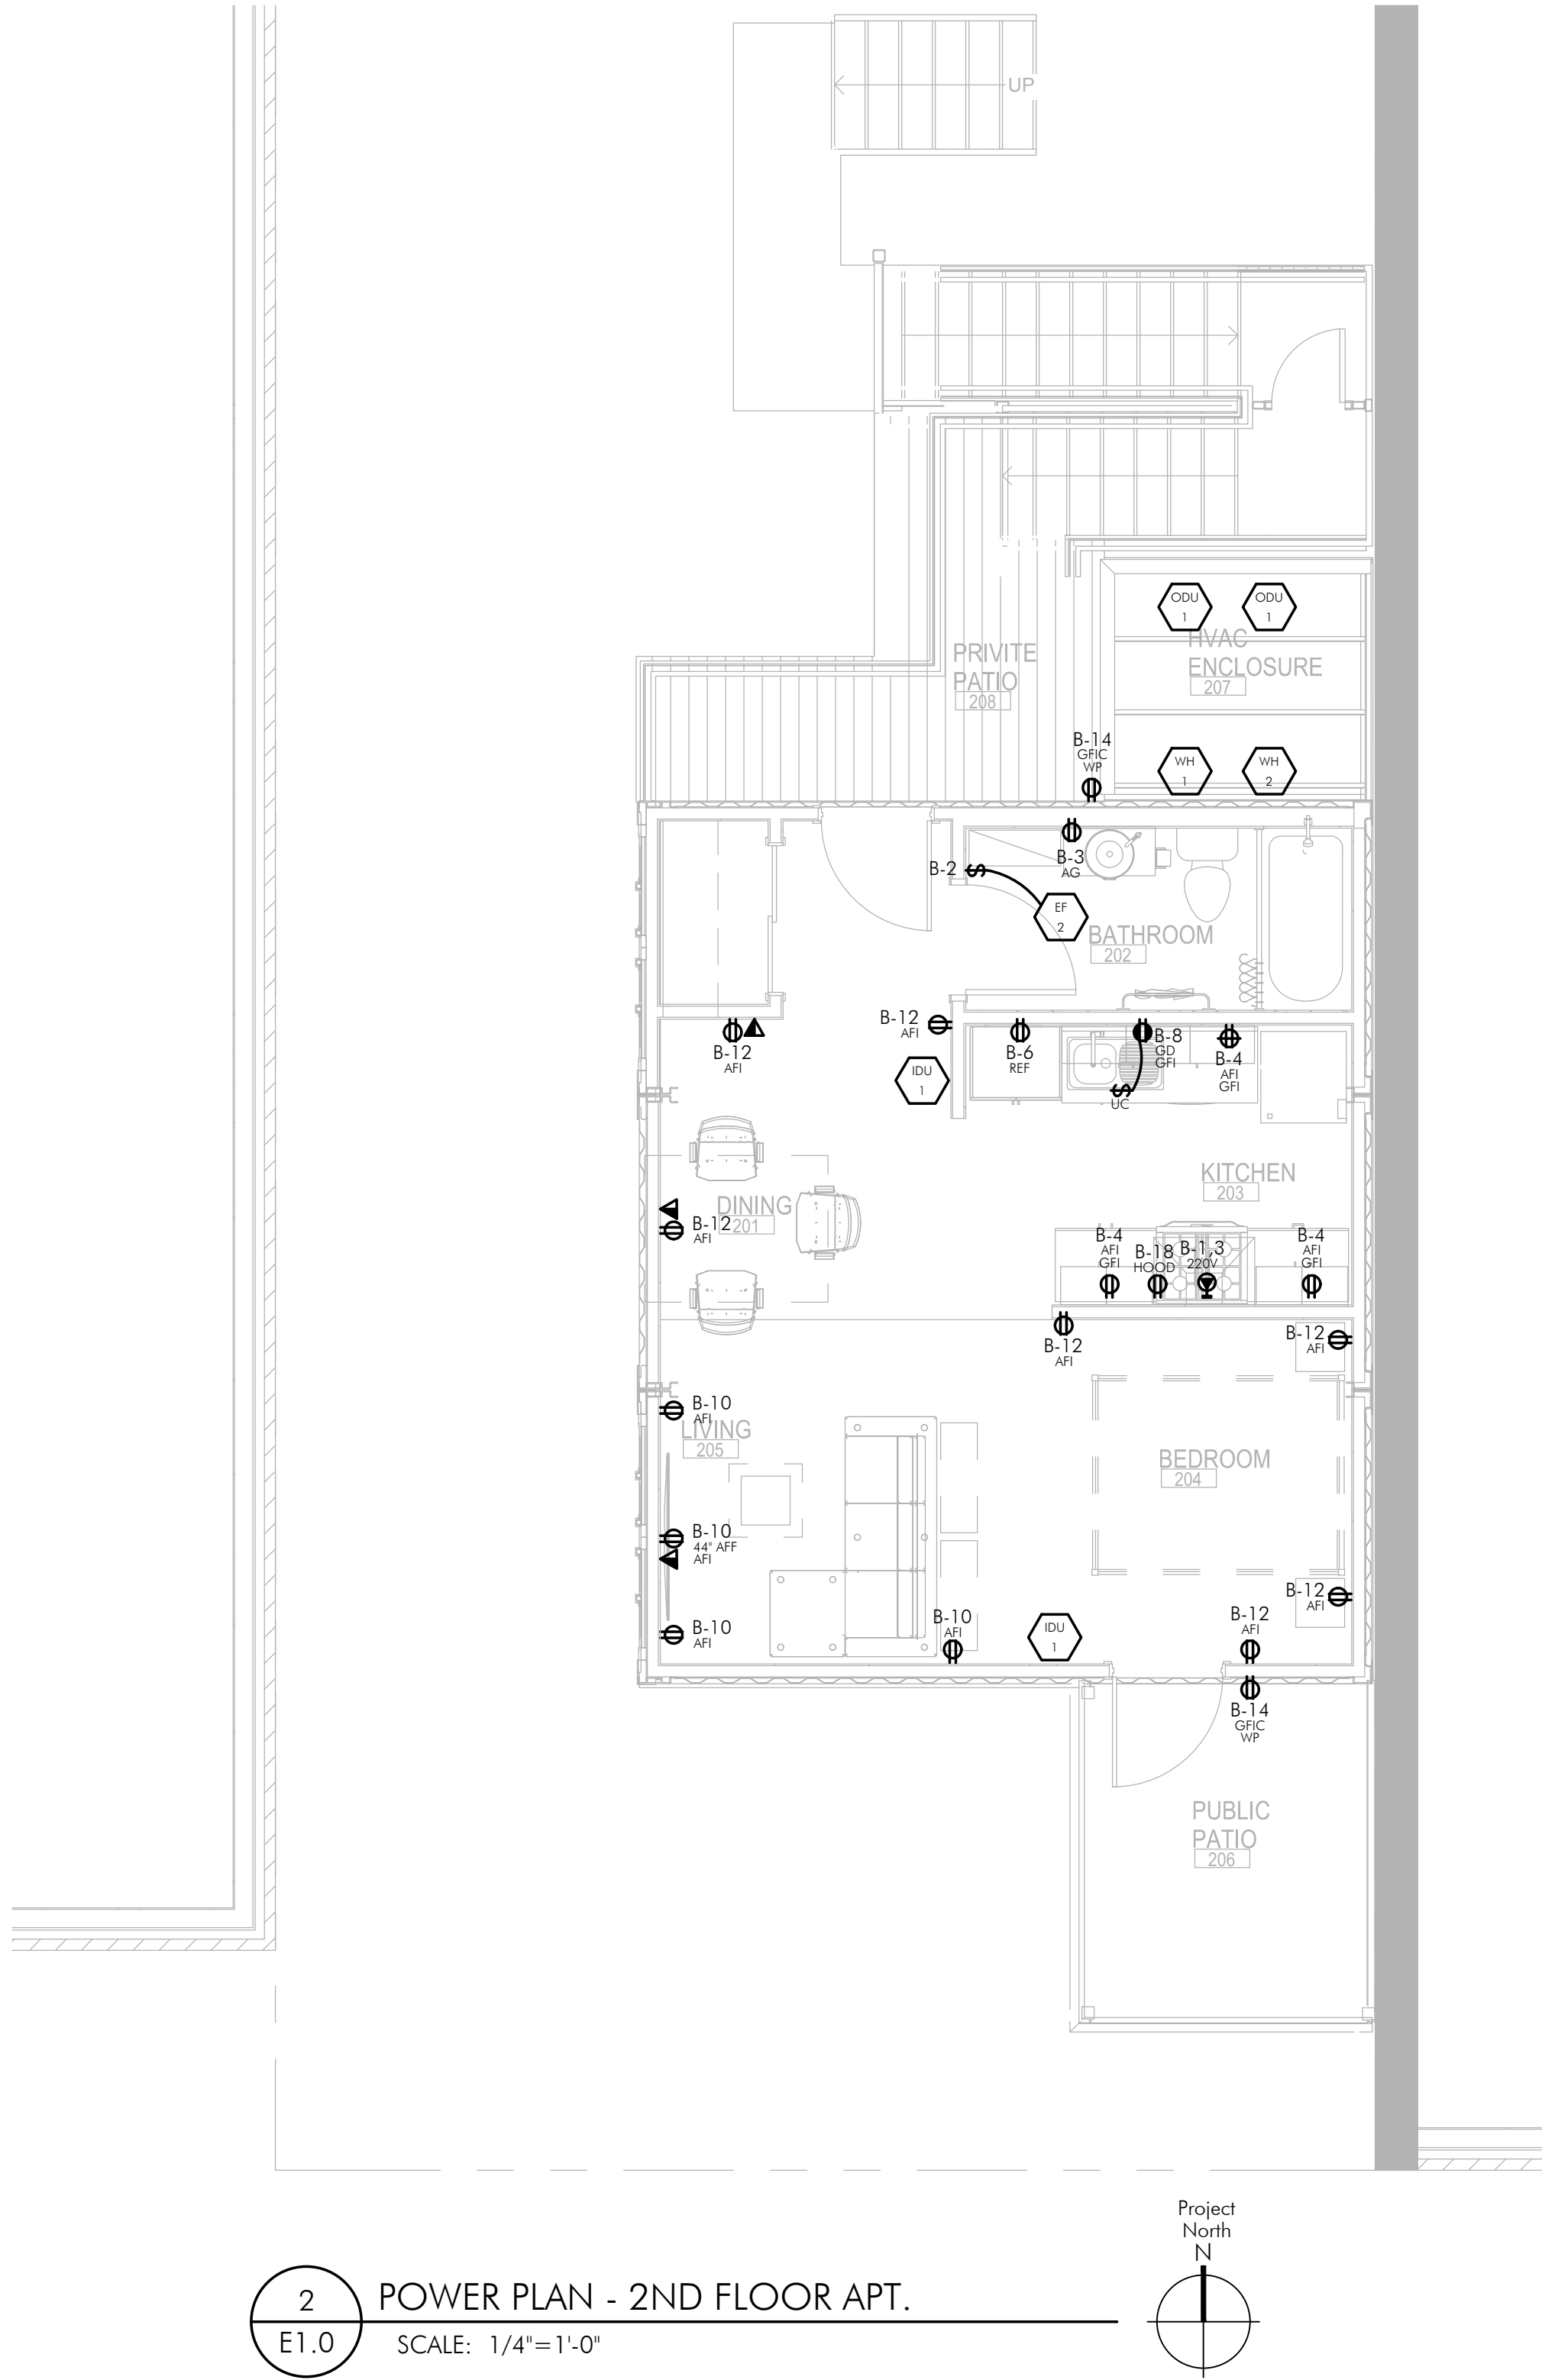

2 POWER PLAN - 2ND FLOOR APT.  
E1.0 SCALE: 1/4"=1'-0"

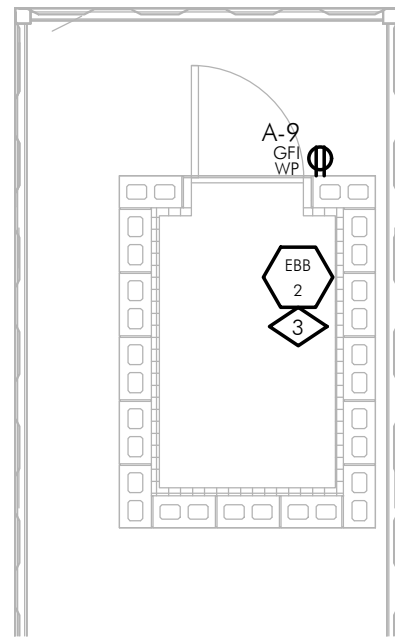

POWER PLAN GENERAL NOTES:

1. PROVIDE OUTLET WITHIN 25' OF EQUIPMENT IN ACCORDANCE WITH NEC 210.63. PROVIDE WEATHERPROOF GFI OUTLET ON ROOFTOPS WITHIN 25' OF ROOFTOP EQUIPMENT.
2. FIELD VERIFY FINAL LOCATION OF ALL EQUIPMENT WITH PROVIDER PRIOR TO ROUGH-IN.
3. ALL RECEPTACLES IN BATHROOMS, KITCHENS, ROOFTOPS, OUTDOORS, AND WITHIN 6FT. OF A SINK SHALL BE GFCI (OR SERVED BY A GFI CIRCUIT BREAKER) PER NEC 210.8(B). THE E.C. SHALL PROVIDE GFCI OUTLETS (OR CIRCUIT BREAKERS) IN ALL LOCATIONS REQUIRED BY THE NEC.
4. ALL RECEPTACLES IN DWELLING UNITS, GUEST ROOMS, AND CHILD CARE FACILITIES (AS SPECIFIED BY ARTICLE 406 OF THE NEC) SHALL BE LISTED AS TAMPER-RESISTANT RECEPTACLES.
5. ARC FAULT PROTECTION - ALL 120V, SINGLE-PHASE, 15A AND 20A BRANCH CIRCUITS SUPPLYING OUTLETS OR DEVICES INSTALLED IN DWELLING UNIT KITCHENS, FAMILY ROOMS, DINING ROOMS, LIVING ROOMS, PARLORS, LIBRARIES, DEN'S, BEDROOMS, SUNROOMS, RECREATION ROOMS, CLOSETS, HALLWAYS, LAUNDRY AREAS, OR SIMILAR ROOMS OR AREAS SHALL BE PROTECTED BY AN AFCI RECEPTACLE OR AFC CIRCUIT BREAKER, NEC 210.12
6. PROVIDE CONNECTION TO TENANT SIGN. FIELD VERIFY ELECTRICAL REQUIREMENTS AND FINAL LOCATION WITH PROVIDER, TENANT AND LANDLORD. PROVIDE PHOTOCELL ON/TIMECLOCK OFF CONTROLS. PROVIDE ALL COMPONENTS REQUIRED FOR A COMPLETE INSTALLATION.
7. NUMBERS NEXT TO DEVICES REFER TO CIRCUIT DESIGNATION IN UNIT PANEL UNLESS NOTED.
8. ALL TELE/DATA LOCATIONS SHALL INCLUDE 4" SQUARE J-BOX AND 3/4" CONDUIT TO CEILING SPACE. ALL TELEPHONE/DATA CABLE IS TO BE PLENUM RATED WIRE OR SHALL BE INSTALLED IN CONDUIT ABOVE CEILING OR IN WALLS.
9. PROVIDE ALL DEMOLITION WORK AS REQUIRED TO ACCOMMODATE THE NEW WORK AS INDICATED ON THE ELECTRICAL PLANS. FIELD VERIFY EXISTING CONDITIONS. PROVIDE ANY ADDITIONAL WORK NECESSARY AS REQUIRED TO PRESERVE EXISTING DEVICES AND BRANCH CIRCUIT COMPONENTS TO REMAIN. REFER TO THE ARCHITECTURAL PLANS FOR DEMOLITION SCOPE OF WORK AND VISIT THE SITE PRIOR TO BID TO DETERMINE THE ELECTRICAL SCOPE OF WORK REQUIRED.

POWER PLAN KEYED NOTES:

1. CASH WRAP/POS - PROVIDE OUTLETS FOR POWER AND DATA IN MILLWORK AS REQUIRED. PROVIDE SEPARATE CIRCUIT WITH DEDICATED GROUND AND NEUTRAL CONDUCTOR. FIELD VERIFY CONDUIT ROUTING AND J-BOX LOCATIONS WITH MILLWORK PROVIDER AND TENANT PRIOR TO ANY ROUGH-IN. FIELD VERIFY DATA J-BOX AND RACEWAY REQUIREMENTS WITH TENANT IT REPRESENTATIVE.
2. CONTRACTOR TO FIELD VERIFY FINAL LOCATION AND DISTANCE FROM PANELS TO TRANSFORMER PRIOR TO ANY WORK. NOTIFY THE ENGINEER IMMEDIATELY OF ANY DISCREPANCY.
3. PROVIDE BASEBOARD HEATING UNIT FOR FREEZE PROTECTION OF WATER ENTRY ROOM. FIELD VERIFY FINAL LOCATION AND FIT PRIOR TO ANY WORK.



CRAIG A. SLOCUM, ARCHITECT


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CRAIG A. SLOCUM, ARCHITECT



PROJECT KVA 19-121	DATE 02/10/2020
DRAWN TMK	CHECKED JPT

REVISED

SHEET TITLE

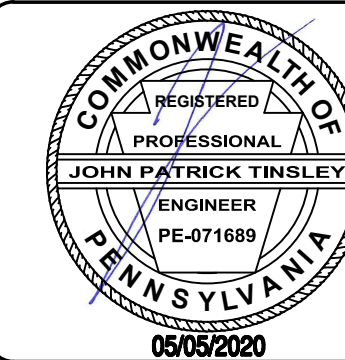
ELECTRICAL  
PLANS - POWER

SHEET



E1.0

ORIGINAL SHEET SIZE  
24" x 36"




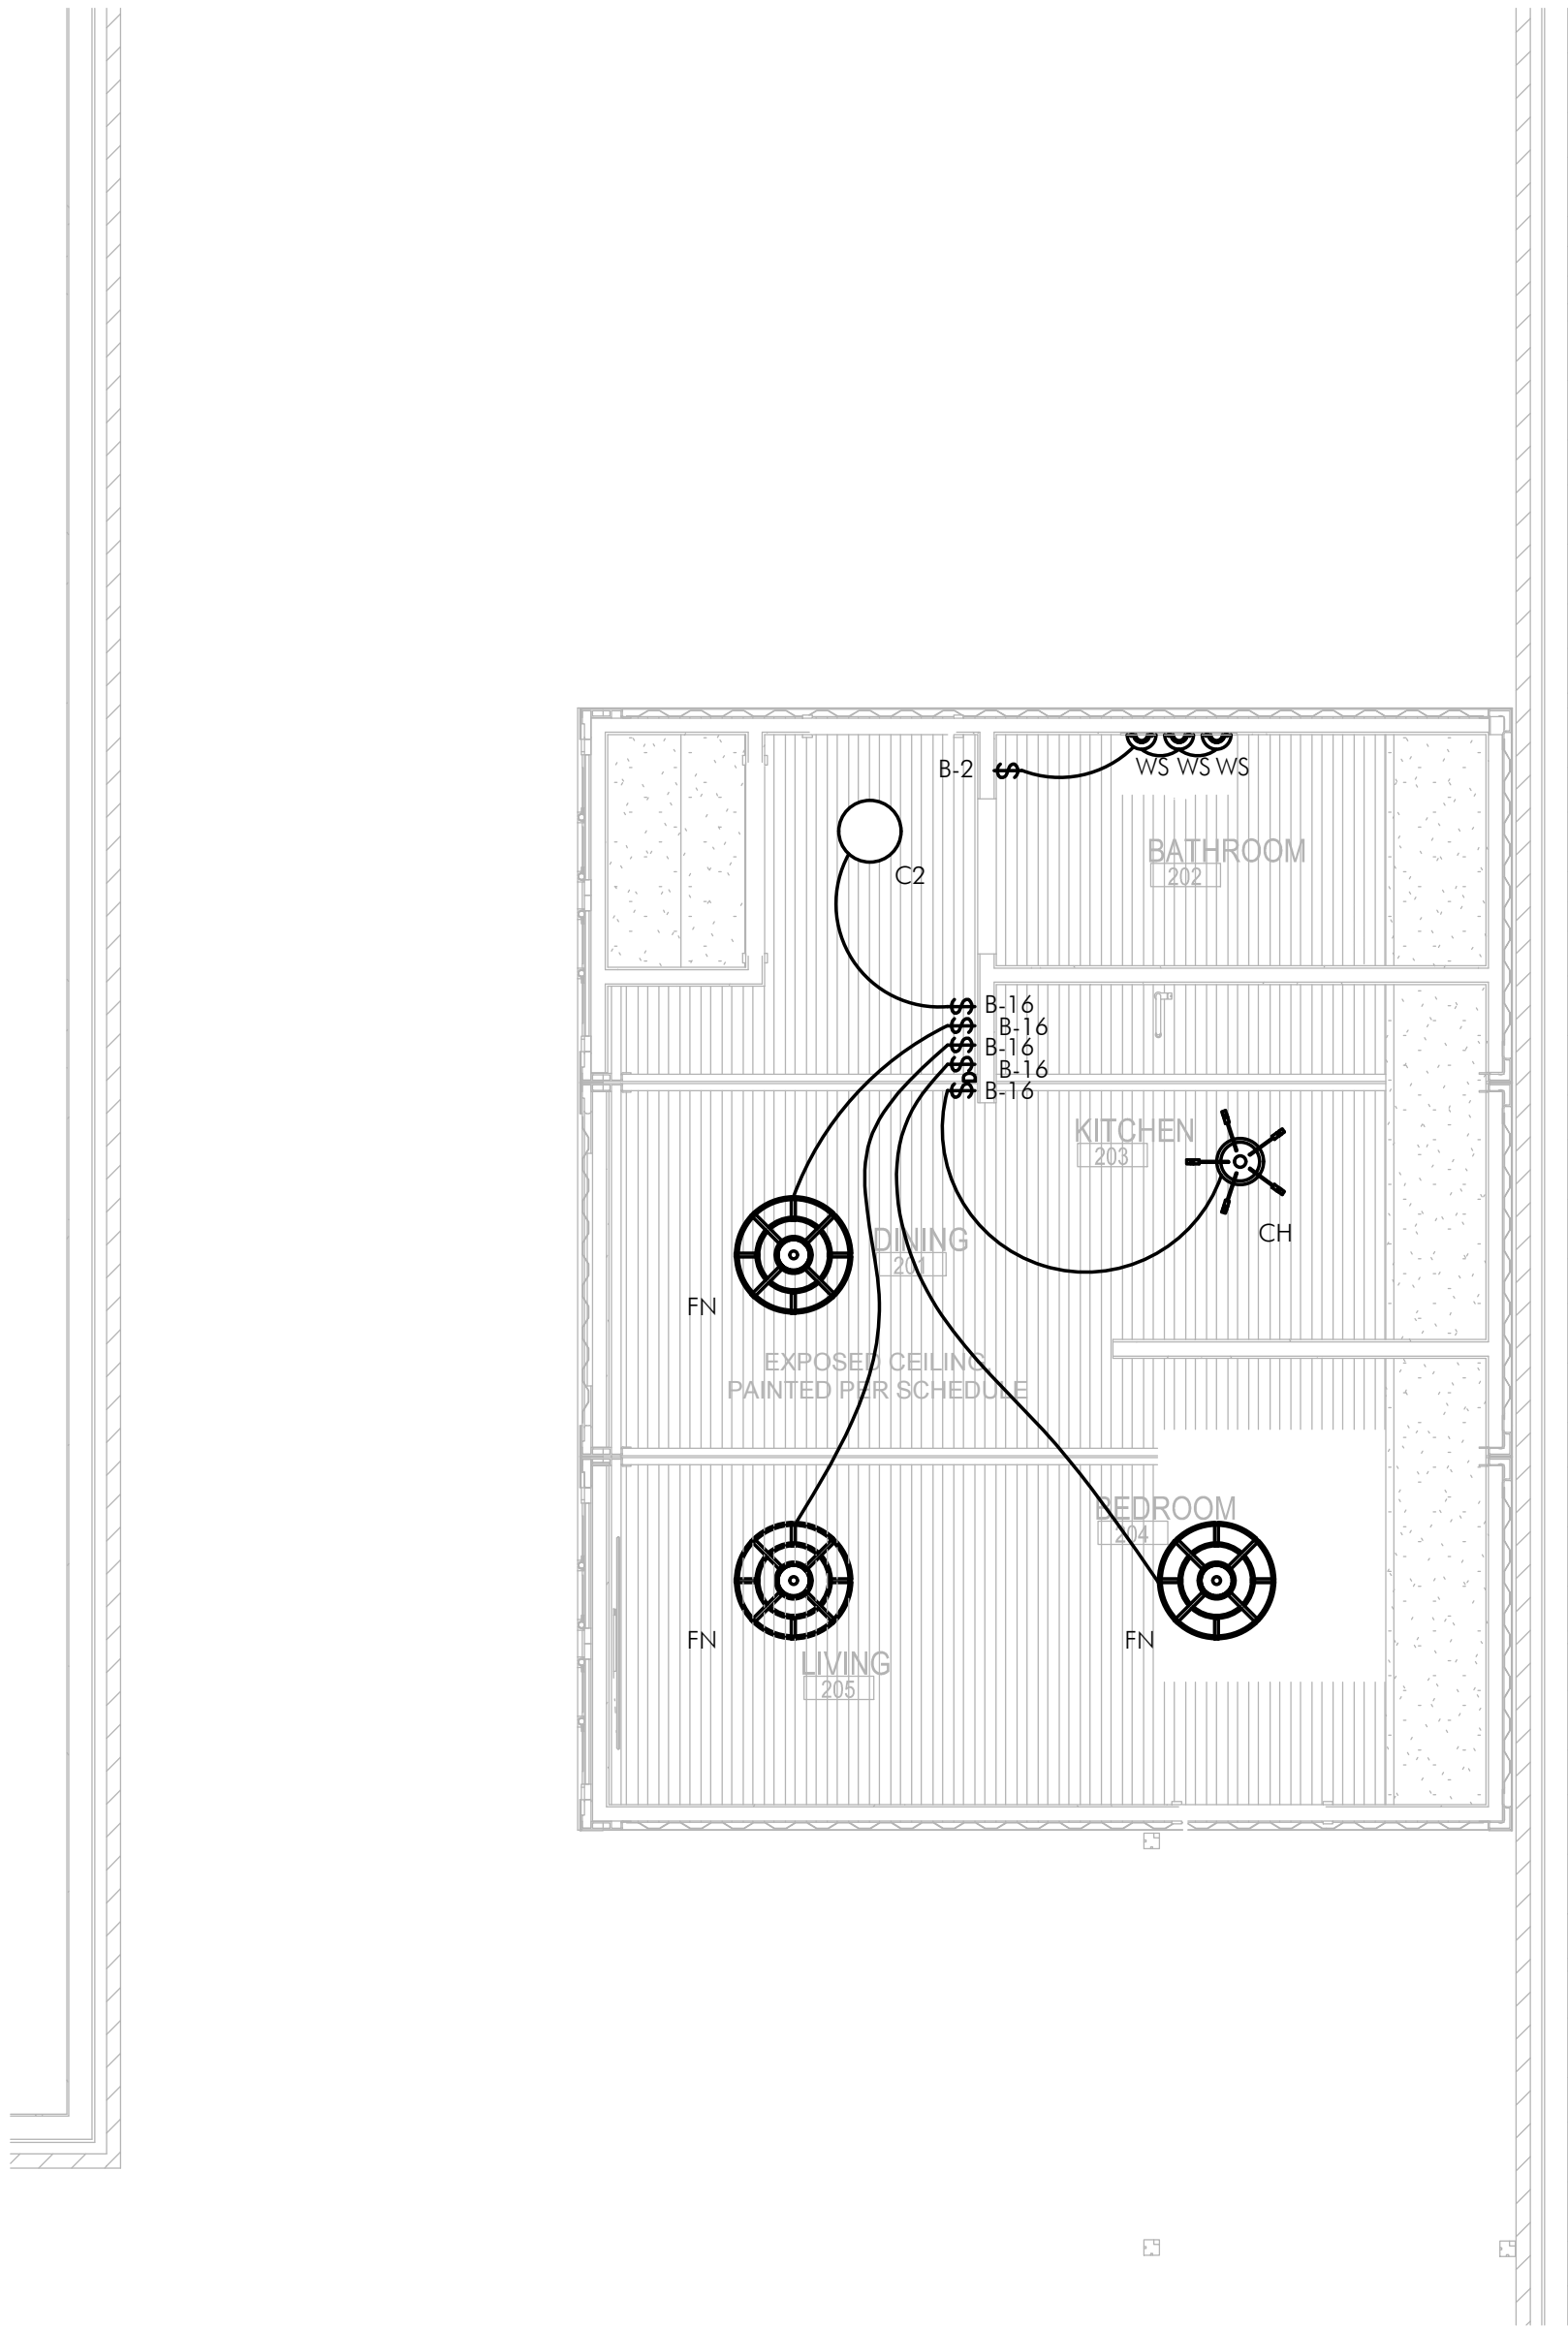

1  
E2.0  
LIGHTING PLAN - 2ND FLOOR APT.  
SCALE: 1/4"=1'-0"

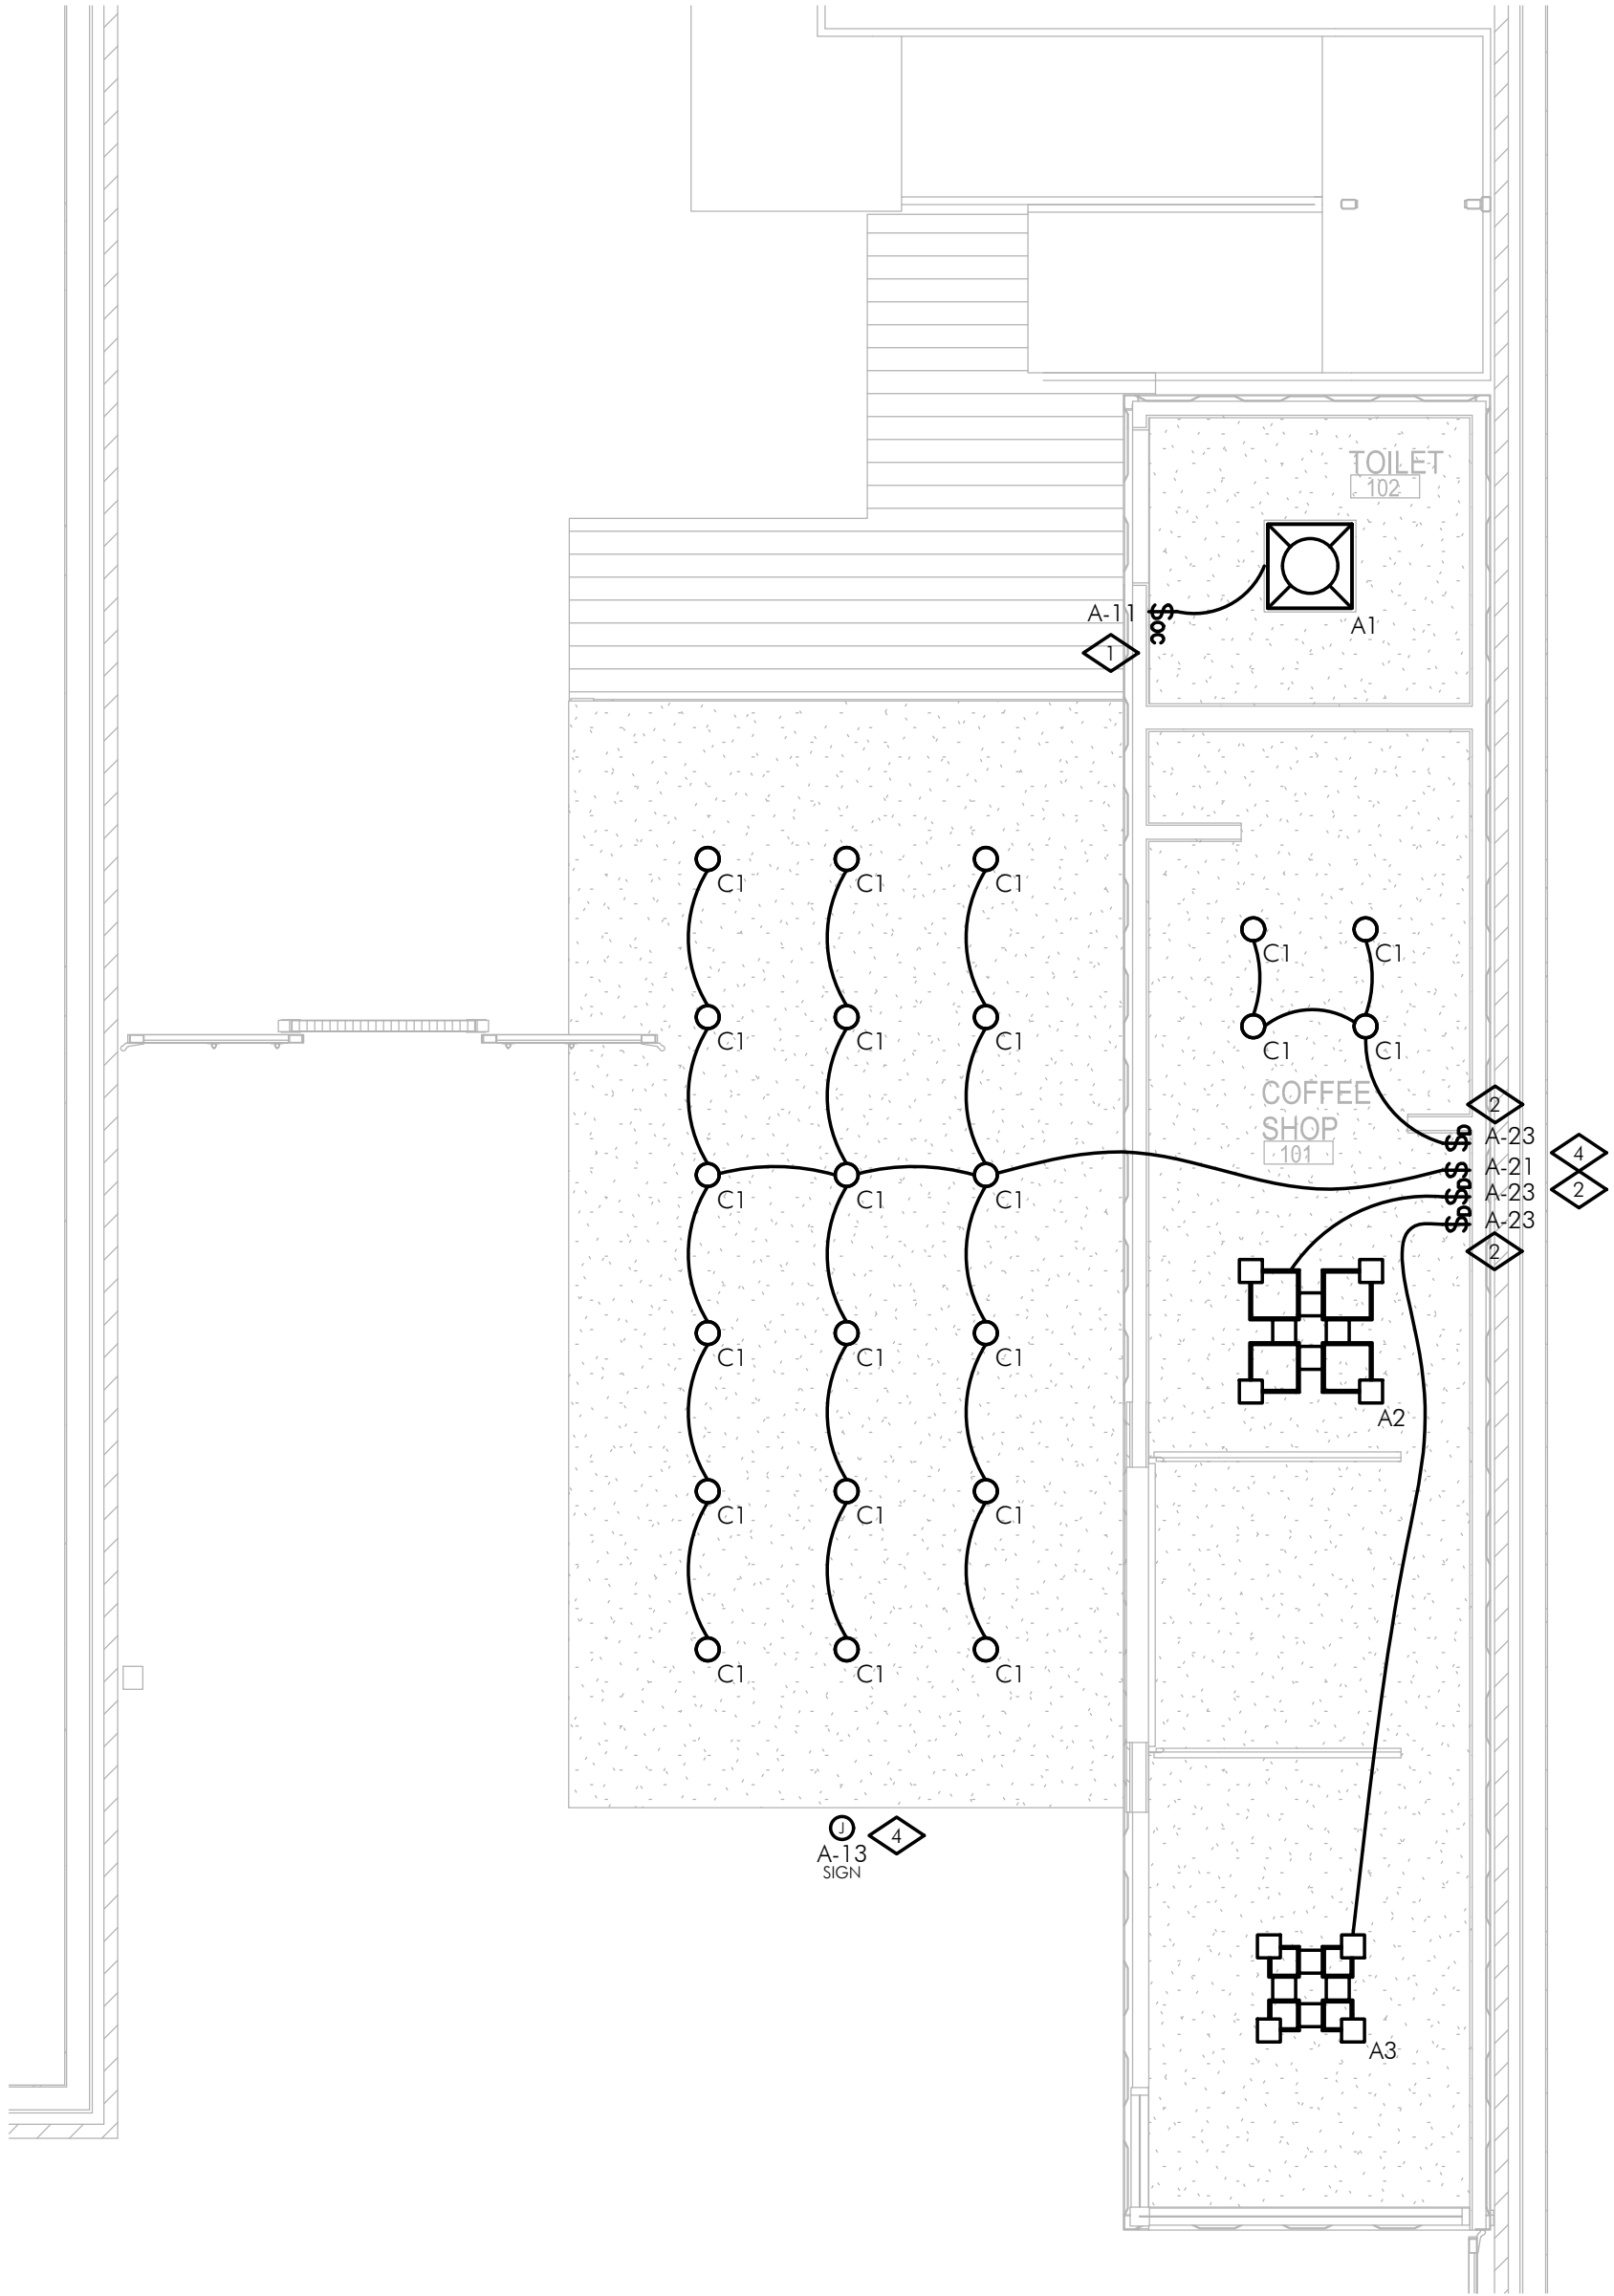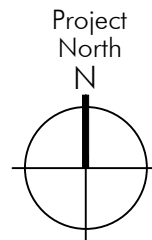

2  
E2.0  
LIGHTING PLAN - 1ST FLOOR COFFEE SHOP  
SCALE: 1/4"=1'-0"

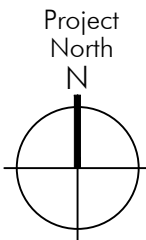

LIGHTING PLAN GENERAL NOTES:


- CONNECT EGRESS LIGHTING FIXTURES AND EXIT SIGNS TO AREA LIGHTING CIRCUIT AHEAD OF ANY SWITCH PER NEC 700-12(F) INCLUDING ANY NIGHT LIGHTS. FIXTURES SHOWN SHADED OR LABELED ARE EMERGENCY EGRESS (EM) WITH BATTERY PACK, NIGHT LIGHT (NL) OR BOTH (EM/NL). REMOVE ANY HOUSE PANEL CIRCUITS SERVING EXISTING EMERGENCY AND EXIT LIGHTS AND RECONNECT TO THE TENANT PANEL.
- PROVIDE OUTLET IN ACCESSIBLE LOCATION AT TENANT ENTRANCE FOR SIGN PER NEC 600-5.
- NUMBERS NEXT TO DEVICES REFER TO CIRCUIT DESIGNATION IN UNIT PANEL UNLESS NOTED.

LIGHTING PLAN KEYED NOTES:

- WALLBOX OCCUPANCY SENSOR - PROVIDE DUAL TECHNOLOGY COOPER GREENGATE ONW-D-1001-MV OR EQUAL.
- WALLBOX DIMMER SWITCH - PROVIDE COOPER - EATON SF10P-* OR EQUAL BY COOPER RATED FOR CONNECTED LOAD TYPE AND WATTAGE.
- TENANT SIGN - PROVIDE DEDICATED CIRCUIT AND FINAL CONNECTIONS AS REQUIRED. FIELD VERIFY ELECTRICAL REQUIREMENTS AND FINAL LOCATION WITH PROVIDER, TENANT AND LANDLORD. PROVIDE PHOTOCELL ON/TIMECLOCK OFF CONTROLS.
- EXTERIOR LIGHTING CONTROLS - PROVIDE PHOTOCELL ON/TIMECLOCK OFF CONTROLS AND MULTIPOLAR LIGHTING CONTACTOR, PHOTOCELL ON ROOF AND PROGRAMMABLE TIME CLOCK AS REQUIRED. FIELD VERIFY REQUIREMENTS WITH TENANT AND LANDLORD.

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SHEET TITLE  
**ELECTRICAL  
PLANS - LIGHTING**

SHEET

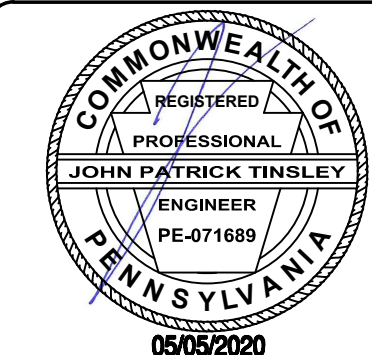**E2.0**  
ORIGINAL SHEET SIZE  
24" x 36"

